CLIENT

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VANCOUVER, BC CANADA V6T 2A3

PROJECT NAME TRIUMF - IAMI

CIVIL WORKS FOR NEW

INSTITUTE FOR ADVANCED MEDICAL ISOTOPES

(IAMI) BUILDING

McELHANNEY PROJECT 2111-05236-00


OTHER REFERENCE A49 189-00175-00

ISSUED FOR DEVELOPMENT PERMIT

DECEMBER 03, 2018

## DRAWING INDEX:

- COVER SHEET, C-000
- SITE PLAN, C-101
- SURVEY PLAN, C-201 AND C-202

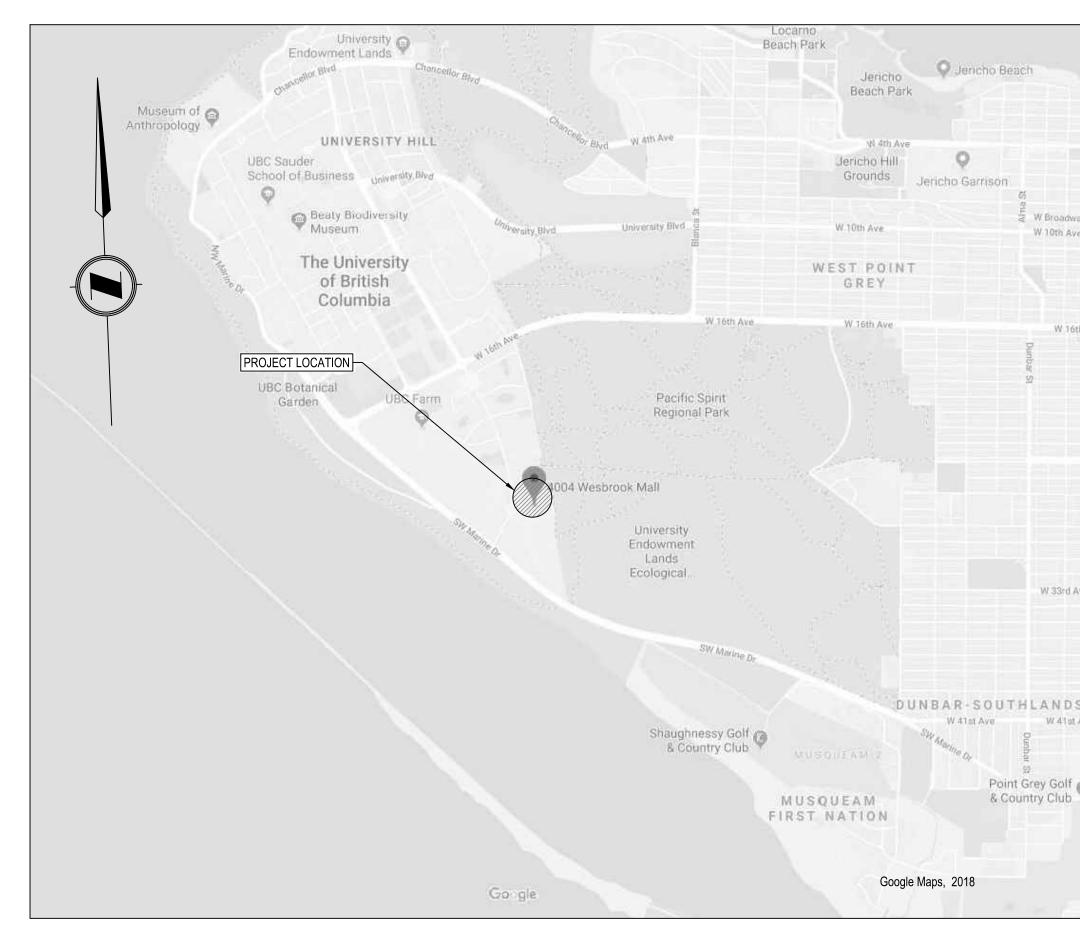

LOCATION MAP




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03 December 2018

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MCSL PROJECT No.: 2111-05236-01

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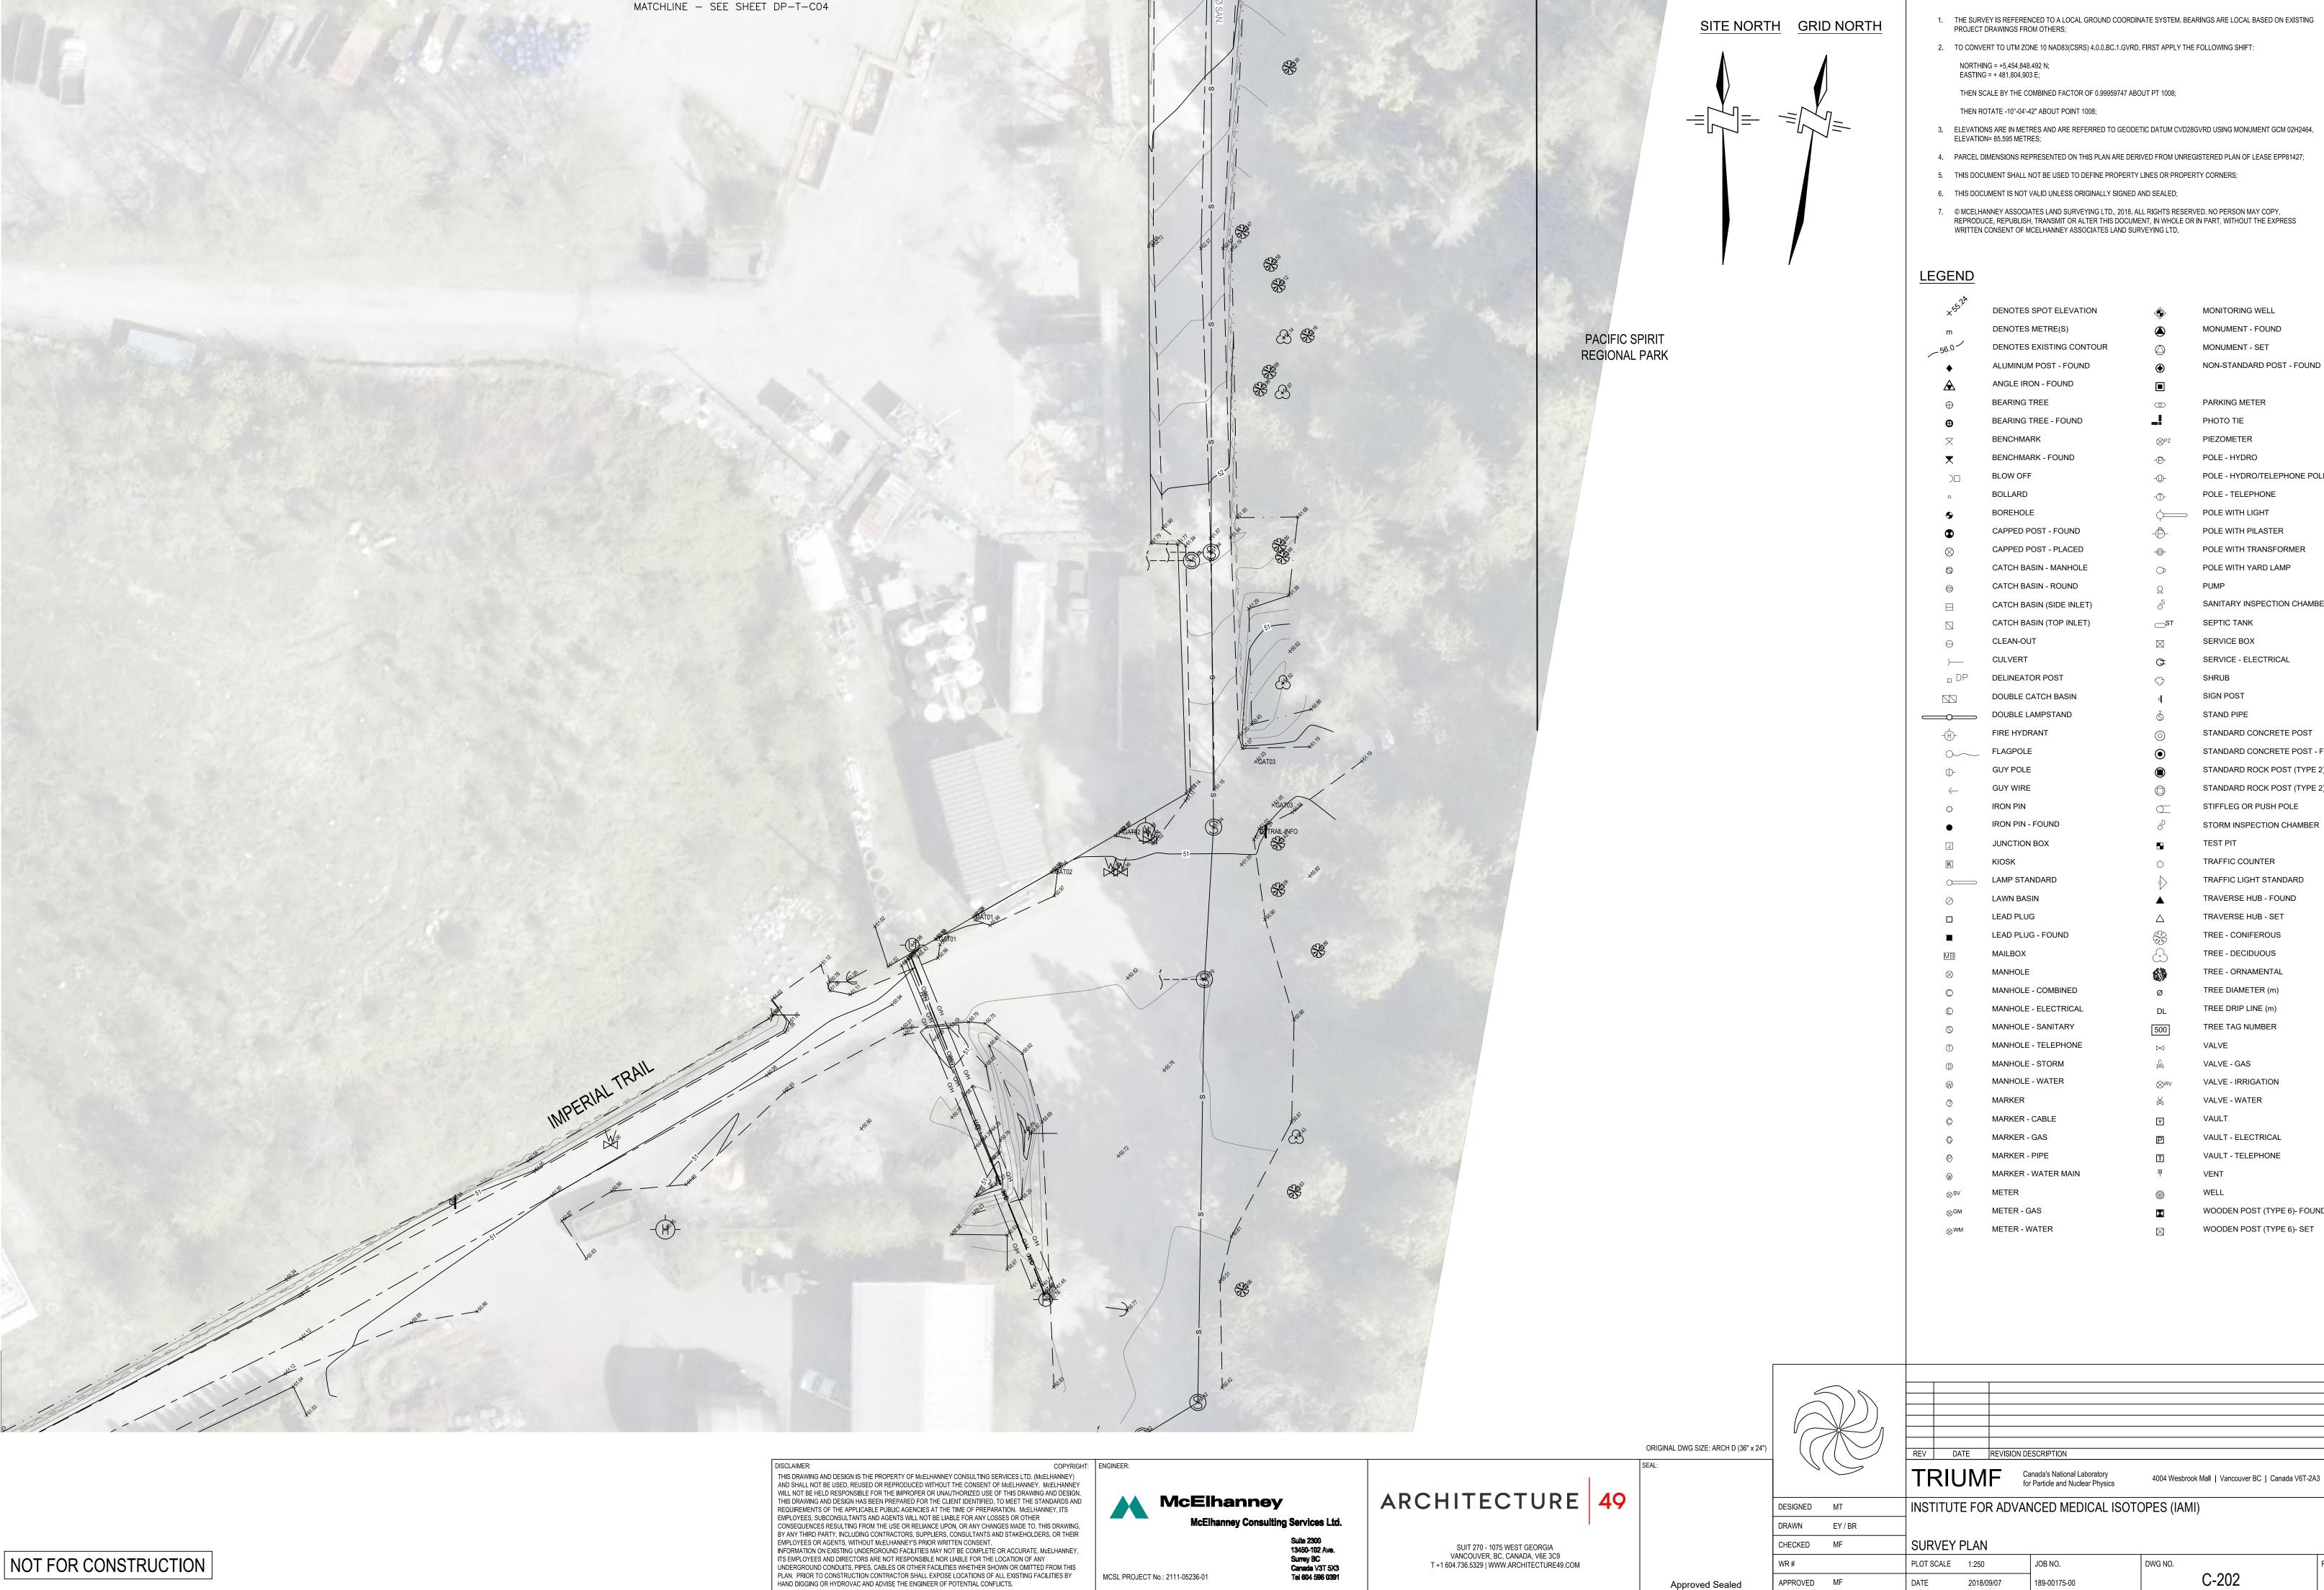
SURVEY PLAN

PLOT SCALE 1:250 JOB NO.

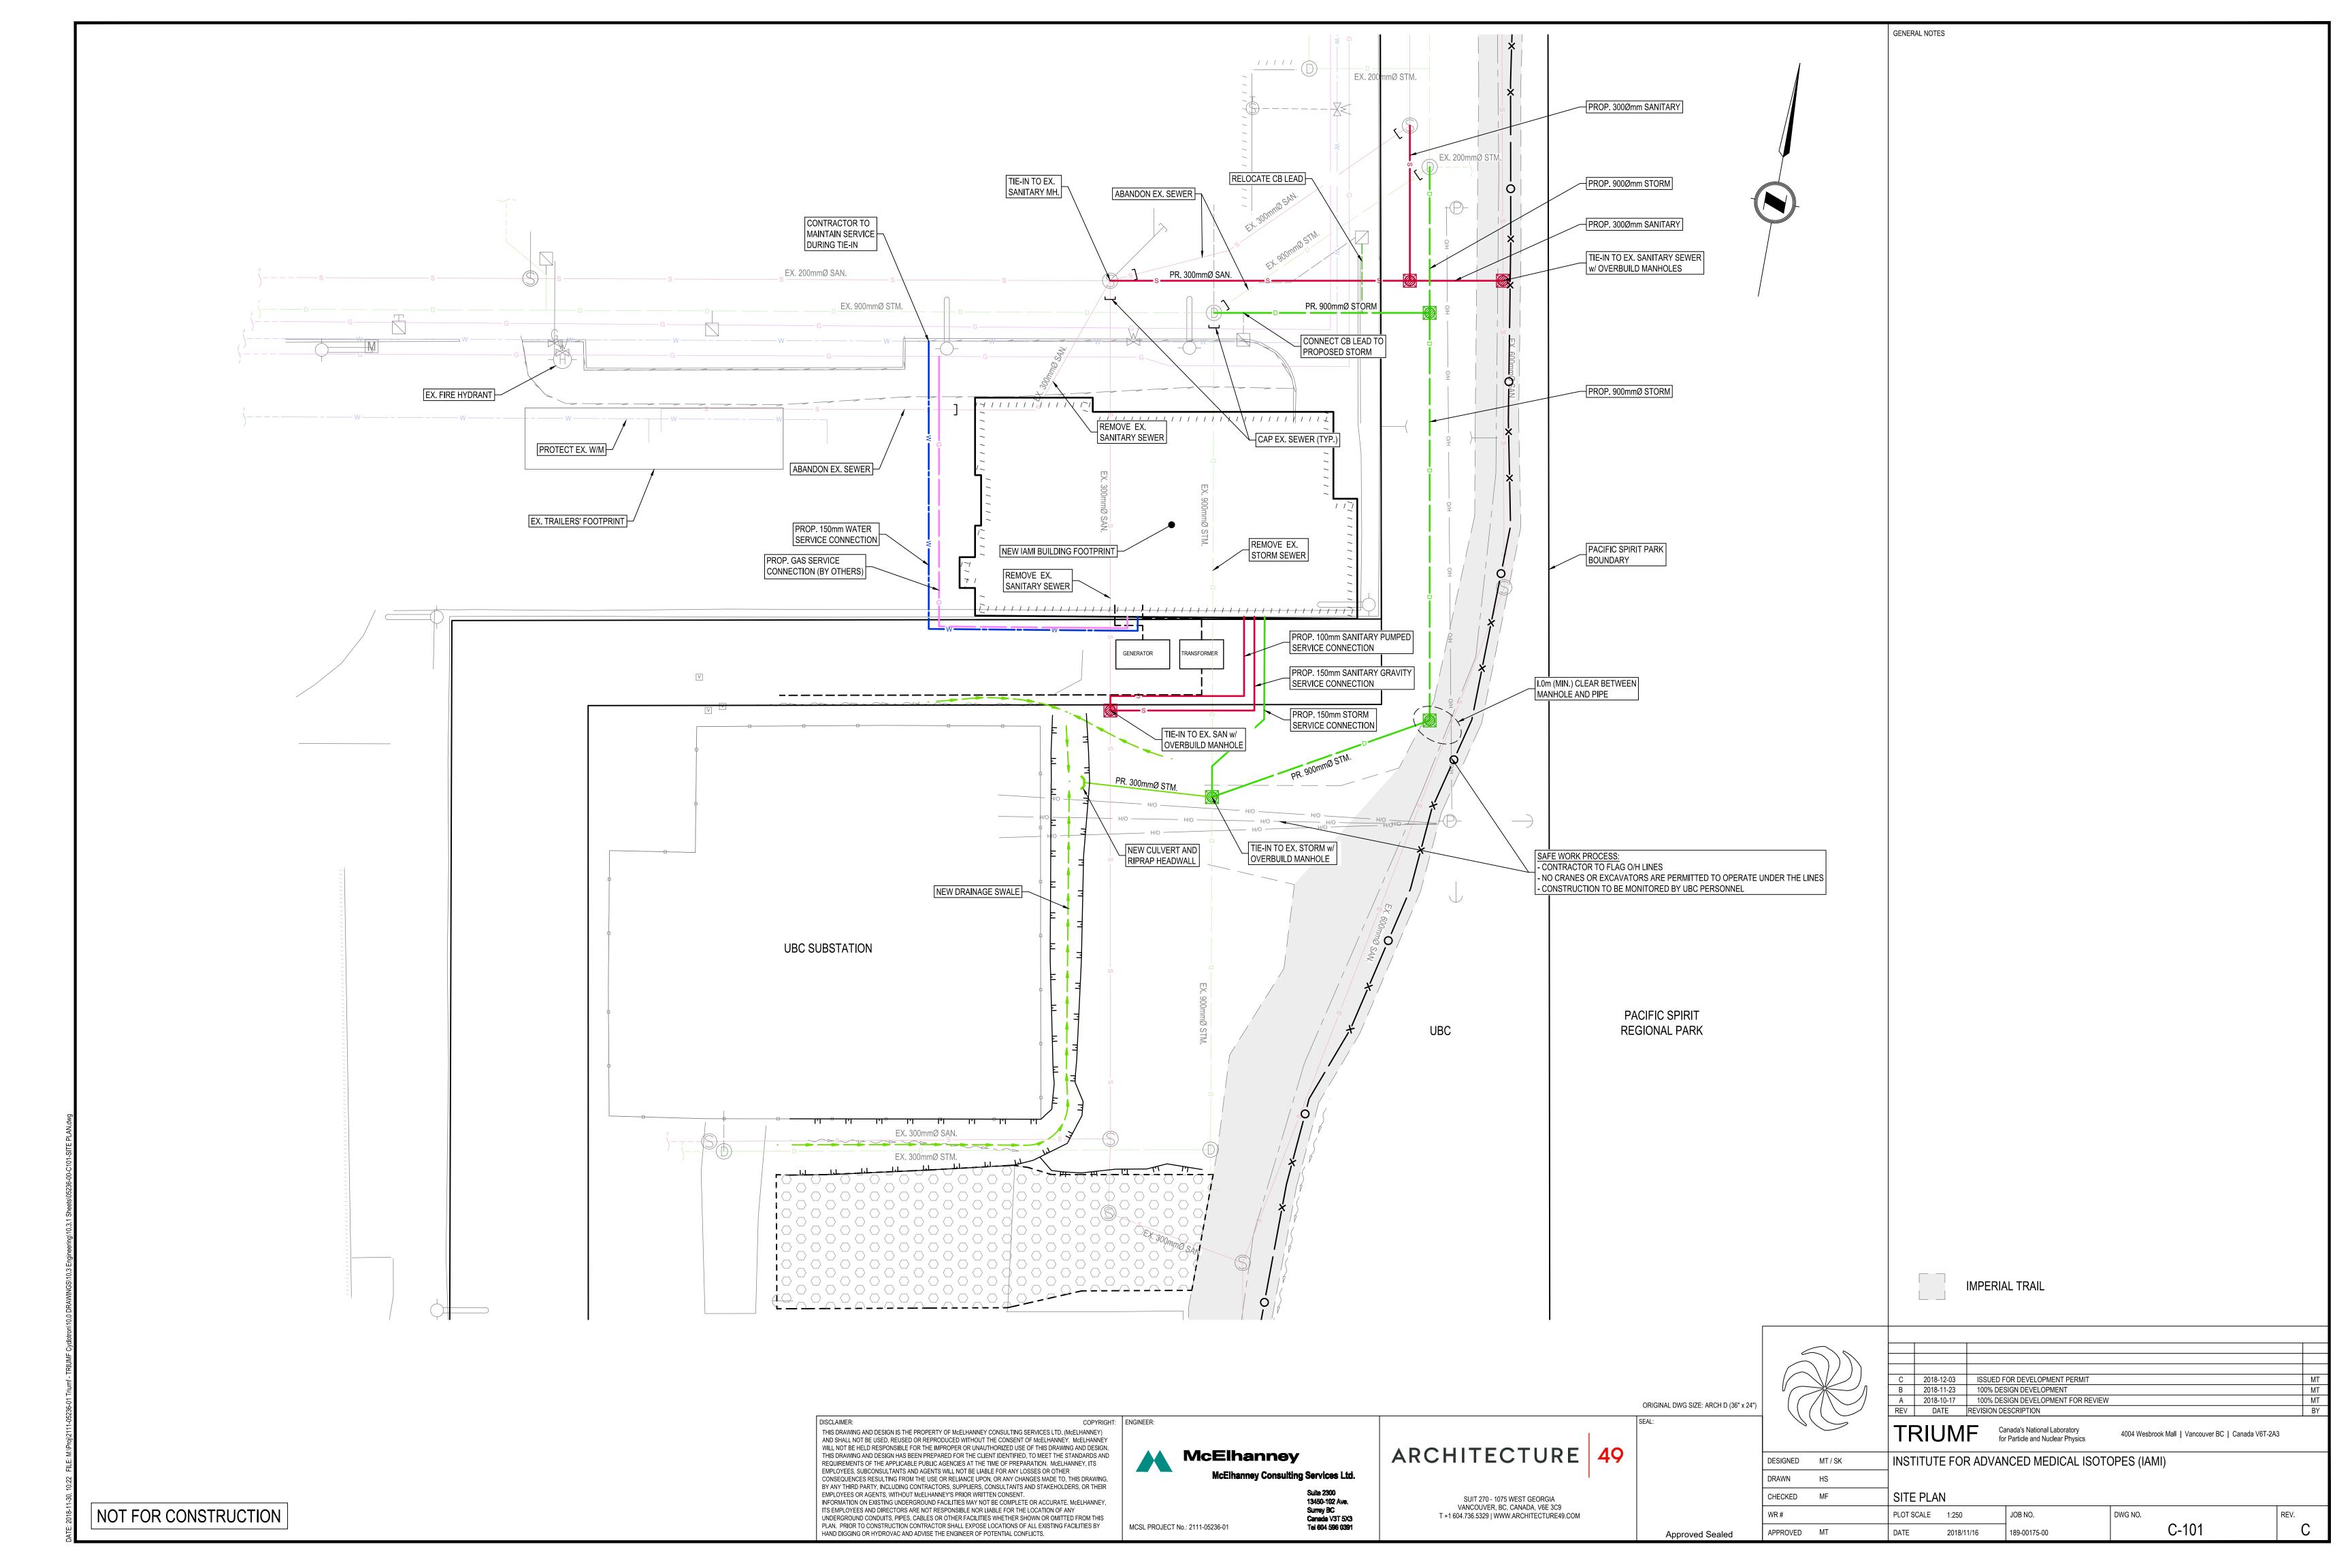APPROVED MF

DATE 2018/09/07 189-00175-00 C-201

GENERAL NOTES



MCSL PROJECT No.: 2111-05236-01

GENERAL NOTES

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| ×,2,         | DENOTES SPOT ELEVATION   |                    | MONITORING WELL                     |
|--------------|--------------------------|--------------------|-------------------------------------|
| m            | DENOTES METRE(S)         |                    | MONUMENT - FOUND                    |
| _56.0        | DENOTES EXISTING CONTOUR | $\bigcirc$         | MONUMENT - SET                      |
| •            | ALUMINUM POST - FOUND    | •                  | NON-STANDARD POST - FOUND           |
| $\triangle$  | ANGLE IRON - FOUND       |                    |                                     |
| $\oplus$     | BEARING TREE             | <b>©</b>           | PARKING METER                       |
| <b>⊕</b>     | BEARING TREE - FOUND     | _!                 | PHOTO TIE                           |
| $\times$     | BENCHMARK                | ⊗PZ                | PIEZOMETER                          |
| ▼            | BENCHMARK - FOUND        | - <b>D</b> -       | POLE - HYDRO                        |
| )            | BLOW OFF                 | -0-                | POLE - HYDRO/TELEPHONE POLE         |
| 0            | BOLLARD                  |                    | POLE - TELEPHONE                    |
| •            | BOREHOLE                 | <u></u>            | POLE WITH LIGHT                     |
| •            | CAPPED POST - FOUND      | - <del>-</del> -   | POLE WITH PILASTER                  |
| $\otimes$    | CAPPED POST - PLACED     |                    | POLE WITH TRANSFORMER               |
|              | CATCH BASIN - MANHOLE    | $\bigcirc$         | POLE WITH YARD LAMP                 |
|              | CATCH BASIN - ROUND      | 2                  | PUMP                                |
|              | CATCH BASIN (SIDE INLET) | .S                 | SANITARY INSPECTION CHAMBER         |
|              | CATCH BASIN (TOP INLET)  | ST                 | SEPTIC TANK                         |
| $\ominus$    | CLEAN-OUT                | $\boxtimes$        | SERVICE BOX                         |
| )—           | CULVERT                  | <u> </u>           | SERVICE - ELECTRICAL                |
| DP           | DELINEATOR POST          | φ                  | SHRUB                               |
|              | DOUBLE CATCH BASIN       | 4                  | SIGN POST                           |
|              | DOUBLE LAMPSTAND         | \$                 | STAND PIPE                          |
| -(H)-        | FIRE HYDRANT             | (o)                | STANDARD CONCRETE POST              |
| O~           | FLAGPOLE                 | •                  | STANDARD CONCRETE POST - FOUND      |
| Φ-           | GUY POLE                 |                    | STANDARD ROCK POST (TYPE 2) - FOUNI |
| $\leftarrow$ | GUY WIRE                 |                    | STANDARD ROCK POST (TYPE 2) - SET   |
| 0            | IRON PIN                 |                    | STIFFLEG OR PUSH POLE               |
| •            | IRON PIN - FOUND         | ₽<br>D             | STORM INSPECTION CHAMBER            |
| J            | JUNCTION BOX             | <del></del>        | TEST PIT                            |
| K            | KIOSK                    | $\Diamond$         | TRAFFIC COUNTER                     |
|              | LAMP STANDARD            | <b>\rightarrow</b> | TRAFFIC LIGHT STANDARD              |
| $\oslash$    | LAWN BASIN               | <b>A</b>           | TRAVERSE HUB - FOUND                |
|              | LEAD PLUG                | Δ                  | TRAVERSE HUB - SET                  |
| •            | LEAD PLUG - FOUND        |                    | TREE - CONIFEROUS                   |
| MB           | MAILBOX                  |                    | TREE - DECIDUOUS                    |
| $\otimes$    | MANHOLE                  | <b>63</b>          | TREE - ORNAMENTAL                   |
| 0            | MANHOLE - COMBINED       | Ø                  | TREE DIAMETER (m)                   |
| ©            | MANHOLE - ELECTRICAL     | DL                 | TREE DRIP LINE (m)                  |
| \$           | MANHOLE - SANITARY       | 500                | TREE TAG NUMBER                     |
| <b>(1)</b>   | MANHOLE - TELEPHONE      | $\bowtie$          | VALVE                               |
| (D)          | MANHOLE - STORM          | <b>G</b>           | VALVE - GAS                         |
| <b>(</b>     | MANHOLE - WATER          | ⊗IRV               | VALVE - IRRIGATION                  |
| ◊            | MARKER                   | $\bowtie$          | VALVE - WATER                       |
| ©            | MARKER - CABLE           | V                  | VAULT                               |
| <b>©</b>     | MARKER - GAS             | P                  | VAULT - ELECTRICAL                  |
| ₽            | MARKER - PIPE            |                    | VAULT - TELEPHONE                   |
| ₩            | MARKER - WATER MAIN      | ₽                  | VENT                                |
| ⊗sv          | METER                    | <b>®</b>           | WELL                                |
| ⊗GM          | METER - GAS              | <b>X</b>           | WOODEN POST (TYPE 6)- FOUND         |
| ⊗WM          | METER - WATER            |                    | WOODEN POST (TYPE 6)- SET           |
| ❖            |                          | K A                | •                                   |

4004 Wesbrook Mall | Vancouver BC | Canada V6T-2A3

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PLOT SCALE 1:250 APPROVED MF

JOB NO. 189-00175-00 DWG NO. C-202

2018/09/07