


JULY 27, 2016

SITE D UNIVERSITY BLVD.

DEVELOPMENT PERMIT RE-SUBMISSION

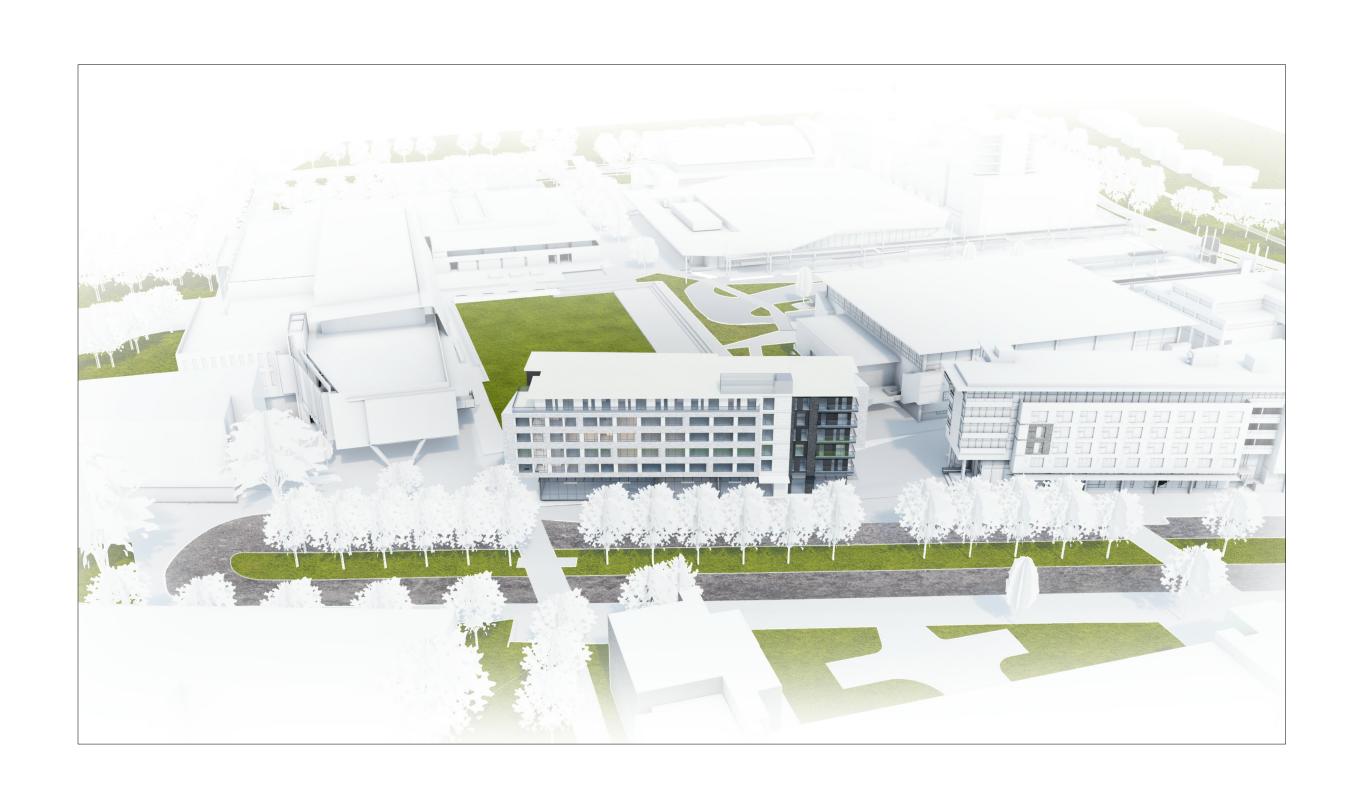

SITE D - UBC

CIVIC ADDRESS:

SITE D - UNIVERSITY BOULEVARD, UNIVERSITY OF BRITISH COLUMBIA

VANCOUVER, BC

ZONING:

HEIGHT Permitted

6 Levels (92') Proposed 6 Levels (69')

25' - Upper West Sideyard Setback

LEGAL ADDRESS:

DISTRICT LOT 3044 GROUP 1 NEW WESTMINSTER DISTRICT

SITE AREA:

24,322 SF

FSR	RESIDENTIAL	COMMERCIAL	Residential + CRU	NET AREA	NET FSR
FSR PROPOSED	62,879	9,783	72,661	69,055.53	2.84

DENSITY CALCULATION

RESIDENTIAL	UNITS	GROSS FLOOR AR	EA									Total Exclusion	FSR AREA	Building Area (incl. balcony)
	а	b	С	d	е	f	g	h	i = b - (c+f+g)	j	k	l = e + f + i + j+ k	m = b - l	m = b + d
Level	Units	Gross Area	Internal Circulation	Balcony	Residential	Shaft Space	Amenity	Commercial	Suite Area	In-Suite Storage	Enclosed Balconies	Total Deductions	Net Area	Net Area
					Lobby									
Level 1	0	11,459	622	0	538	0	0	9,783	0			538	10,921	11,459
Level 2	19	12,533	1,916	414	0	94	355	0	10,168	506	0	955	11,578	12,947
Level 3	20	12,533	1,916	572	0	94	0	0	10,523	513	0	607	11,927	13,105
Level 4	20	12,533	1,916	572	0	94	0	0	10,523	513	0	607	11,927	13,105
Level 5	20	12,533	1,916	572	0	94	0	0	10,523	513	0	607	11,927	13,105
Level 6	11	11,381	1,916	572	0	94	0	0	9,371	715	0	808	10,572	11,953
Roof	0	204	204		0	0	0	0	0	0	0	0	204	204
TOTAL	90	73,177	10,407			469	355	9,783	51,109	2,759	0	4,122	69,056	75,880

RESIDENTIAL	STUDIO/MICRO	1 BED	JR 2 BED	2 BED	2 BED + DEN	3 BED	TOTAL
Level 2	11	1	3	4	0	0	19
Level 3	12	1	3	4	0	0	20
Level 4	12	1	3	4	0	0	20
Level 5	12	1	3	4	0	0	20
Level 6	0	4	0	4	0	3	11
TOTAL	47	8	12	20	0	3	90
Mx	52%	9%	13%	22%	0%	3%	100%

PARKING CALCULATION: 1 LEVEL UNDERGROUND

	LEVEL
TYPE	1
Residential	37
(Small Car)	2
(Disability)	4
TOTALS	37
	37

RESIDENTIAL BICYCLE SPACE CALCULATION:							
TOTAL BICYCLE STORAGE :		REQUIRED	PROVIDED	TYPE			
RES: 1.5 SPACES PER UNIT (2.5.5)	Long-te	erm 134	135	CLASS A			
RES: 6 SPACES FOR MIN. 20 UNITS (2.5.5)	Short-T	erm 18	18	CLASS B			
TOTAL BICYCLE		152	153				
TYPE							
BIKE LOCKERS (Min 20%)		0	0	CLASS A			
VERTICAL (Max 30%)		C	24	CLASS A			
HORIZONTAL			111	CLASS A			
COMMERCIAL BICYCLE SPACE CAL	CULATION:						
TOTAL BICYCLE STORAGE :		REQUIRED	PROVIDED	TYPE			
COMM: 1 SPACE PER 750M2 (2.5.5)	Long-te	erm 2	2 0	CLASS A			
COMM: 1 SPACE PER 750M2 MIN. 4 SPACES							
(2.5.5)	Short-T	erm 4	6	CLASS B			
TOTAL BICYCLE		6	6				

UNIT BREAKDOWN

UNIT NAME	UNIT TYPE	UNIT AREA	NUM BER	LEVELS	STORAGE	ENC. BALCONIES	TTL UNIT AREA
Unit A	Studio	450	25	2+3+4+5	0	0	11,250
Unit B	Micro	355	22	2+3+4+5	0	0	7,810
Unit C	JR 2 Bed	625	8	2+3+4+5	40	0	4,680
Unit C1	JR 2 Bed	625	4	2+3+4+5	40	0	2,340
Unit D	2 Bed	842	15	2+3+4+5+6	40	0	12,030
Unit E	1 Bed	602	3	6	40	0	1,686
Unit F	3 Bed	1,175	2	6	40	0	2,270
Unit G	3 Bed	1,384	1	6	40	0	1,344
Unit H	2 Bed	794	5	2+3+4+5+6	0	0	3,970
Unit K	1 Bed	470	5	2+3+4+5+6	0	0	2,350
TOTAL	TOTAL		90				49,730

SET BACKS

6' - University Blvd. Setback 25' - West Sideyard Setback

25' - East Sideyard Setback

32' - Upper East Sideyeard Setback

Λ 1 Π1	
A-1.01	PROJECT STATISTICS
A-1.02	SITE CONTEXT
A-1.03	SITE PLAN
A-1.04	SITE SURVEY
A-1.05	STREETSCAPE
A-1.06	SHADOW ANALYSIS
A-1.07a	DESIGN RATIONALE
A-1.07b	DESIGN RATIONALE
A-1.07c	DESIGN RATIONALE
A-2.01	PARKING P1
A-3.01	LEVEL 1
A-3.02	LEVEL 2
A-3.03	LEVELS 3-5
A-3.04	LEVEL 6
A-3.05	ROOF LEVEL
A-4.01	SOUTH ELEVATION
A-4.02	WEST ELEVATION
A-4.03	NORTH ELEVATION
A-4.04	EAST ELEVATION
A-5.01	SECTIONS A A
A-5.02	SECTION B B
A-5.03	SECTION C C
A-5.04	SECTION D D
A-6.01	3D VIEWS/UNITS
A-7.01	LEVEL 1 - FSR PLAN
A-7.02	LEVEL 2 - FSR PLAN
A-7.03	LEVELS 3 & 5 - FSR PLAN
A-7.04	LEVEL 6 - FSR PLAN
A-7.05	ROOF - FSR PLAN
L001	SURFACE DEMOLITION AND TREE
	MANAGEMENT FULL BUILDOUT CONTEXT
L100	SITE PLAN
L200	GRADING PLAN
L300	PLANTING PLAN
L400	TYPICAL DETAILS
	A-1.03 A-1.04 A-1.05 A-1.06 A-1.07a A-1.07b A-1.07c A-2.01 A-3.01 A-3.02 A-3.03 A-3.04 A-3.05 A-4.01 A-4.02 A-4.03 A-4.04 A-5.01 A-5.02 A-5.03 A-5.04 A-7.01 A-7.02 A-7.03 A-7.04 A-7.05 L001 L100 L200 L300

NOTES NO. DESCRIPTION

COPYRIGHT RESERVED; THIS PLAN AND DESIGN ARE AND AT ALL TIMES REMAIN THE EXCLUSIVE PROPERTY OF GBL ARCHITECTS AND MAY NOT BE USED OR REPRODUCED WITHOUT THEIR WRITTEN CONSENT

GBL ARCHITECTS
139 EAST 8TH AVENUE
VANCOUVER, CANADA V5T 1R8
T 604 736 1156 F 604 731 5279
GBLARCHITECTS.COM

REVISIONS NO. DATE 01 JUNE 2, 2016 DEVELOPMENT PERMIT SUBMISSION DEVELOPMENT PERMIT RE-SUBMISSION

SITE D UNIVERSITY BOULEVARD, UBC


JOB NUMBER


MARKET RENTAL DEVELOPMENT


PROJECT STATS

APRIL 2016 DRAWN BY CHECKED BY SCALE

1617

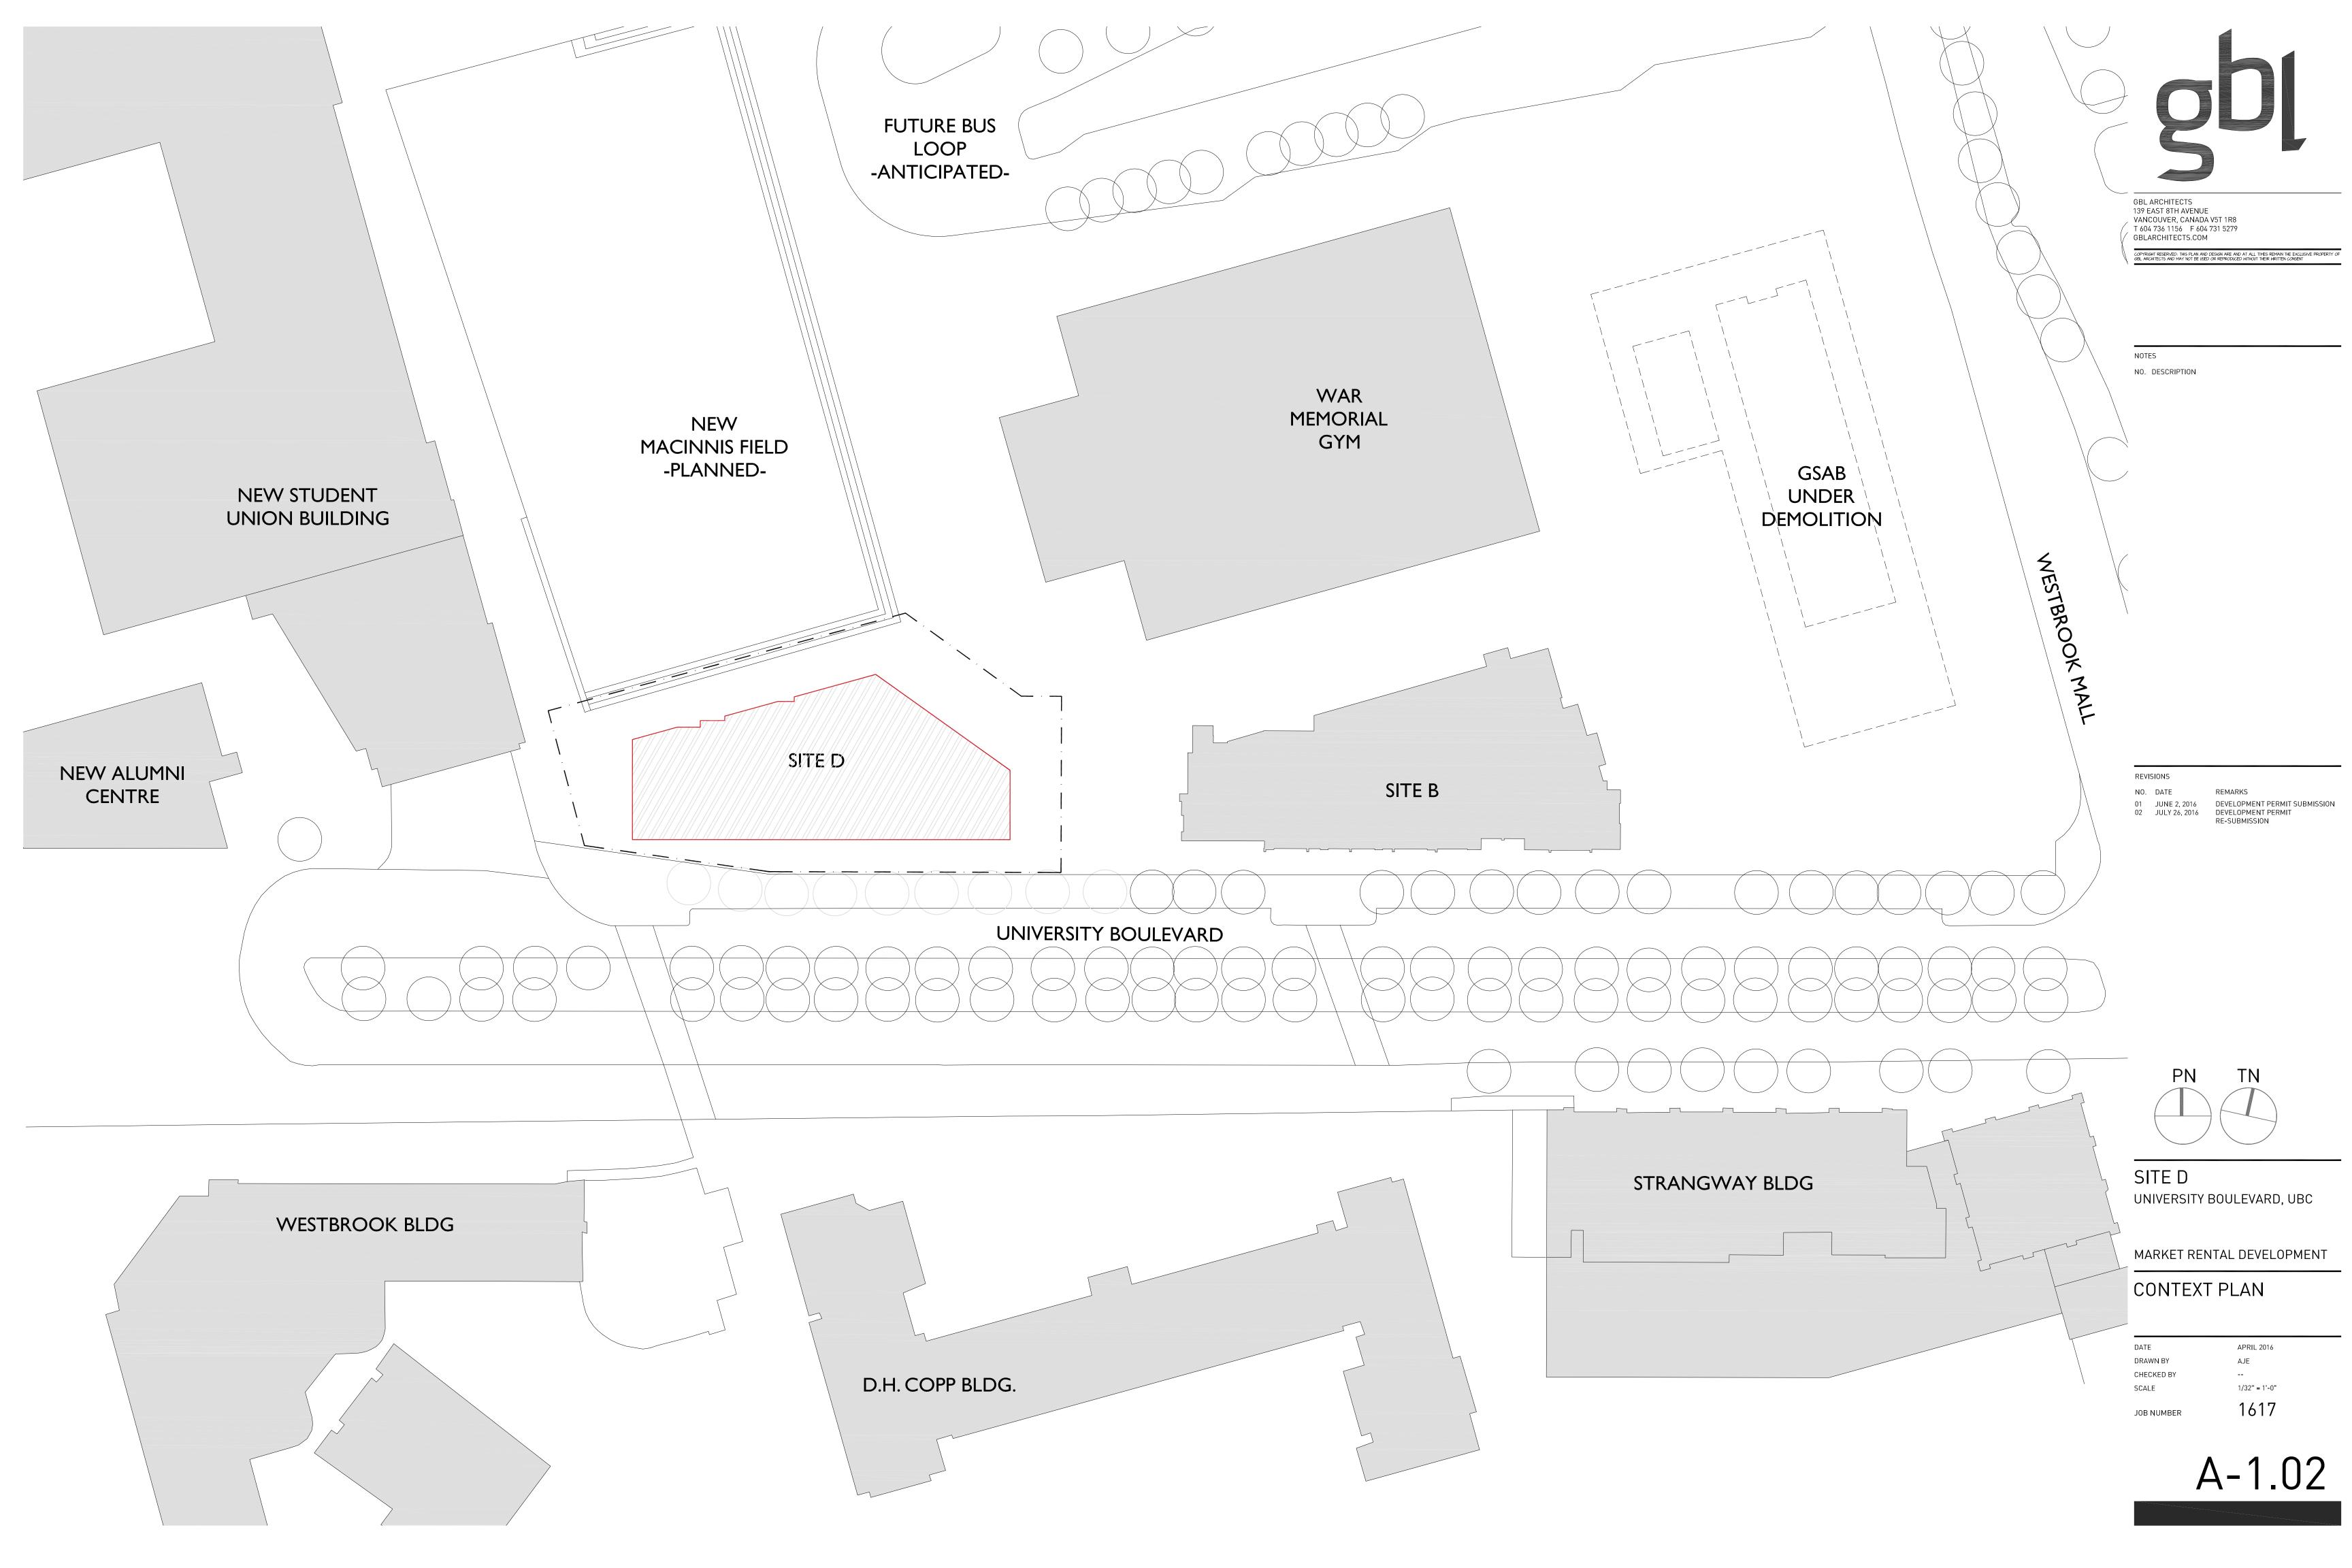

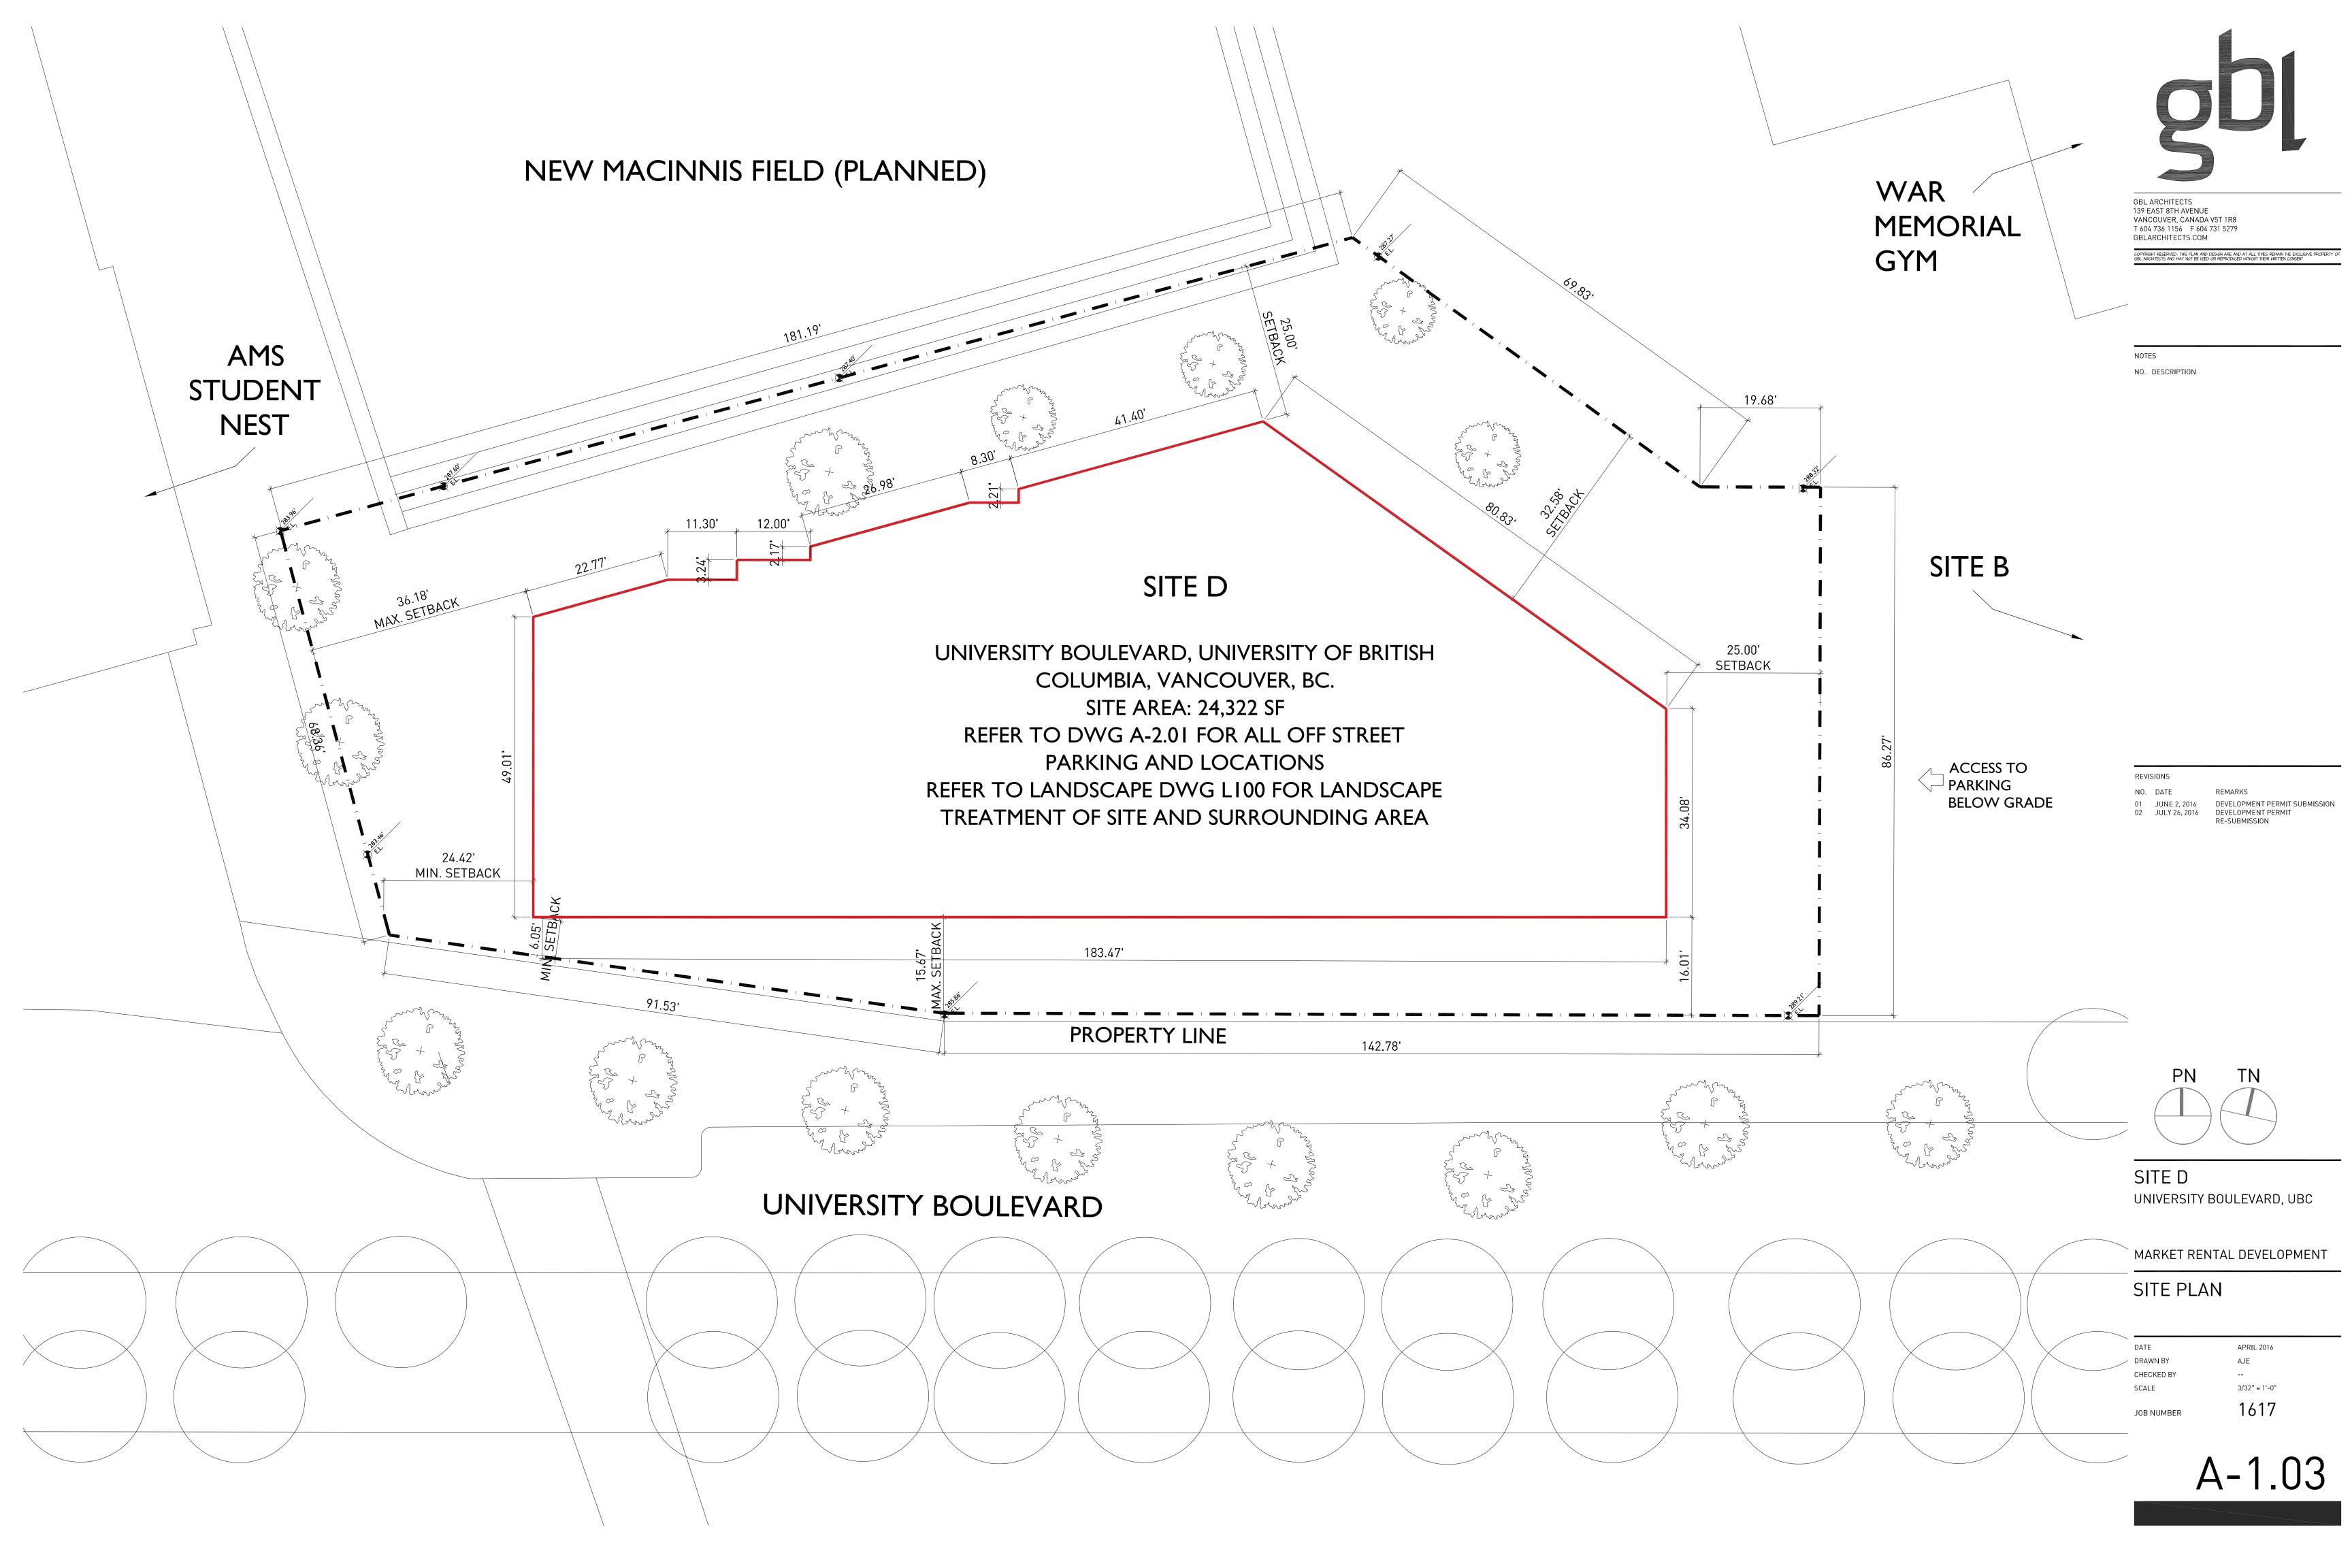

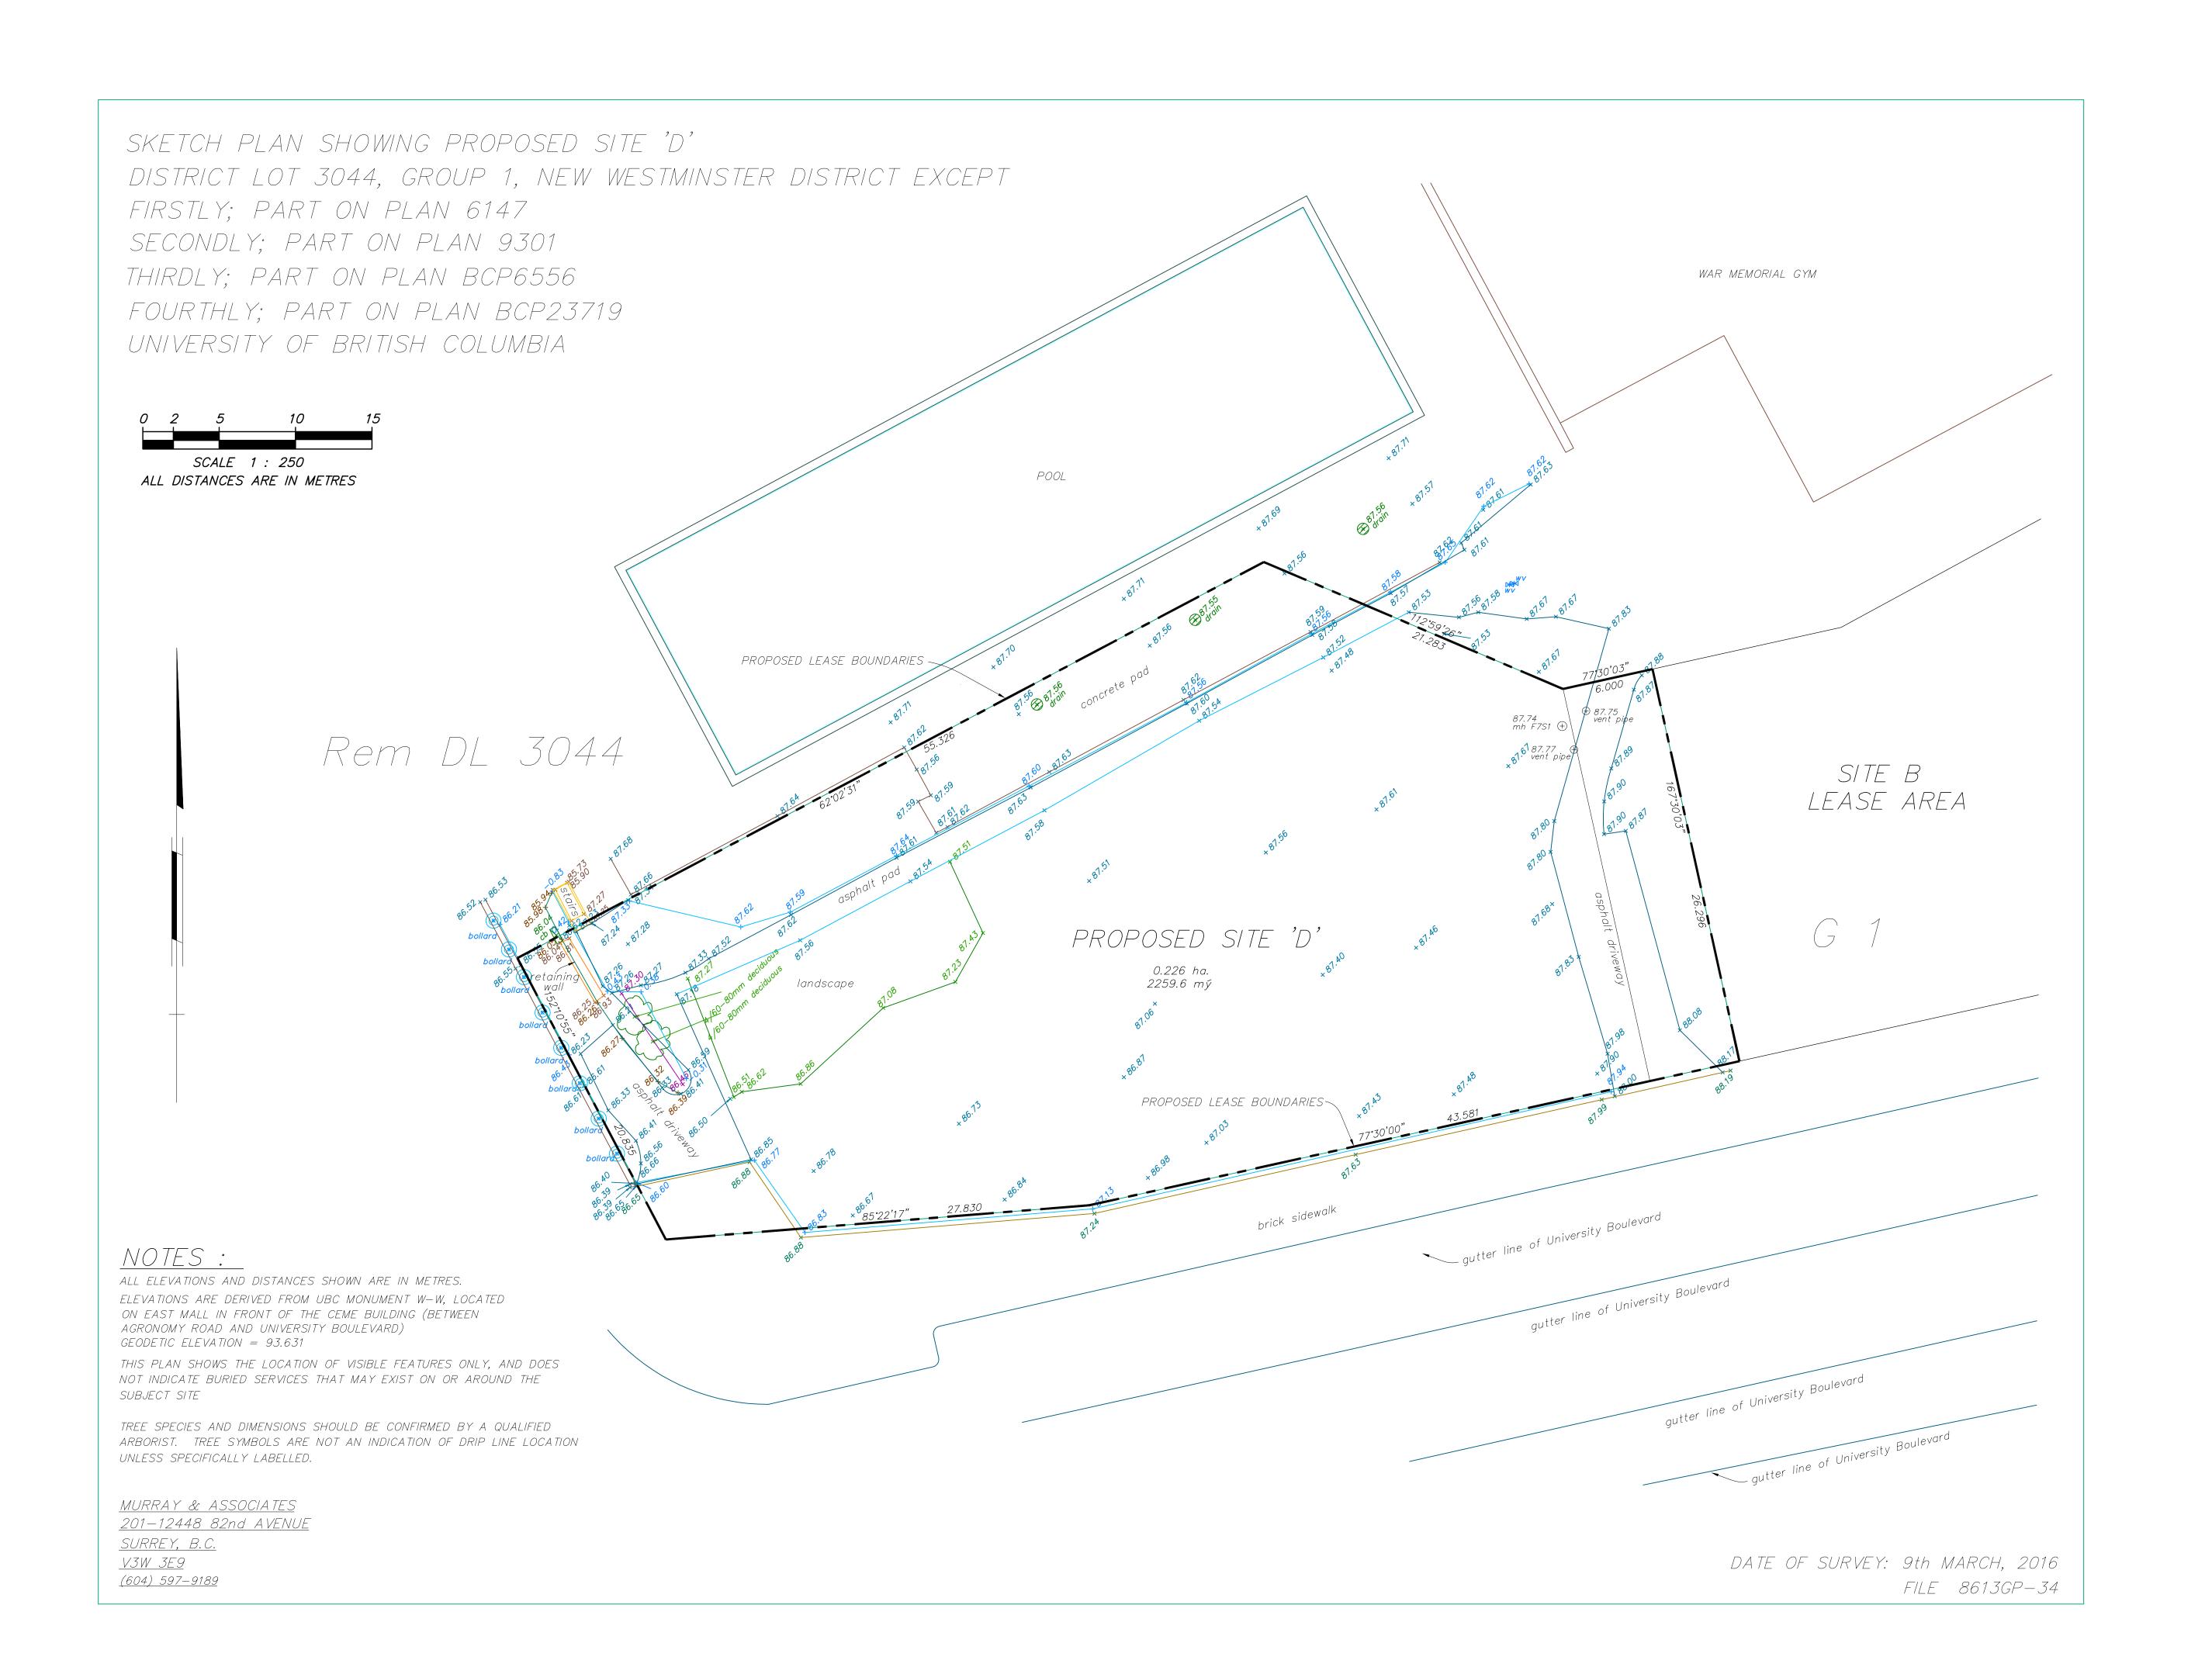



COPYRIGHT RESERVED: THIS PLAN AND DESIGN ARE AND AT ALL TIMES REMAIN THE EXCLUSIVE PROP.
6BL ARCHITECTS AND MAY NOT BE USED OR REPRODUCED WITHOUT THEIR WRITTEN CONSENT

NOTES

NO. DESCRIPTION


REVISIO

NO. DATE REMARKS

01 JUNE 2, 2016 DEVELOPMENT PERMIT SUBMISS

02 JULY 26, 2016 DEVELOPMENT PERMIT

RE-SUBMISSION

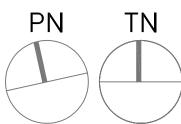

SITE D

SCALE

UNIVERSITY BOULEVARD, UBC

MARKET RENTAL DEVELOPMENT

SURVEY PLAN

DATE APRIL 2016
DRAWN BY AJE
CHECKED BY ---

JOB NUMBER 1617

 $\Delta - 1 \Omega /$

1/16" = 1'-0"








COPYRIGHT RESERVED: THIS PLAN AND DESIGN ARE AND AT ALL TIMES REMAIN THE EXCLUSIVE PROPERTY GBL ARCHITECTS AND MAY NOT BE USED OR REPRODUCED WITHOUT THEIR WRITTEN CONSENT


NOTES

NO. DESCRIPTION




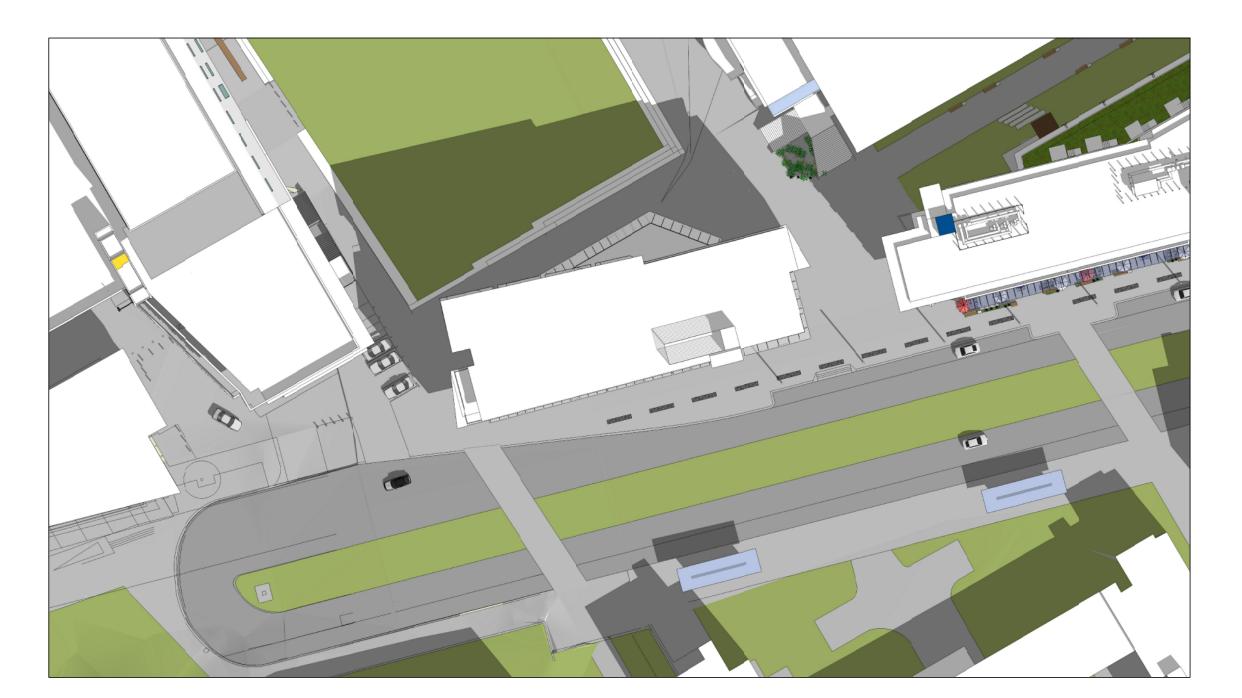


EQUINOX - 10AM

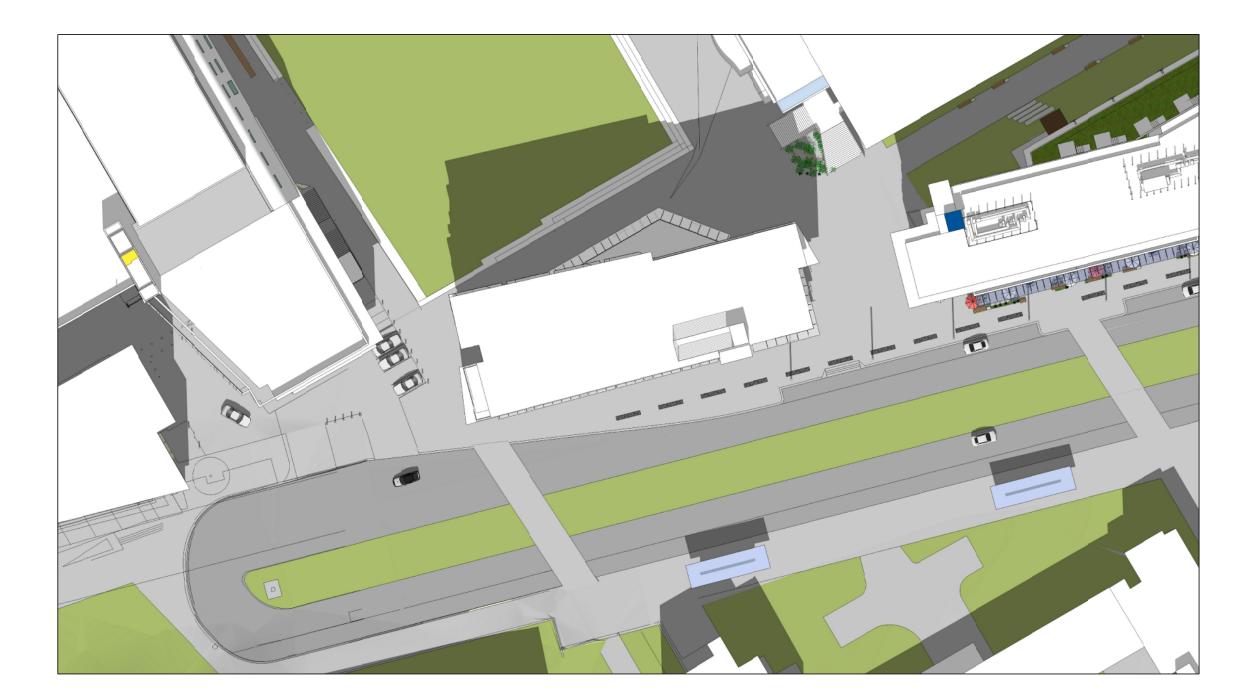


EQUINOX - 12PM

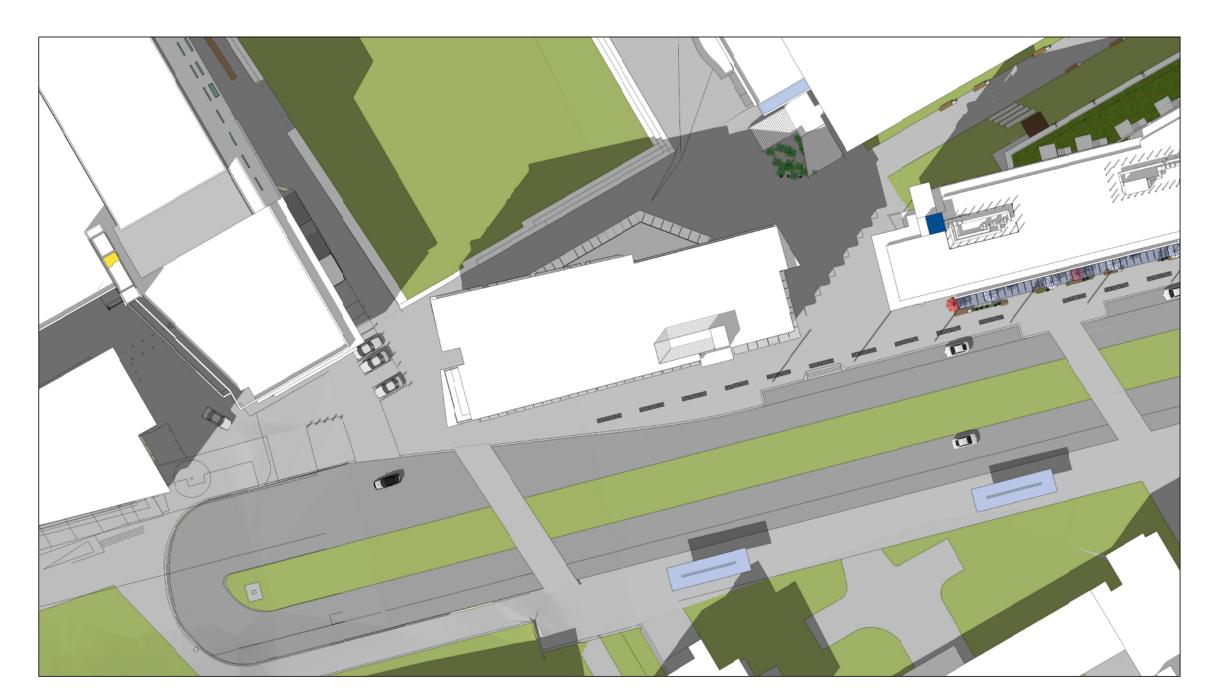

SOLSTICE - 10AM

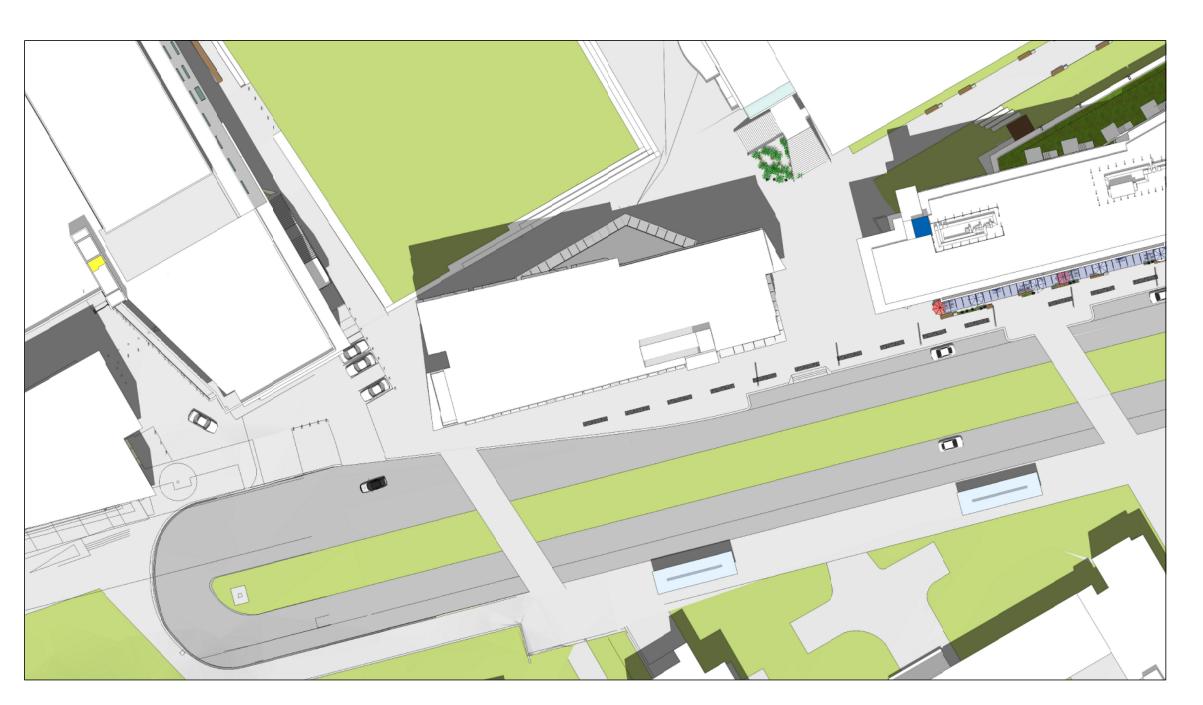

SOLSTICE - 12PM

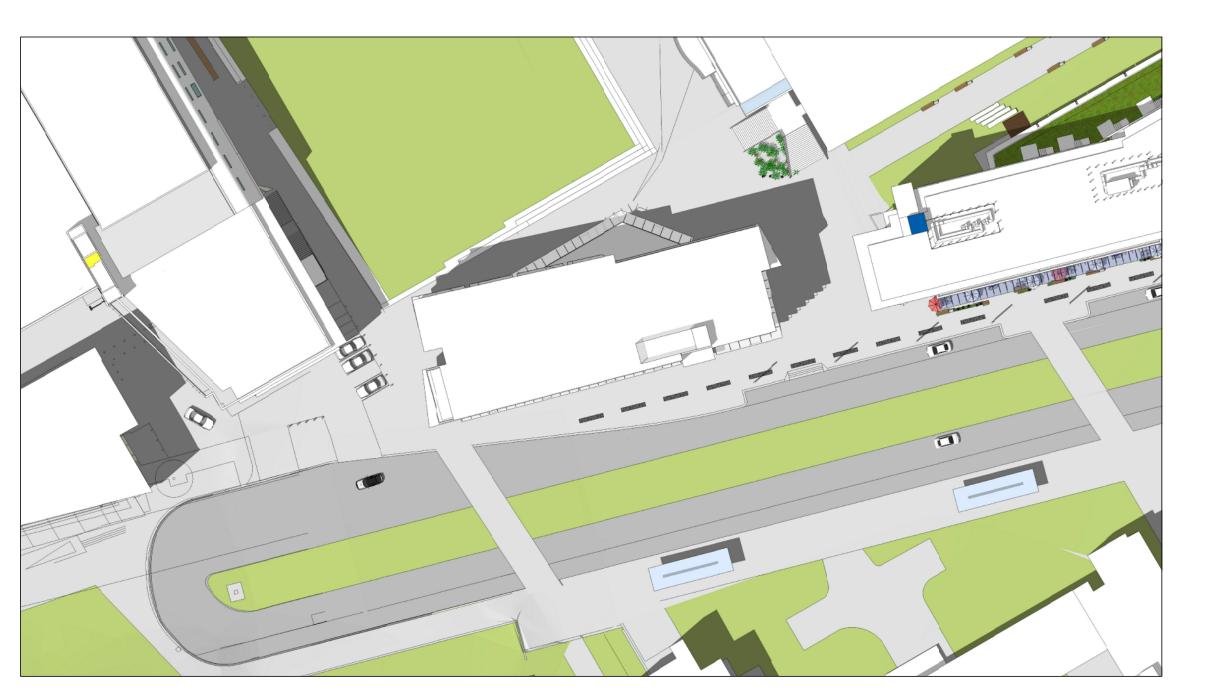

SOLSTICE - 2PM



COPYRIGHT RESERVED: THIS PLAN AND DESIGN ARE AND AT ALL TIMES REMAIN THE EXCLUSIVE PROPERTY OBLARCHITECTS AND MAY NOT BE USED OR REPRODUCED WITHOUT THEIR WRITTEN CONSENT


NOTES

NO. DESCRIPTION

REVISIONS

NO. DATE REMARKS

01 JUNE 2, 2016 DEVELOPMENT PERMIT SUBMISSION
02 JULY 26, 2016 DEVELOPMENT PERMIT
RE-SUBMISSION

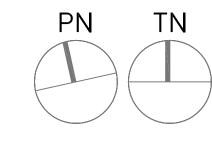

SITE D

UNIVERSITY BOULEVARD, UBC

MARKET RENTAL DEVELOPMENT

SHADOW ANALYSIS

DATE APRIL 2016
DRAWN BY AJE
CHECKED BY -SCALE NTS

JOB NUMBER

A-1.06

1617

BASE CONCEPT

The site presents two formalised frontages on to University Boulevard and Macinnes Park. These frontages each wrap around the corners in response to the primary flows of pedestrian movement around the site.

These opposing corner dynamics help sculpt two interlocking building forms that are separated by a linear bank of commercial units, presenting a simple yin-yang configuration.

The breaks between each building form present logical entry points to the building; a primary street entry perpendicuar to university boulevard and a secondary plaza entry at the north west corner.

These offset entry points allow for long unbroken commercial frontages with strong corner presence, creating an active, transparent base that engages fully with the surrounding public realm.


The building facades align on all sides with the adjacent property lines to eliminate any potential pinch points and permit increased ease of pedestrian movement around the base of the building.

UPPER MASSING CONCEPT


Above the commercial base, the building form rises up to six storeys. The footprint for the upper levels takes on a more elongated form to maximise the efficiency of a double loaded corridor layout.

This contrasting building form reflects the differing set of design criteria that is applicable to the residential units above. Response to daylight and views, open circualtion, smaller unit configurations, and contextual continuity all contribute to a change in massing.


To avoid a complete disconnect, certain edges of the building are carried up the full 6 levels to maintain an appropriate balance of form. The south east corner that defines the main entry is one such edge, allowing for clear visual connection between the main residential entry lobby and the associated residential levels above.

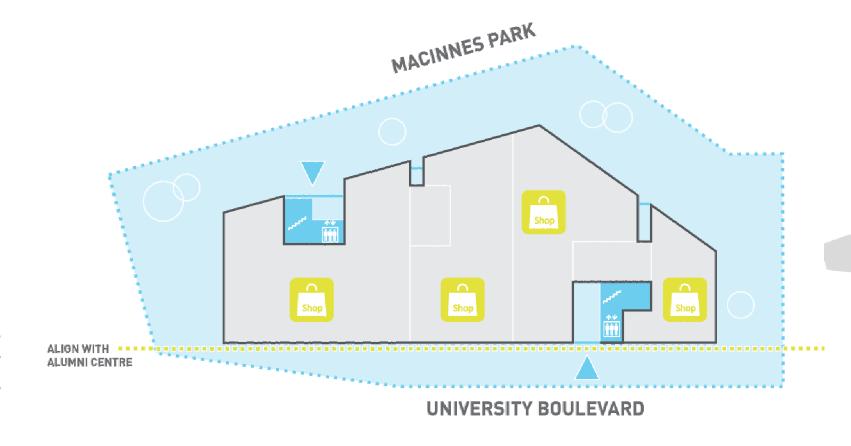


GROUND FLOOR PLAN: COMPACT OFFSET ENTRY POINTS ALLOWING INCREASED COMMERCIAL TRANSPARENCY

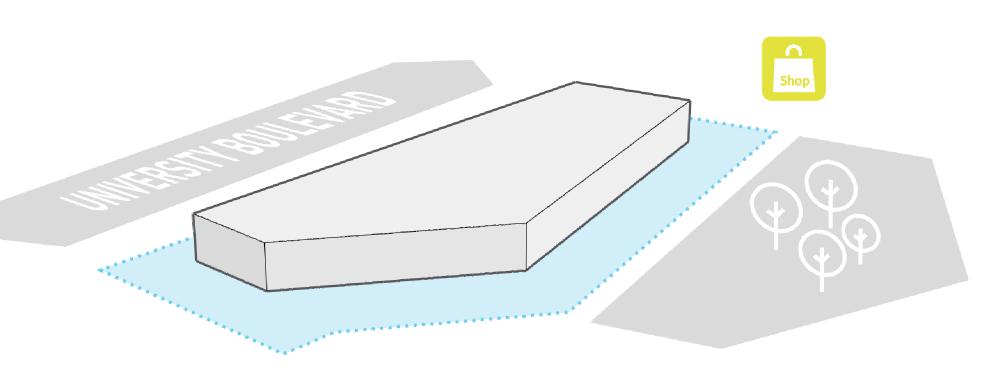

GROUND FLOOR MASSING: CHAMFERED BUILDING BASE OPENS UP PEDESTRIAN FLOW AROUND PUBLIC REALM

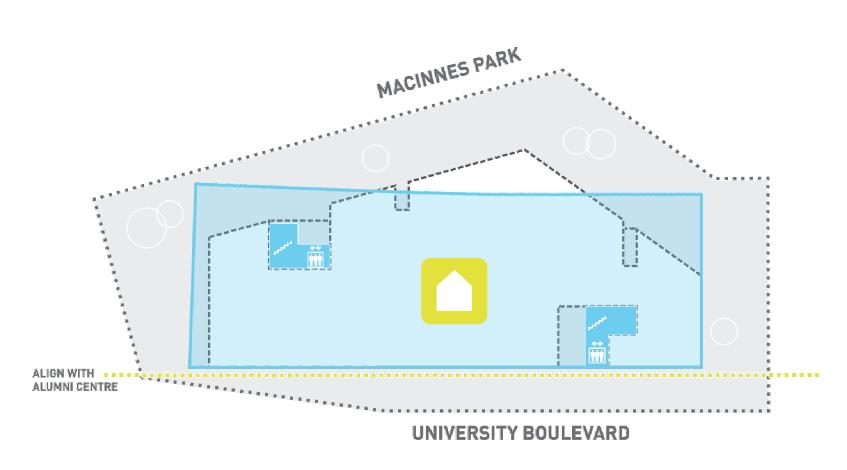

SUPERIMPOSED FLOOR PLANS: OFFSET UPPER MASSING IN RESPONSE TO CONTEXTUAL REFERENCE

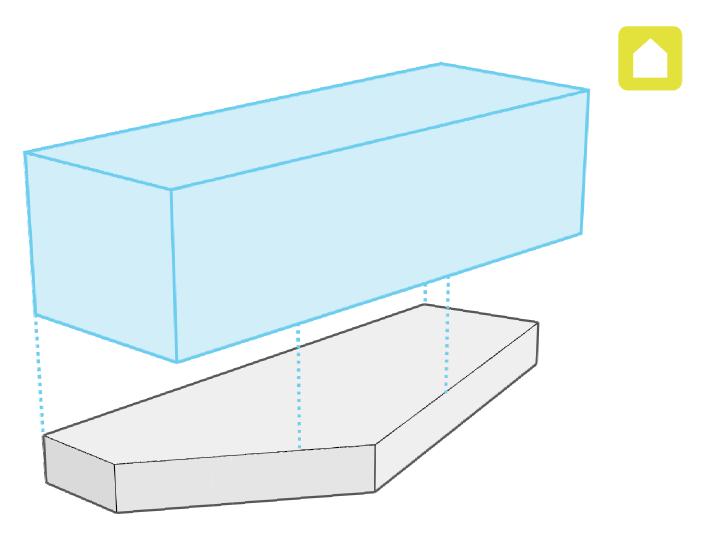

UPPER LEVEL MASSING: BUILDING FORM EXSTRUDED UP FROM LEVELS 2 TO 6



GBL ARCHITECTS
139 EAST 8TH AVENUE
VANCOUVER, CANADA V5T 1R8
T 604 736 1156 F 604 731 5279
GBLARCHITECTS.COM

COPYRIGHT RESERVED. THIS PLAN AND DESIGN ARE AND AT ALL TIMES REMAIN THE EXCLUSIVE PROPERTY GBL ARCHITECTS AND MAY NOT BE USED OR REPRODUCED WITHOUT THEIR WRITTEN CONSENT

NOTES

NO. DESCRIPTION

REVIS

NO. DATE REMARKS

01 JUNE 2, 2016 DEVELOPMENT PERMIT SUBMISSION
02 JULY 26, 2016 DEVELOPMENT PERMIT
RE-SUBMISSION

SITE D

UNIVERSITY BOULEVARD, UBC

MARKET RENTAL DEVELOPMENT


DESIGN RATIONALE

DATE APRIL 2016
DRAWN BY AJE
CHECKED BY --


JOB NUMBER 1617

SCALE


A-1.07a

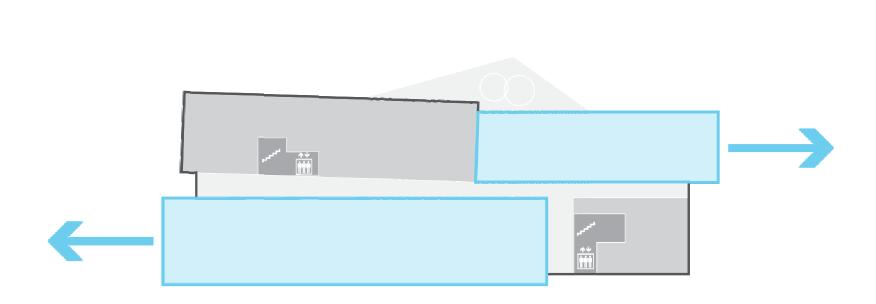




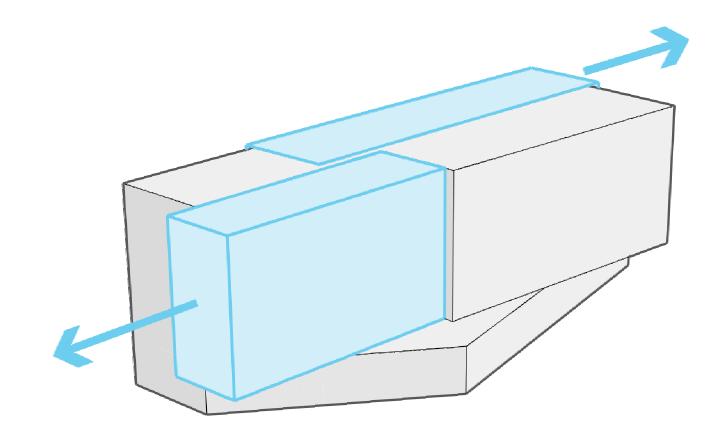

UPPER LEVEL MASSING: UPPER LEVELS PROJECT OVER CORNERS OF COMMERCIAL BASE

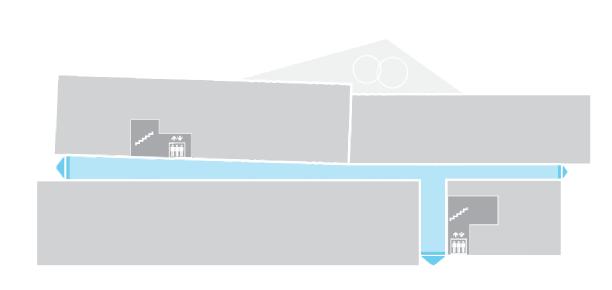

TYPICAL FLOOR PLANS: OPEN CIRCULATION BREAKS AROUND BUILDING EDGE

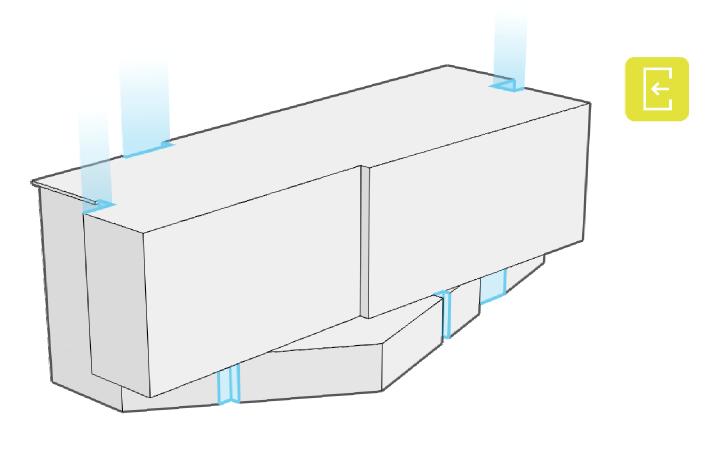

MASSING INTEGRATION: VERTICAL CIRCULATION
CHANNELS PROVIDE VISUAL CONTINUITY AND ANIMATION

DYNAMIC FORM

Given the 360° site exposure, there is an opportunity to express the building form on all sides, creating publicly engaging frontages that respond individually to their diverse orientations.

The interlocking concept of the residential lobbies is transferred to the upper levels, grouping the small and large units into two separate massing stacks.

To maximise the efficiency of the smaller unit stacks, the building form elongates itself at opposite corners. This linear massing floats above the unencumbered public realm, maximising the site potential along the east/west axis.

The north west building stack is slightly flared to open up increased sightlines to and from university boulevard, capture afternoon sun within the corridors, and create an angled facade articulation that is consistent with the neighbouring buildings.

BUILDING PERMEABILITY

The elongated building form is broken intermittently on all sides to visually soften the massing and introduce a reduced scaling to the built form.

The long, linear residential corridors are glazed at each end to allow natural light and air permeate each level. The flared aperture at the west end of the building captures the afternoon sun.

In addition to the massing breaks, the vertical circulation channels help provide a visual connection between the inside and out, animating elements of the building through visible movement and user activity.



GBL ARCHITECTS
139 EAST 8TH AVENUE
VANCOUVER, CANADA V5T 1R8
T 604 736 1156 F 604 731 5279
GBLARCHITECTS.COM

COPYRIGHT RESERVED. THIS PLAN AND DESIGN ARE AND AT ALL TIMES REMAIN THE EXCLUSIVE PROPERTY GBL ARCHITECTS AND MAY NOT BE USED OR REPRODUCED WITHOUT THEIR WRITTEN COMENT

NOTES

NO. DESCRIPTION

REVISION

NO. DATE REMARKS

01 JUNE 2, 2016 DEVELOPMENT PERMIT SUBMISSION
02 JULY 26, 2016 DEVELOPMENT PERMIT
RE-SUBMISSION

SITE D

UNIVERSITY BOULEVARD, UBC

MARKET RENTAL DEVELOPMENT

DESIGN RATIONALE

DATE APRIL 2016
DRAWN BY AJE
CHECKED BY --

JOB NUMBER 1617


SCALE

A-1.07b


STEPPED FORM

To help reduce the physical mass of the building, and provide streetwall continunity from Site B, the building has been strategically stepped around the north east and south west corners.

The remaining corners continue up full height, consistent with the massing of the Alumni Centre to the west. This 'hybrid form' helps bridge between the residential and institutional building typologies along University Boulevard.

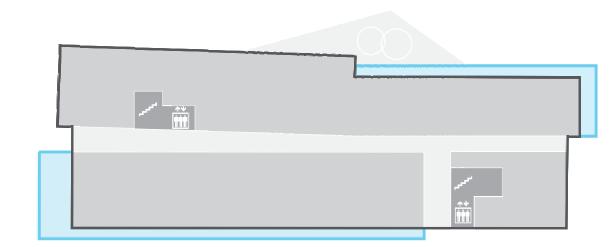

UPPER FLOOR PLAN: BUILDING FORM STEPPED BACK AROUND BANKED CORNERS

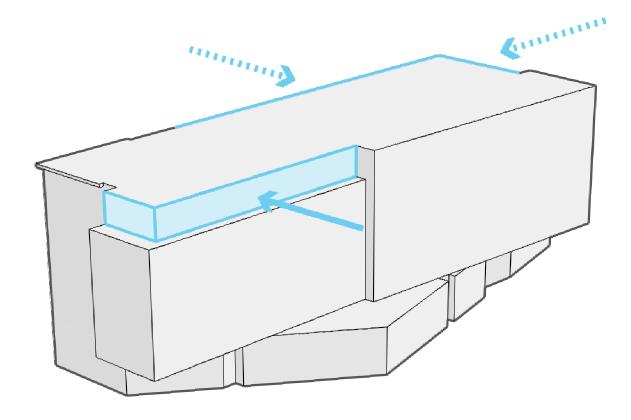


UPPER LEVEL MASSING: STEPBACKS ARE CONSISTENT ON OPPOSITE CORNERS OF THE BUILDING MASSING

FACADE ARTICULATION


The building facades are clearly expressed as an honest representation of the unit typologies within each level.

The more uniform smaller units are banked together in two elongated rectangular 'tubes' that project out over the north east and south west corners of the commercial base. These 'tubes' are clad in an offset linear masonry wrap, providing a clear streetwall expression.

The larger units are banked in more restrained blocks, using shallow balcony projections to create a patterning texture that is invertly proportional to the recessed windows within the masonry clad 'tubes'.

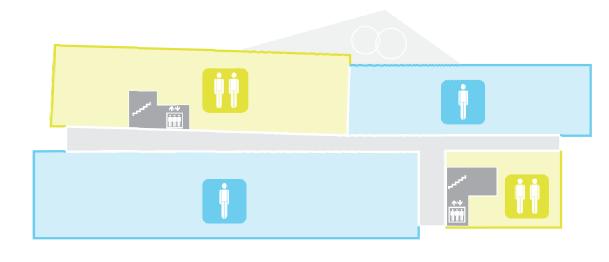

TYPICAL FLOOR PLAN: LARGER AND SMALLER UNITS GROUPED INTO SEPARATE STACKS

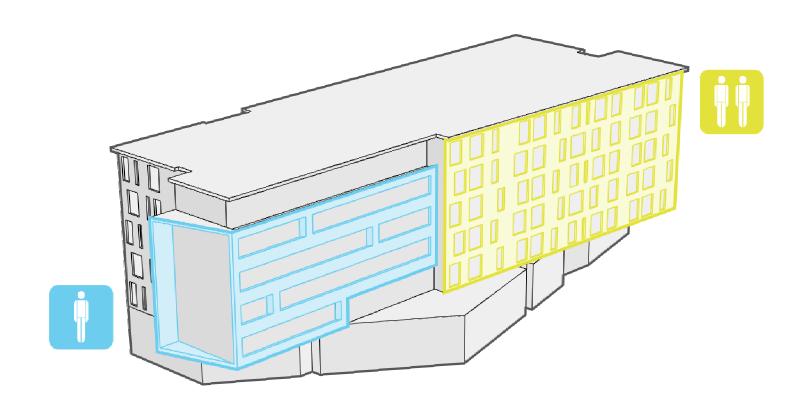

TYPICAL LEVEL MASSING: UNITS STACKS CLEARLY EXPRESSED THROUGH CONTRASTING FACADE ARTICULATION



GBL ARCHITECTS
139 EAST 8TH AVENUE
VANCOUVER, CANADA V5T 1R8
T 604 736 1156 F 604 731 5279
GBLARCHITECTS.COM

COPYRIGHT RESERVED: THIS PLAN AND DESIGN ARE AND AT ALL TIMES REMAIN THE EXCLUSIVE PROPERTY GBL ARCHITECTS AND MAY NOT BE USED OR REPRODUCED WITHOUT THEIR WRITTEN CONSENT

NO. DESCRIPTION

REVISION

NO. DATE REMARKS

01 JUNE 2, 2016 DEVELOPMENT PERMIT SUBMISSION
02 JULY 26, 2016 DEVELOPMENT PERMIT
RE-SUBMISSION

SITE D

UNIVERSITY BOULEVARD, UBC


MARKET RENTAL DEVELOPMENT

DESIGN RATIONALE

DATE APRIL 2016
DRAWN BY AJE
CHECKED BY -SCALE NTS

JOB NUMBER 1617

A-1.07c

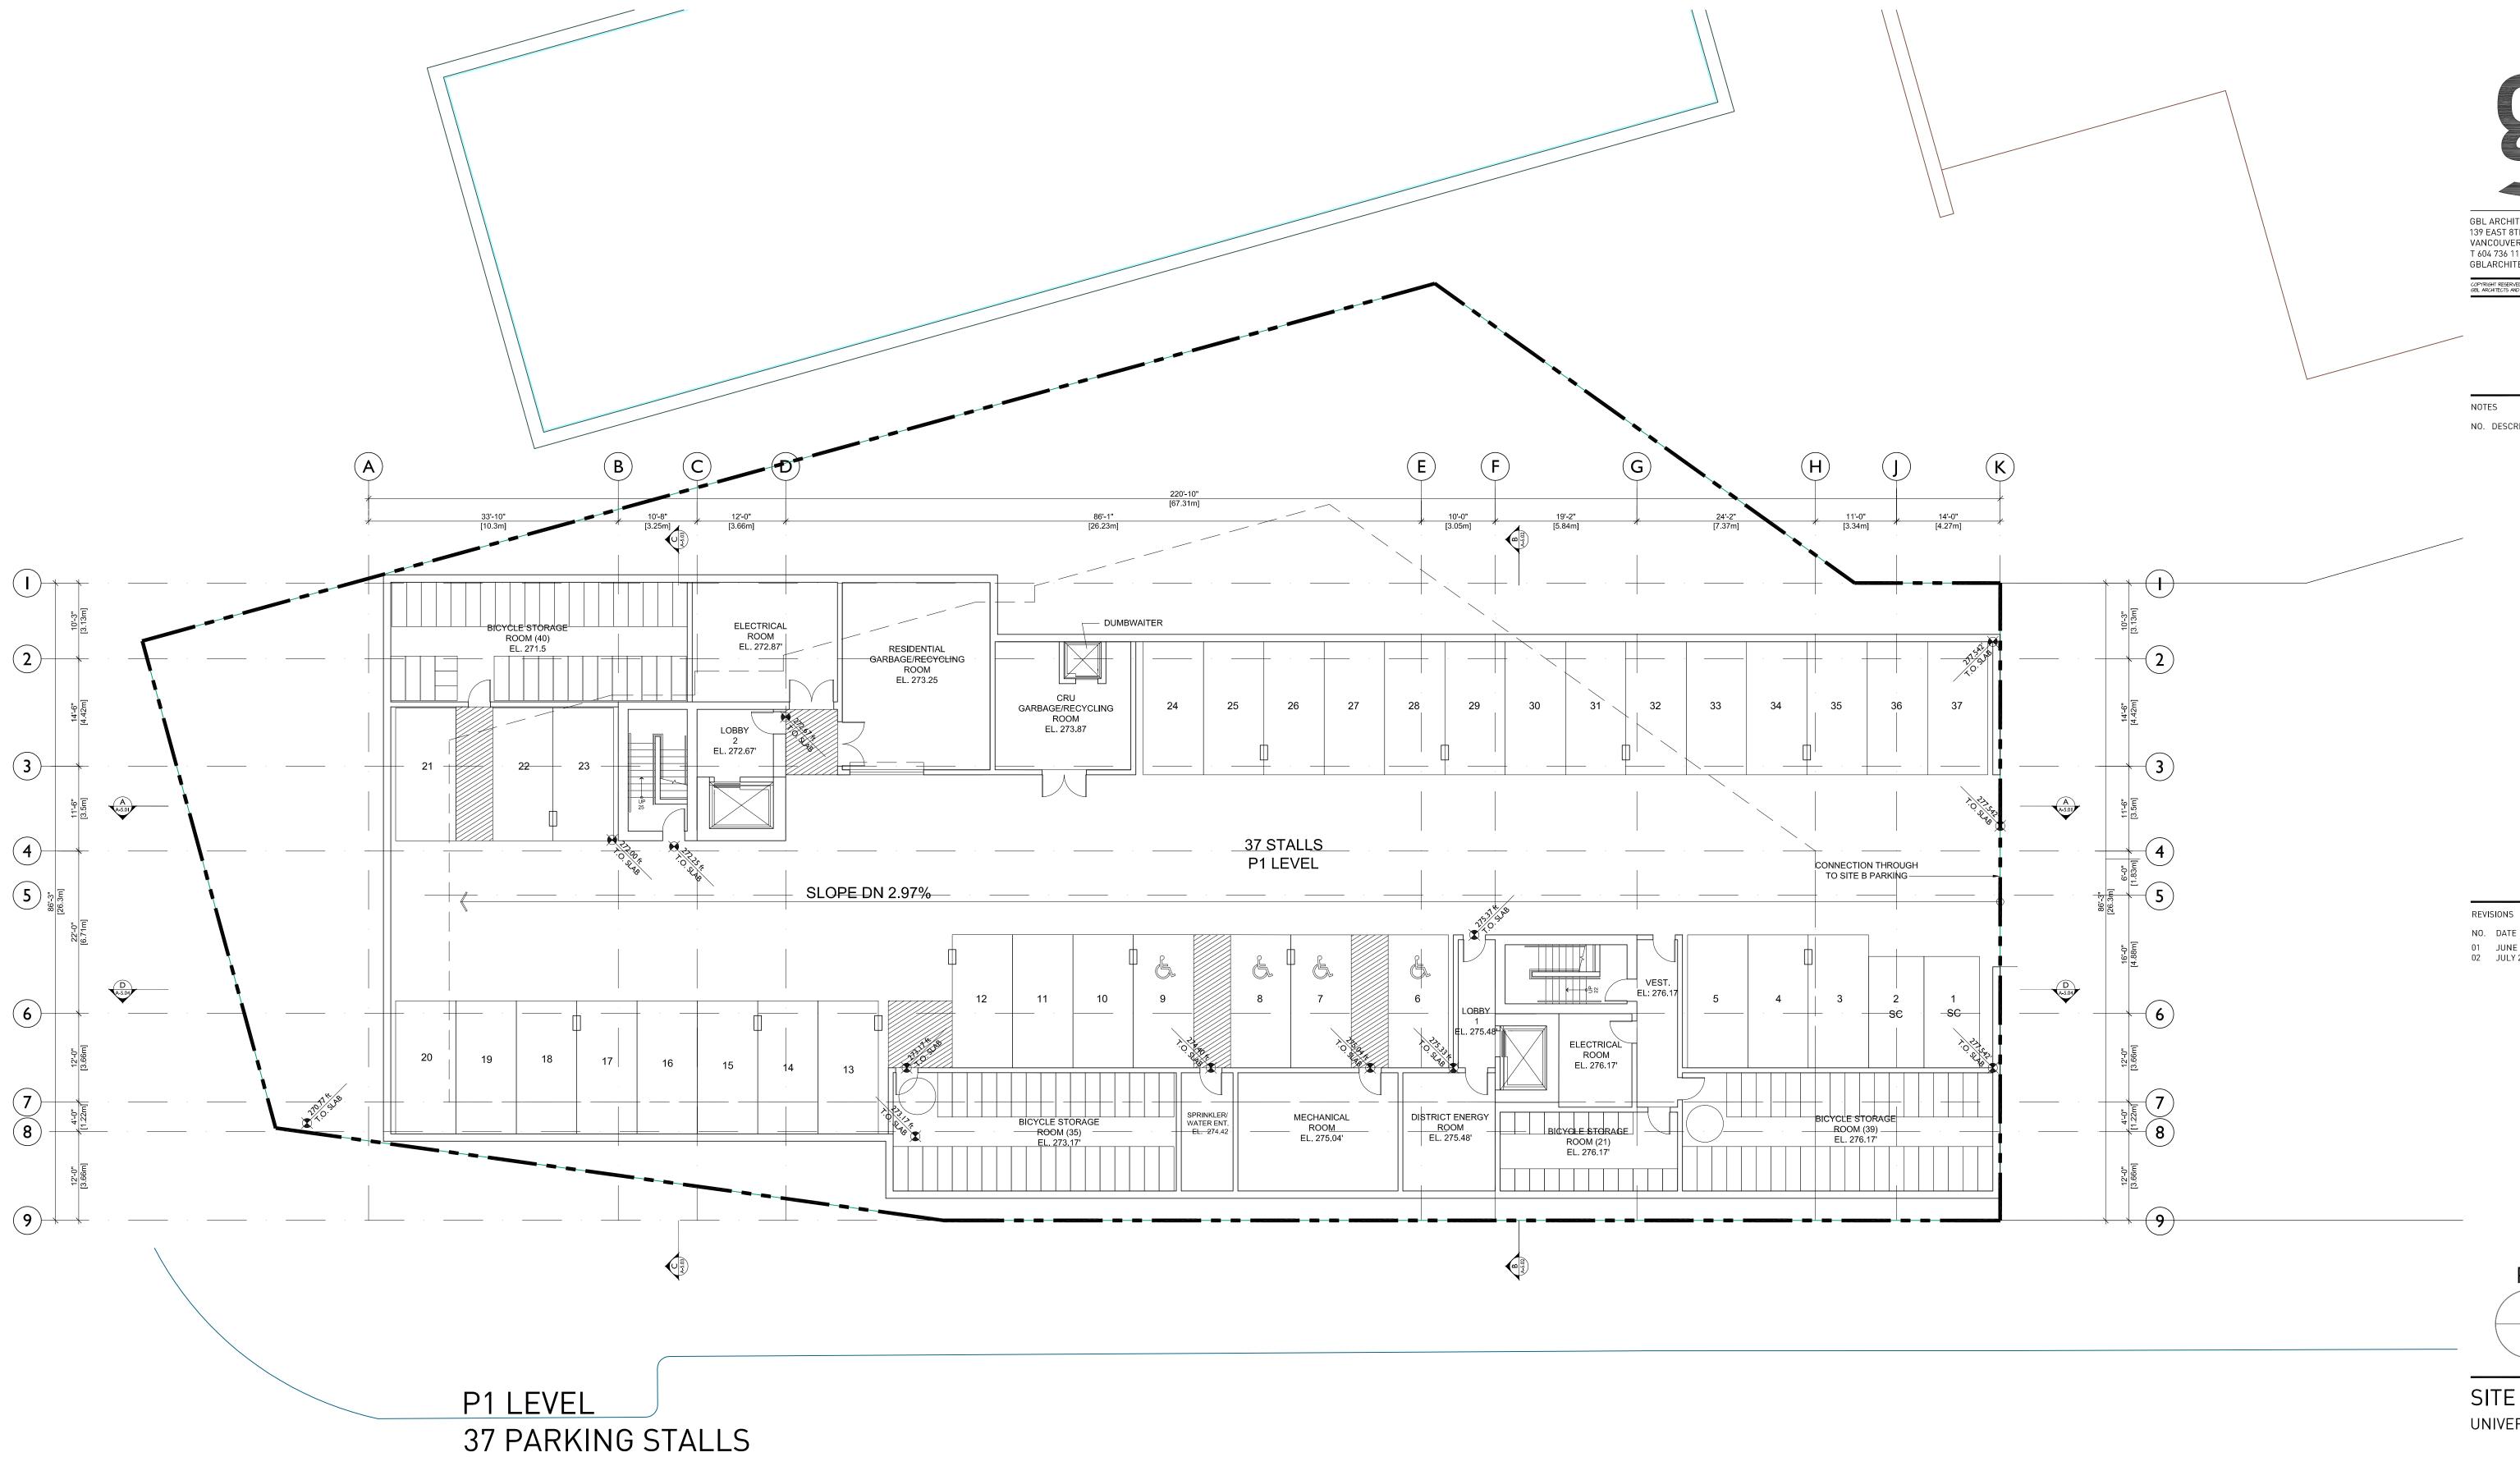



COPYRIGHT RESERVED: THIS PLAN AND DESIGN ARE AND AT ALL TIMES REMAIN THE EXCLUSIVE PROPERTY GBL ARCHITECTS AND MAY NOT BE USED OR REPRODUCED WITHOUT THEIR WRITTEN CONSENT

NO. DESCRIPTION

01 JUNE 2, 2016 DEVELOPMENT PERMIT SUBMISSION
02 JULY 26, 2016 DEVELOPMENT PERMIT
RE-SUBMISSION

PΝ

SITE D

UNIVERSITY BOULEVARD, UBC


MARKET RENTAL DEVELOPMENT

PARKING LEVEL 1

DATE APRIL 2016 DRAWN BY CHECKED BY SCALE 3/32" = 1'-0"

1617 JOB NUMBER

A-2.01

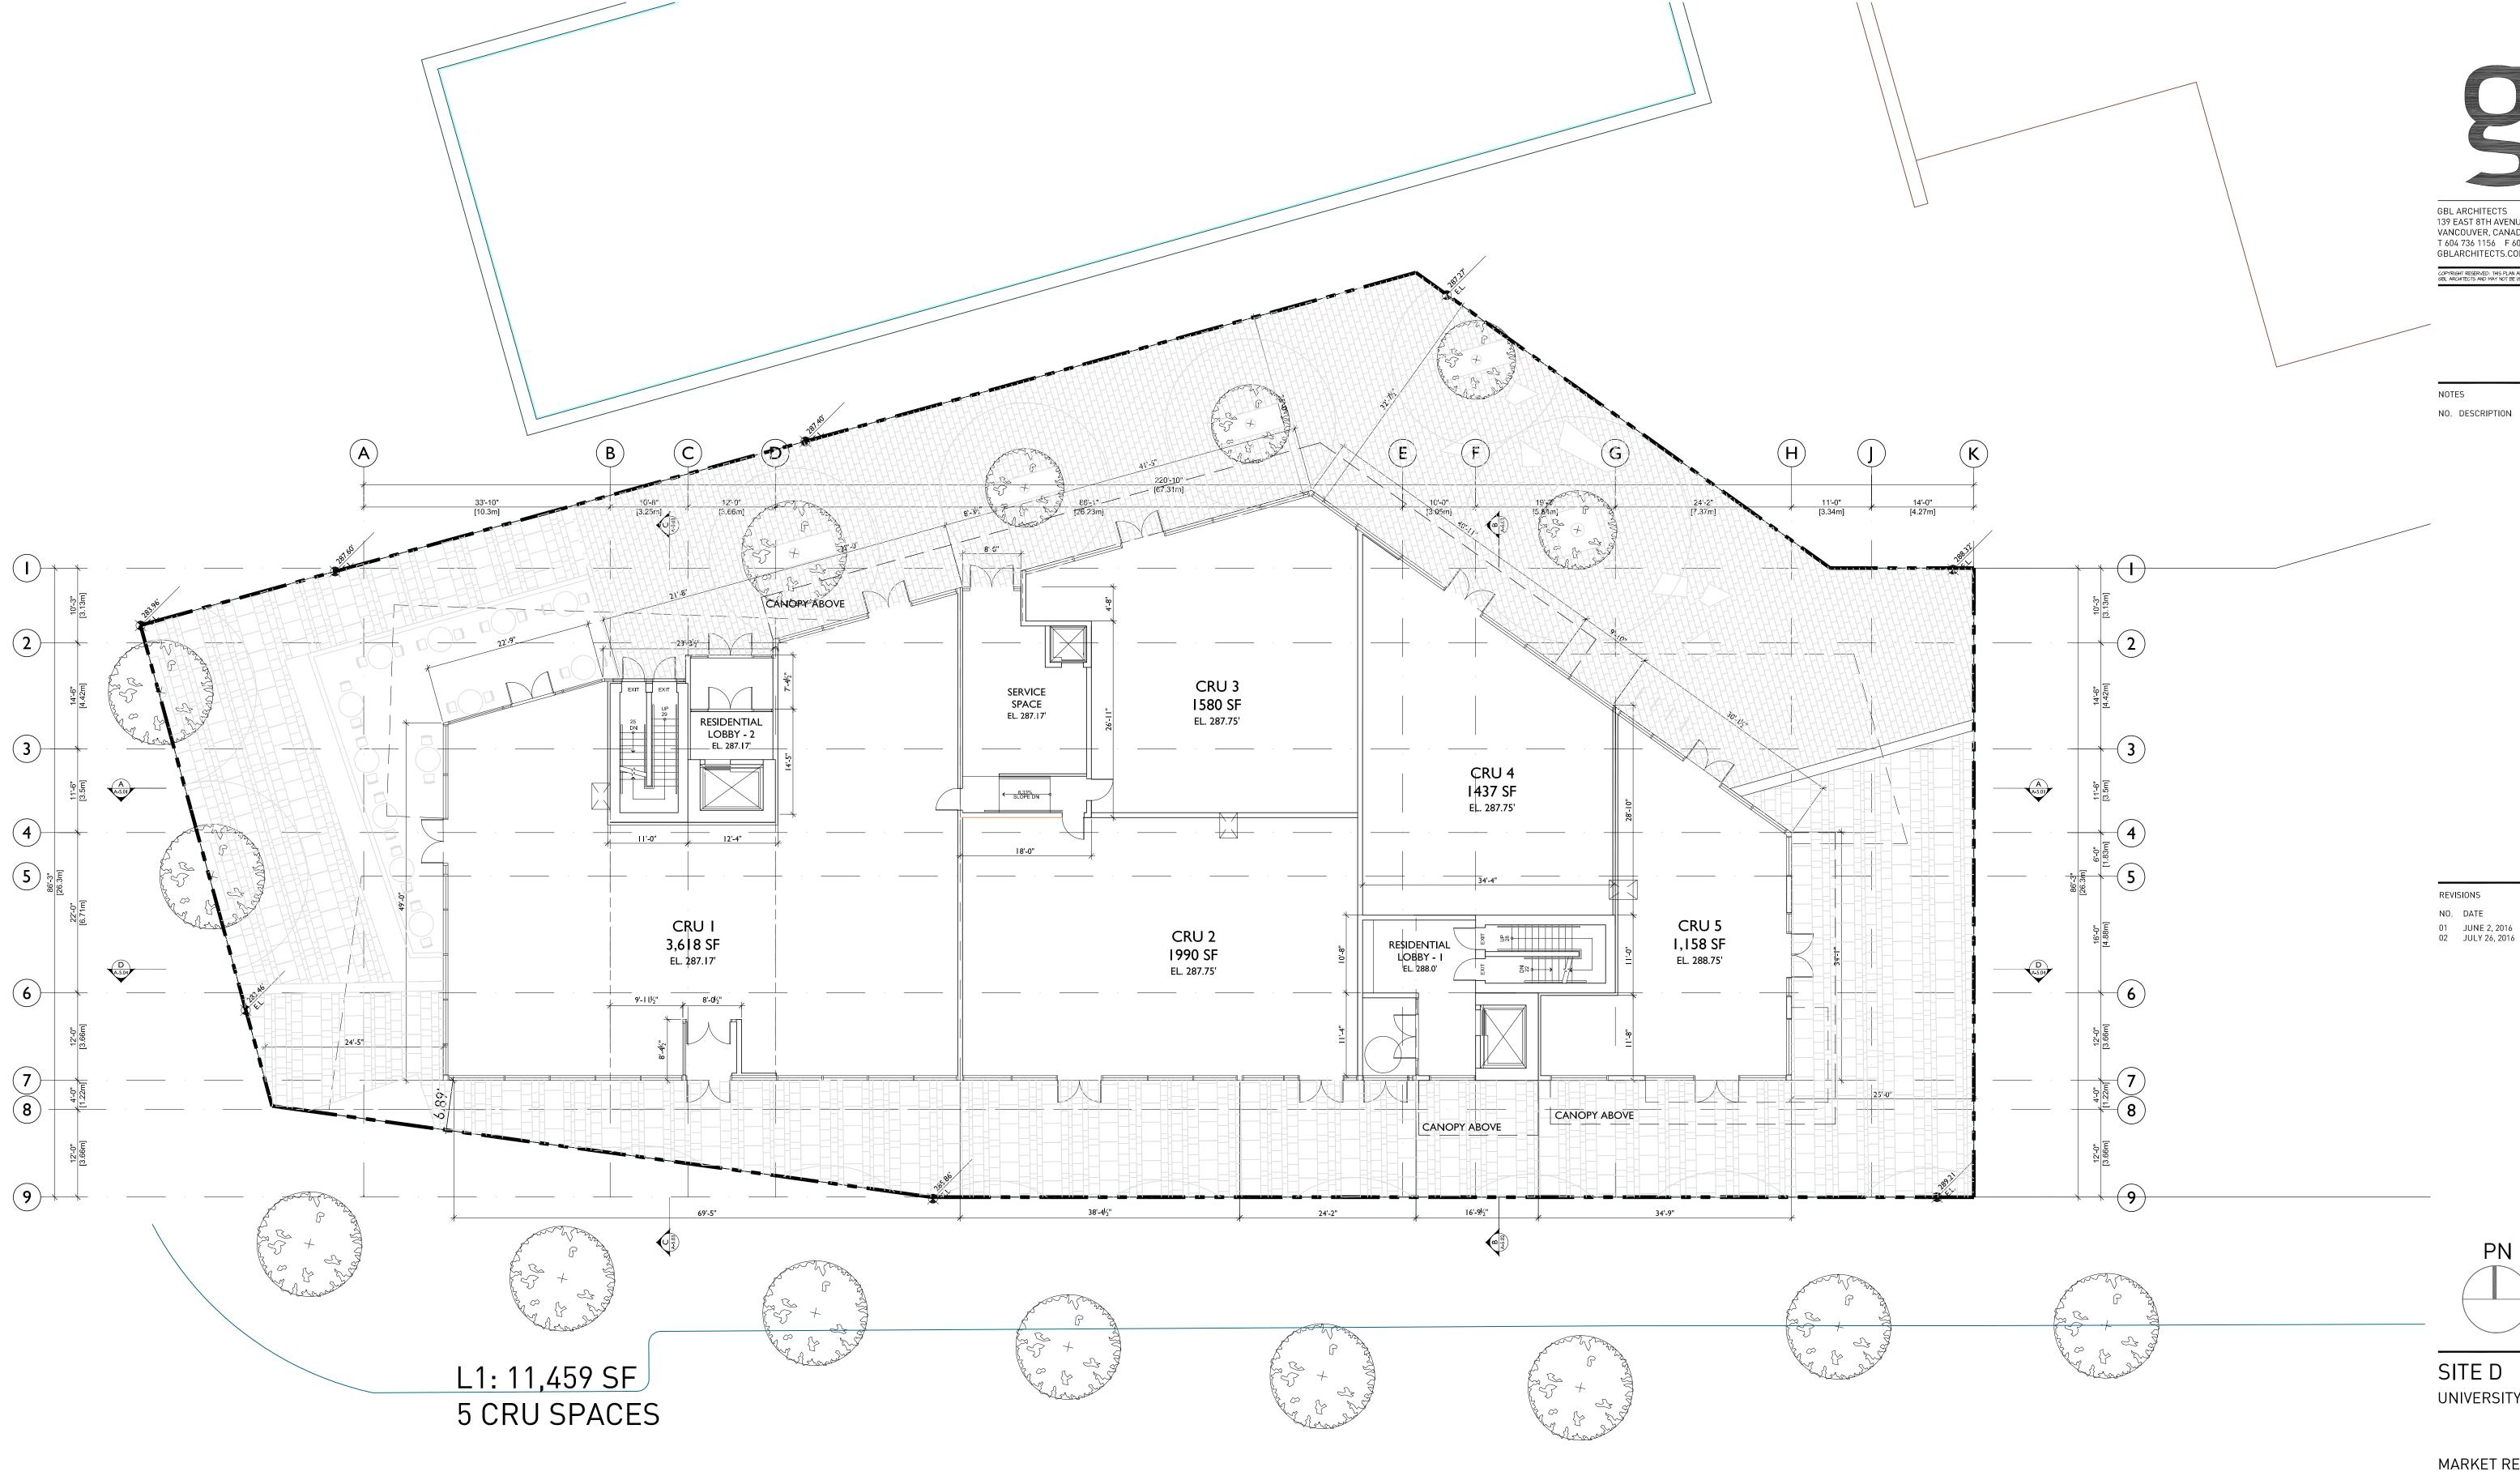



COPYRIGHT RESERVED: THIS PLAN AND DESIGN ARE AND AT ALL TIMES REMAIN THE EXCLUSIVE PROPERTY GBL ARCHITECTS AND MAY NOT BE USED OR REPRODUCED WITHOUT THEIR WRITTEN CONSENT

01 JUNE 2, 2016 DEVELOPMENT PERMIT SUBMISSION
02 JULY 26, 2016 DEVELOPMENT PERMIT
RE-SUBMISSION


UNIVERSITY BOULEVARD, UBC

MARKET RENTAL DEVELOPMENT

LEVEL 1

DATE APRIL 2016 DRAWN BY CHECKED BY 3/32" = 1'-0"

SCALE 1617 JOB NUMBER

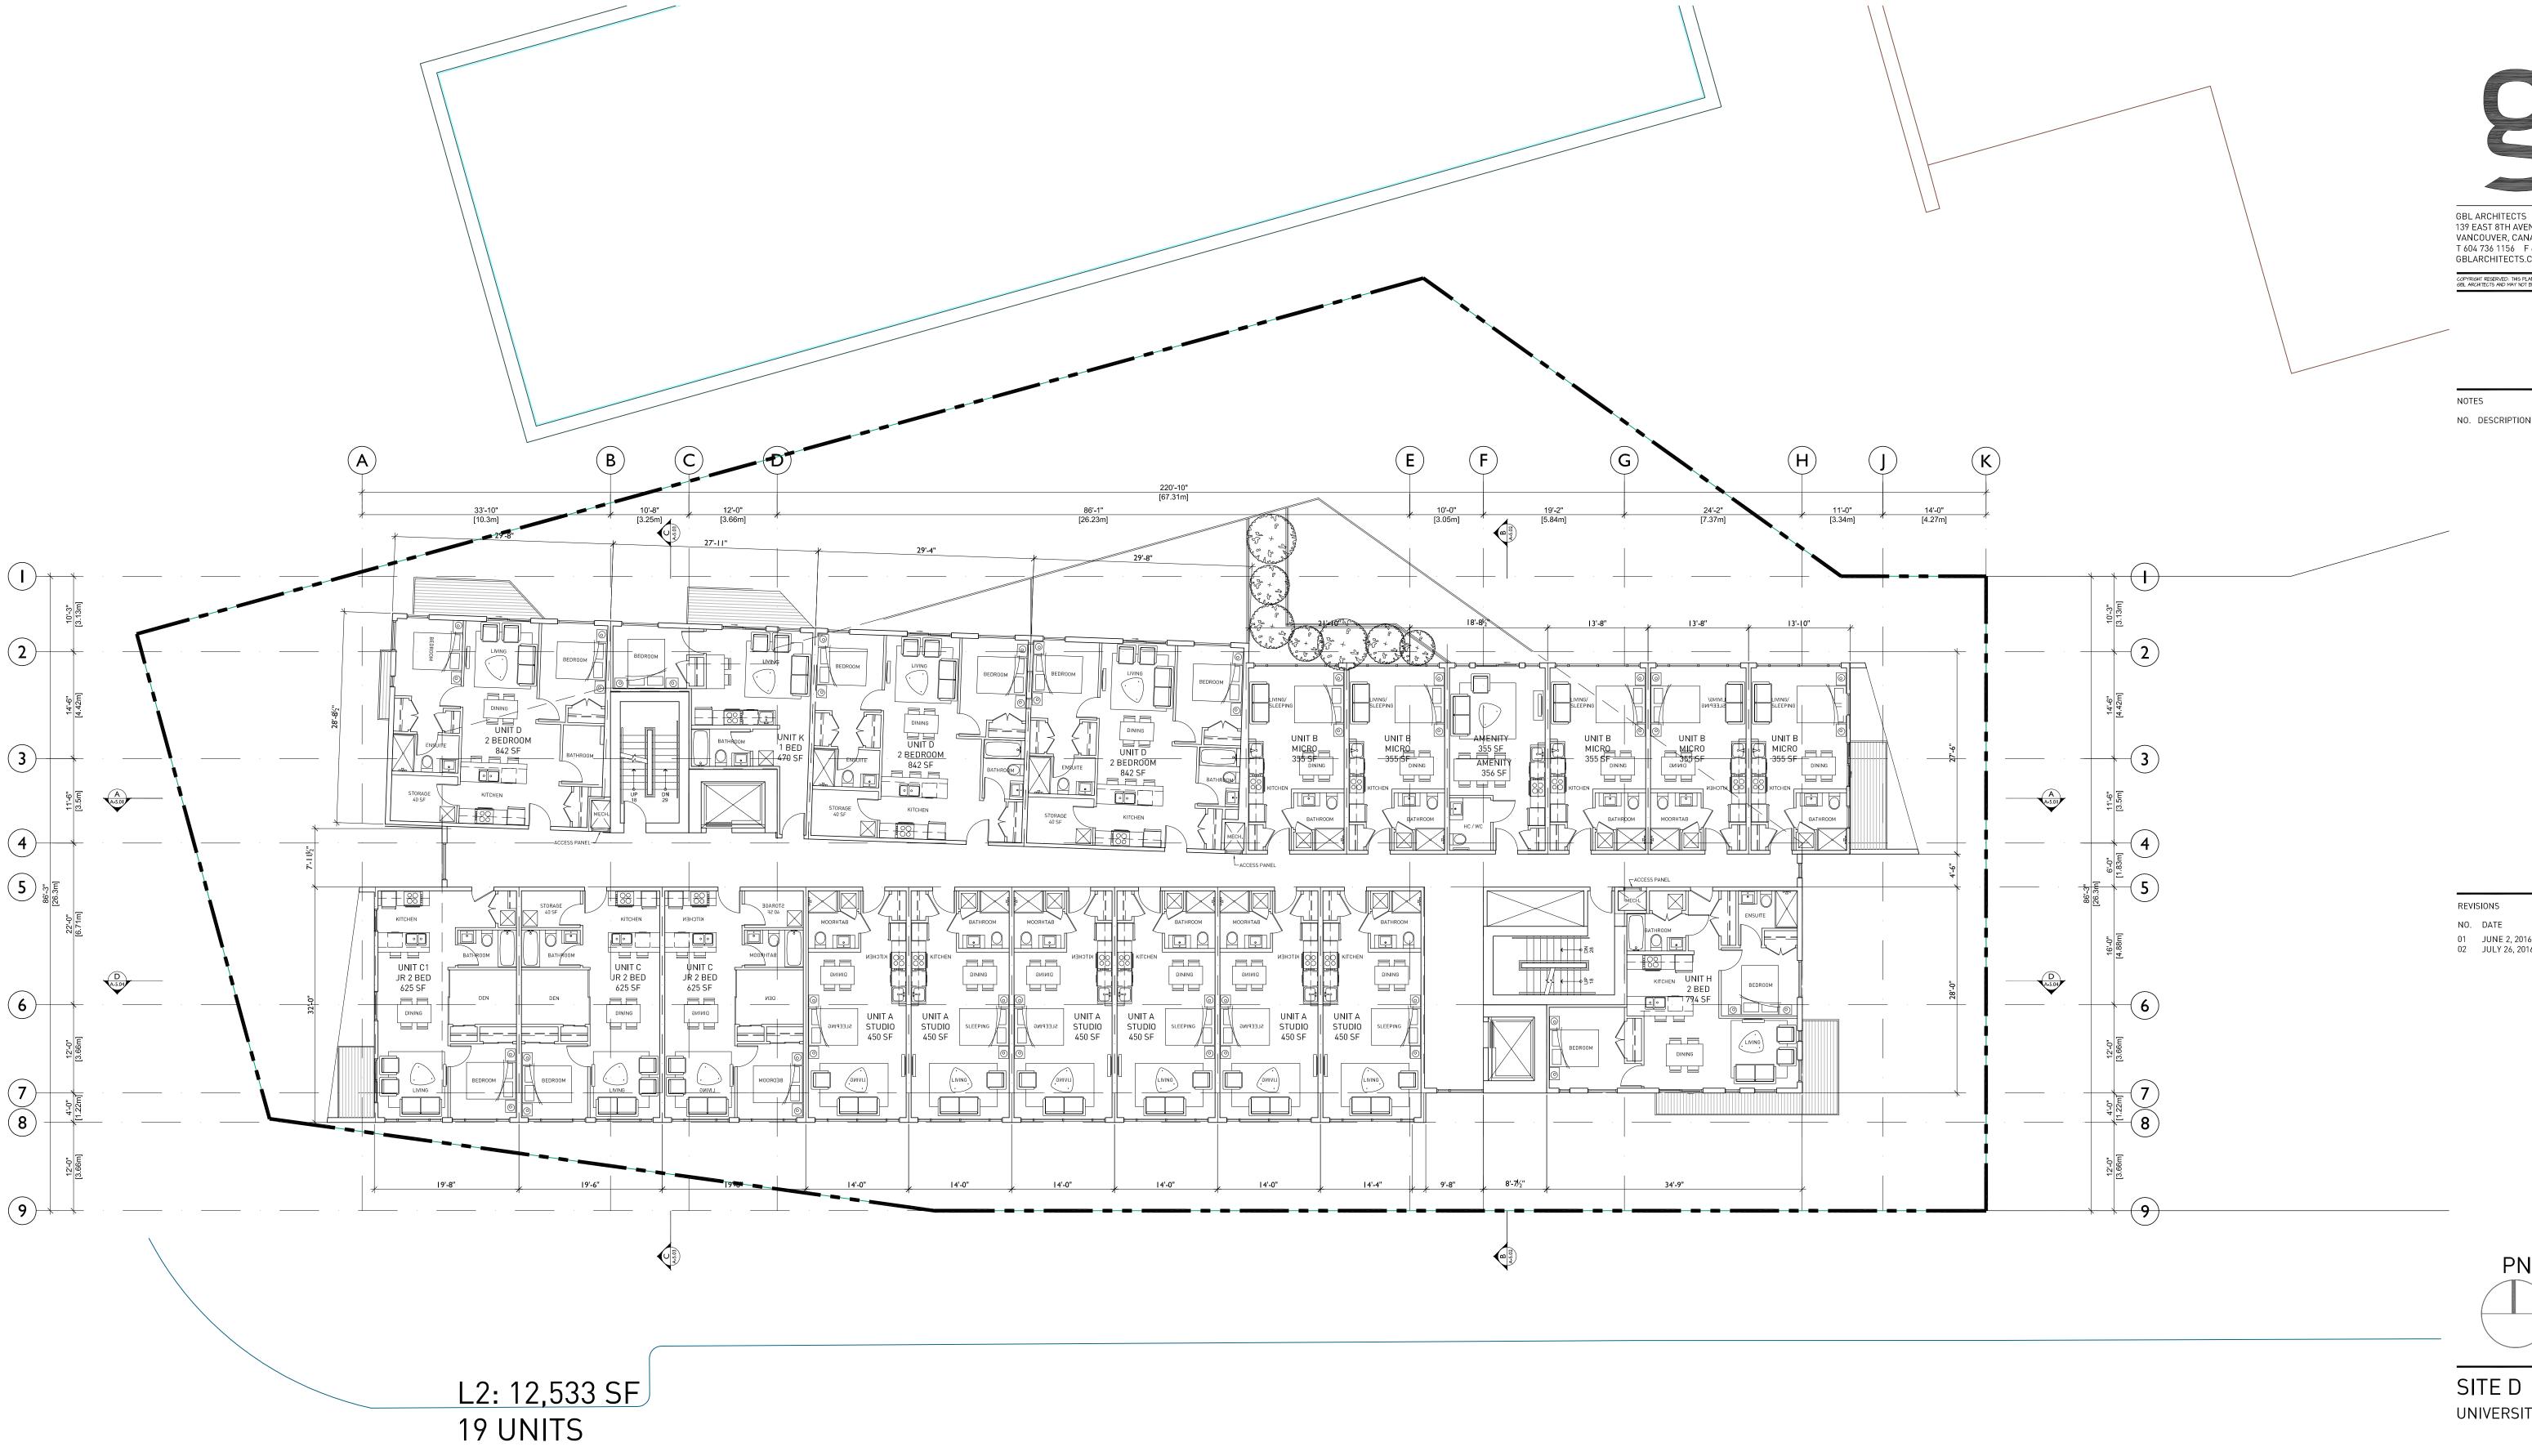



COPYRIGHT RESERVED: THIS PLAN AND DESIGN ARE AND AT ALL TIMES REMAIN THE EXCLUSIVE PROPERTY GBL ARCHITECTS AND MAY NOT BE USED OR REPRODUCED WITHOUT THEIR WRITTEN CONSENT

NO. DESCRIPTION

01 JUNE 2, 2016 DEVELOPMENT PERMIT SUBMISSION
02 JULY 26, 2016 DEVELOPMENT PERMIT
RE-SUBMISSION

PΝ

UNIVERSITY BOULEVARD, UBC

MARKET RENTAL DEVELOPMENT


LEVEL 2

JOB NUMBER

DATE APRIL 2016 DRAWN BY CHECKED BY SCALE 3/32" = 1'-0"

A-3.02

1617

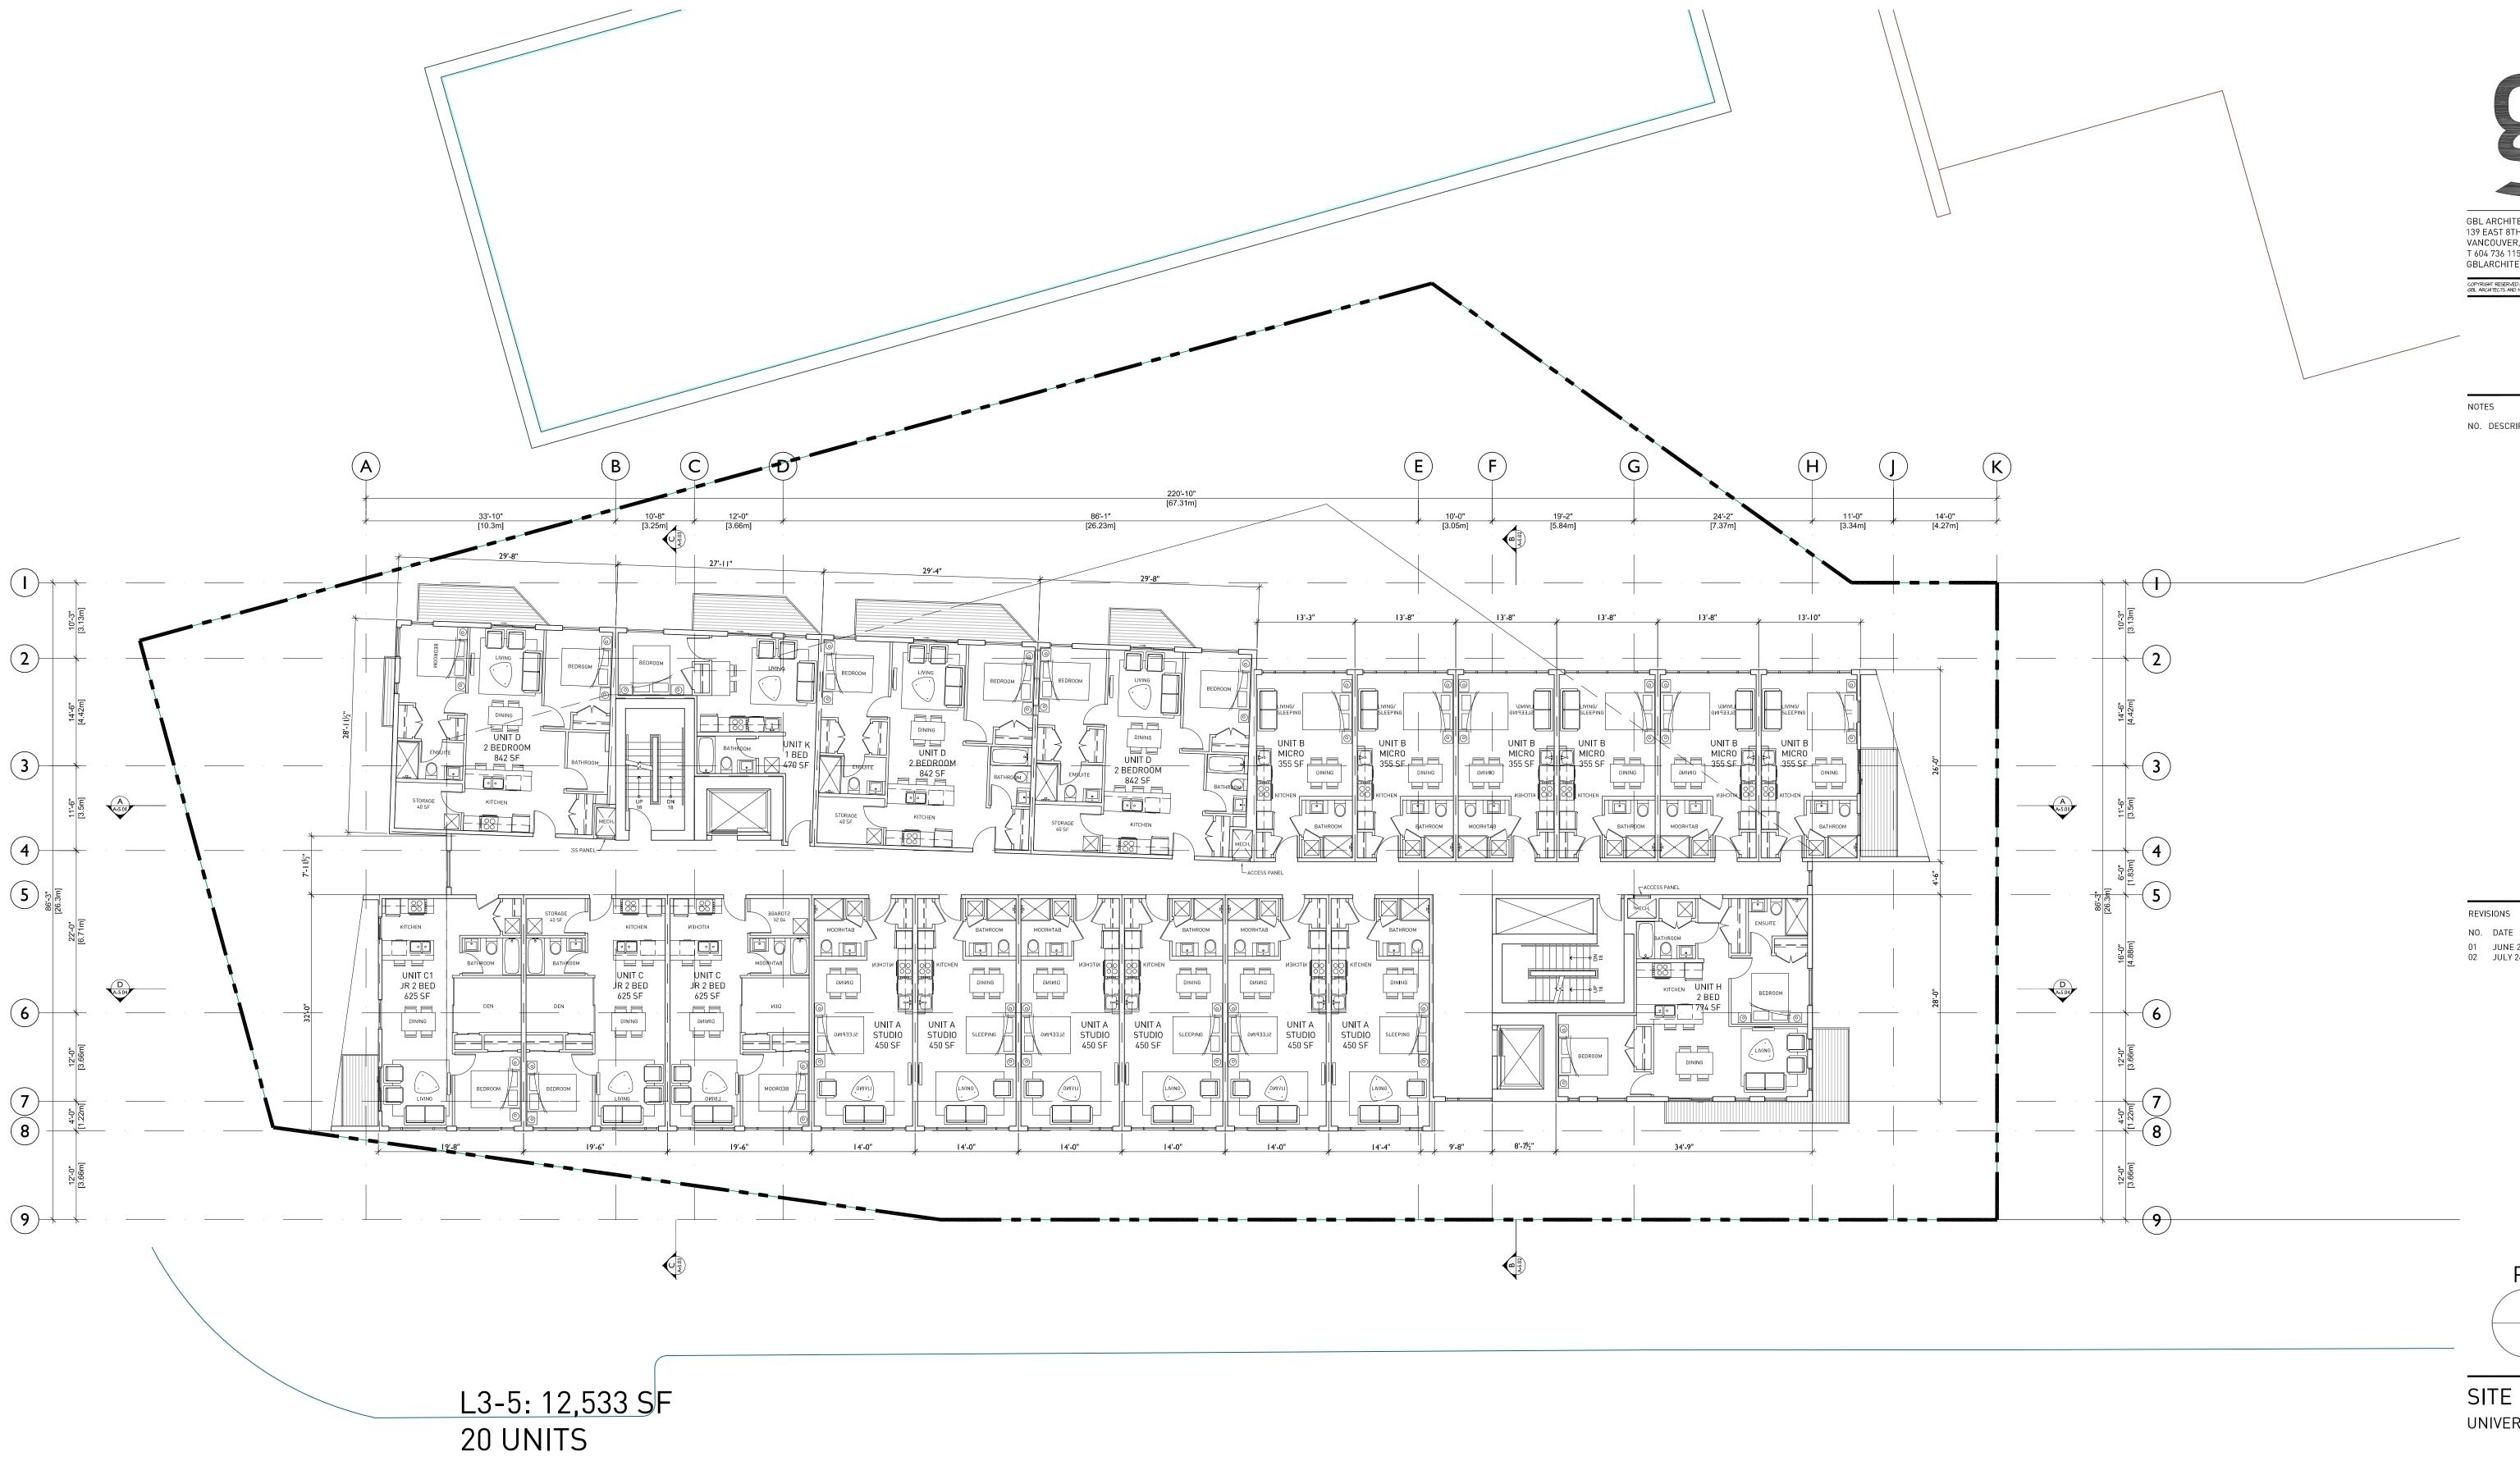



COPYRIGHT RESERVED: THIS PLAN AND DESIGN ARE AND AT ALL TIMES REMAIN THE EXCLUSIVE PROPERTY GBL ARCHITECTS AND MAY NOT BE USED OR REPRODUCED WITHOUT THEIR WRITTEN CONSENT

NO. DESCRIPTION

01 JUNE 2, 2016 DEVELOPMENT PERMIT SUBMISSION
02 JULY 26, 2016 DEVELOPMENT PERMIT
RE-SUBMISSION

PΝ

SITE D


UNIVERSITY BOULEVARD, UBC

MARKET RENTAL DEVELOPMENT

LEVELS 3-5

DATE APRIL 2016 DRAWN BY CHECKED BY SCALE 3/32" = 1'-0"

1617 JOB NUMBER

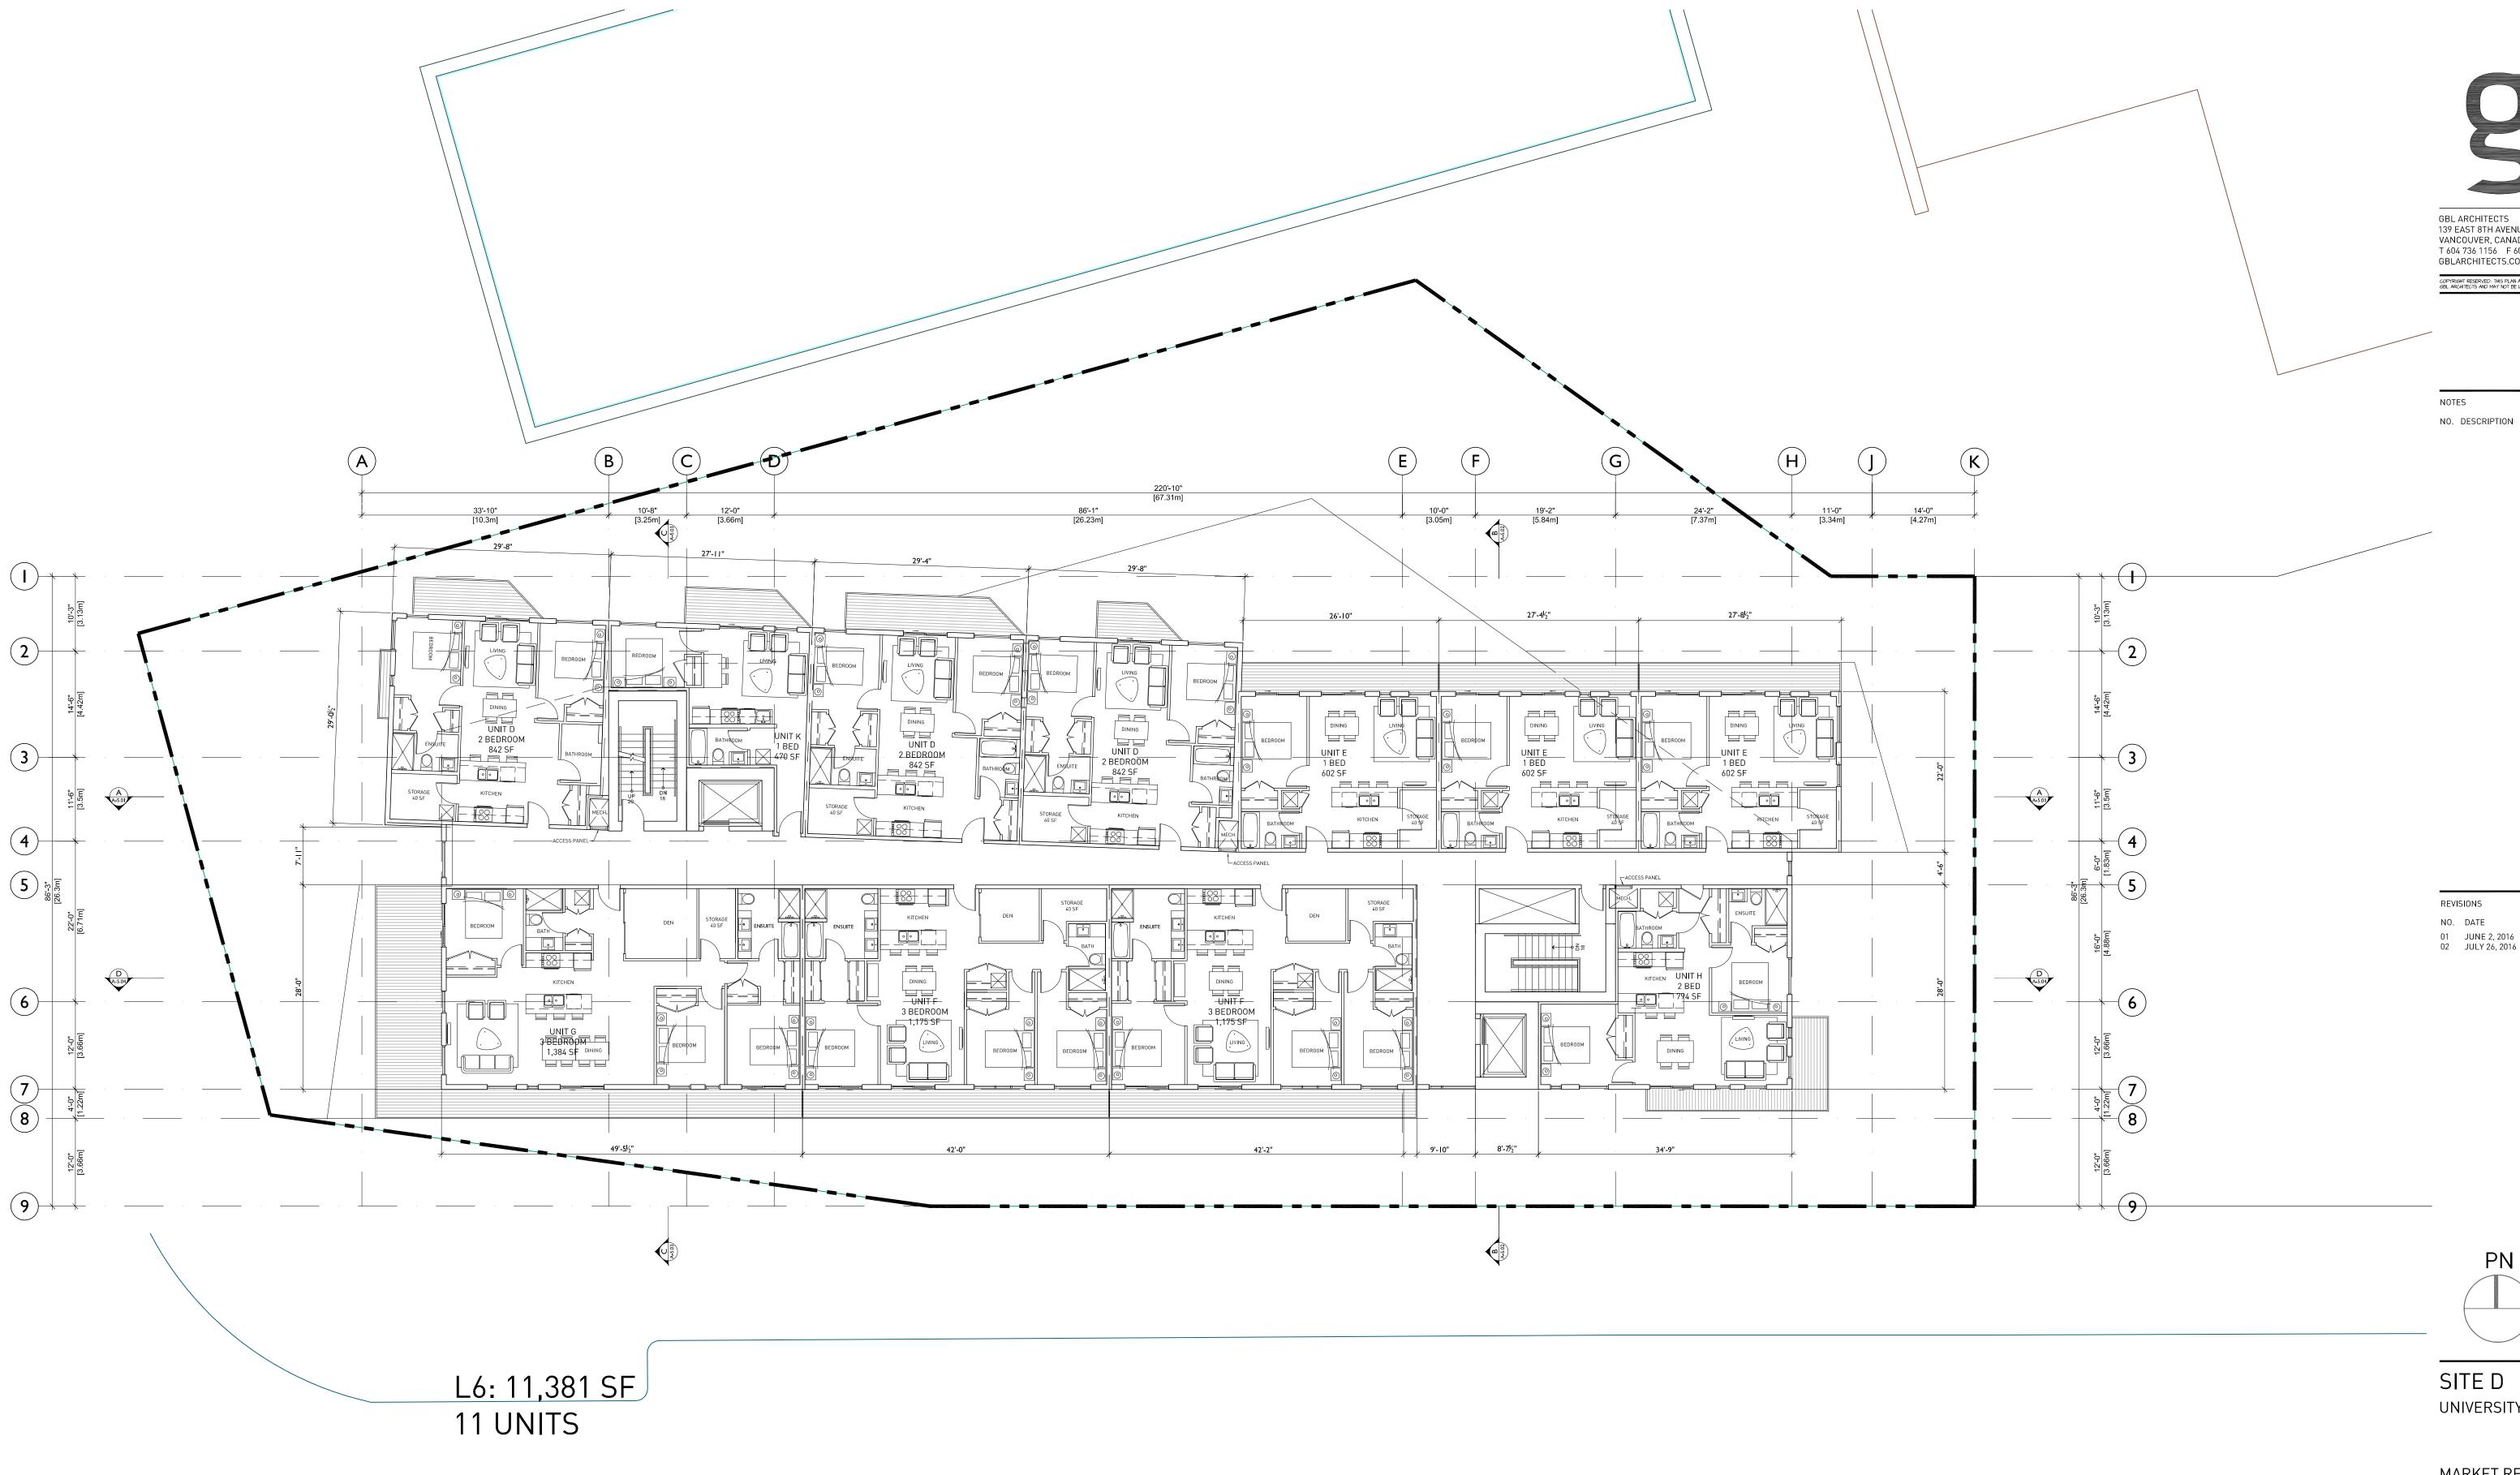

COPYRIGHT RESERVED: THIS PLAN AND DESIGN ARE AND AT ALL TIMES REMAIN THE EXCLUSIVE PROPERTY GBL ARCHITECTS AND MAY NOT BE USED OR REPRODUCED WITHOUT THEIR WRITTEN CONSENT

01 JUNE 2, 2016 DEVELOPMENT PERMIT SUBMISSION
02 JULY 26, 2016 DEVELOPMENT PERMIT
RE-SUBMISSION

PΝ


UNIVERSITY BOULEVARD, UBC

MARKET RENTAL DEVELOPMENT

LEVEL 6

APRIL 2016 DRAWN BY CHECKED BY 3/32" = 1'-0" SCALE

1617 JOB NUMBER

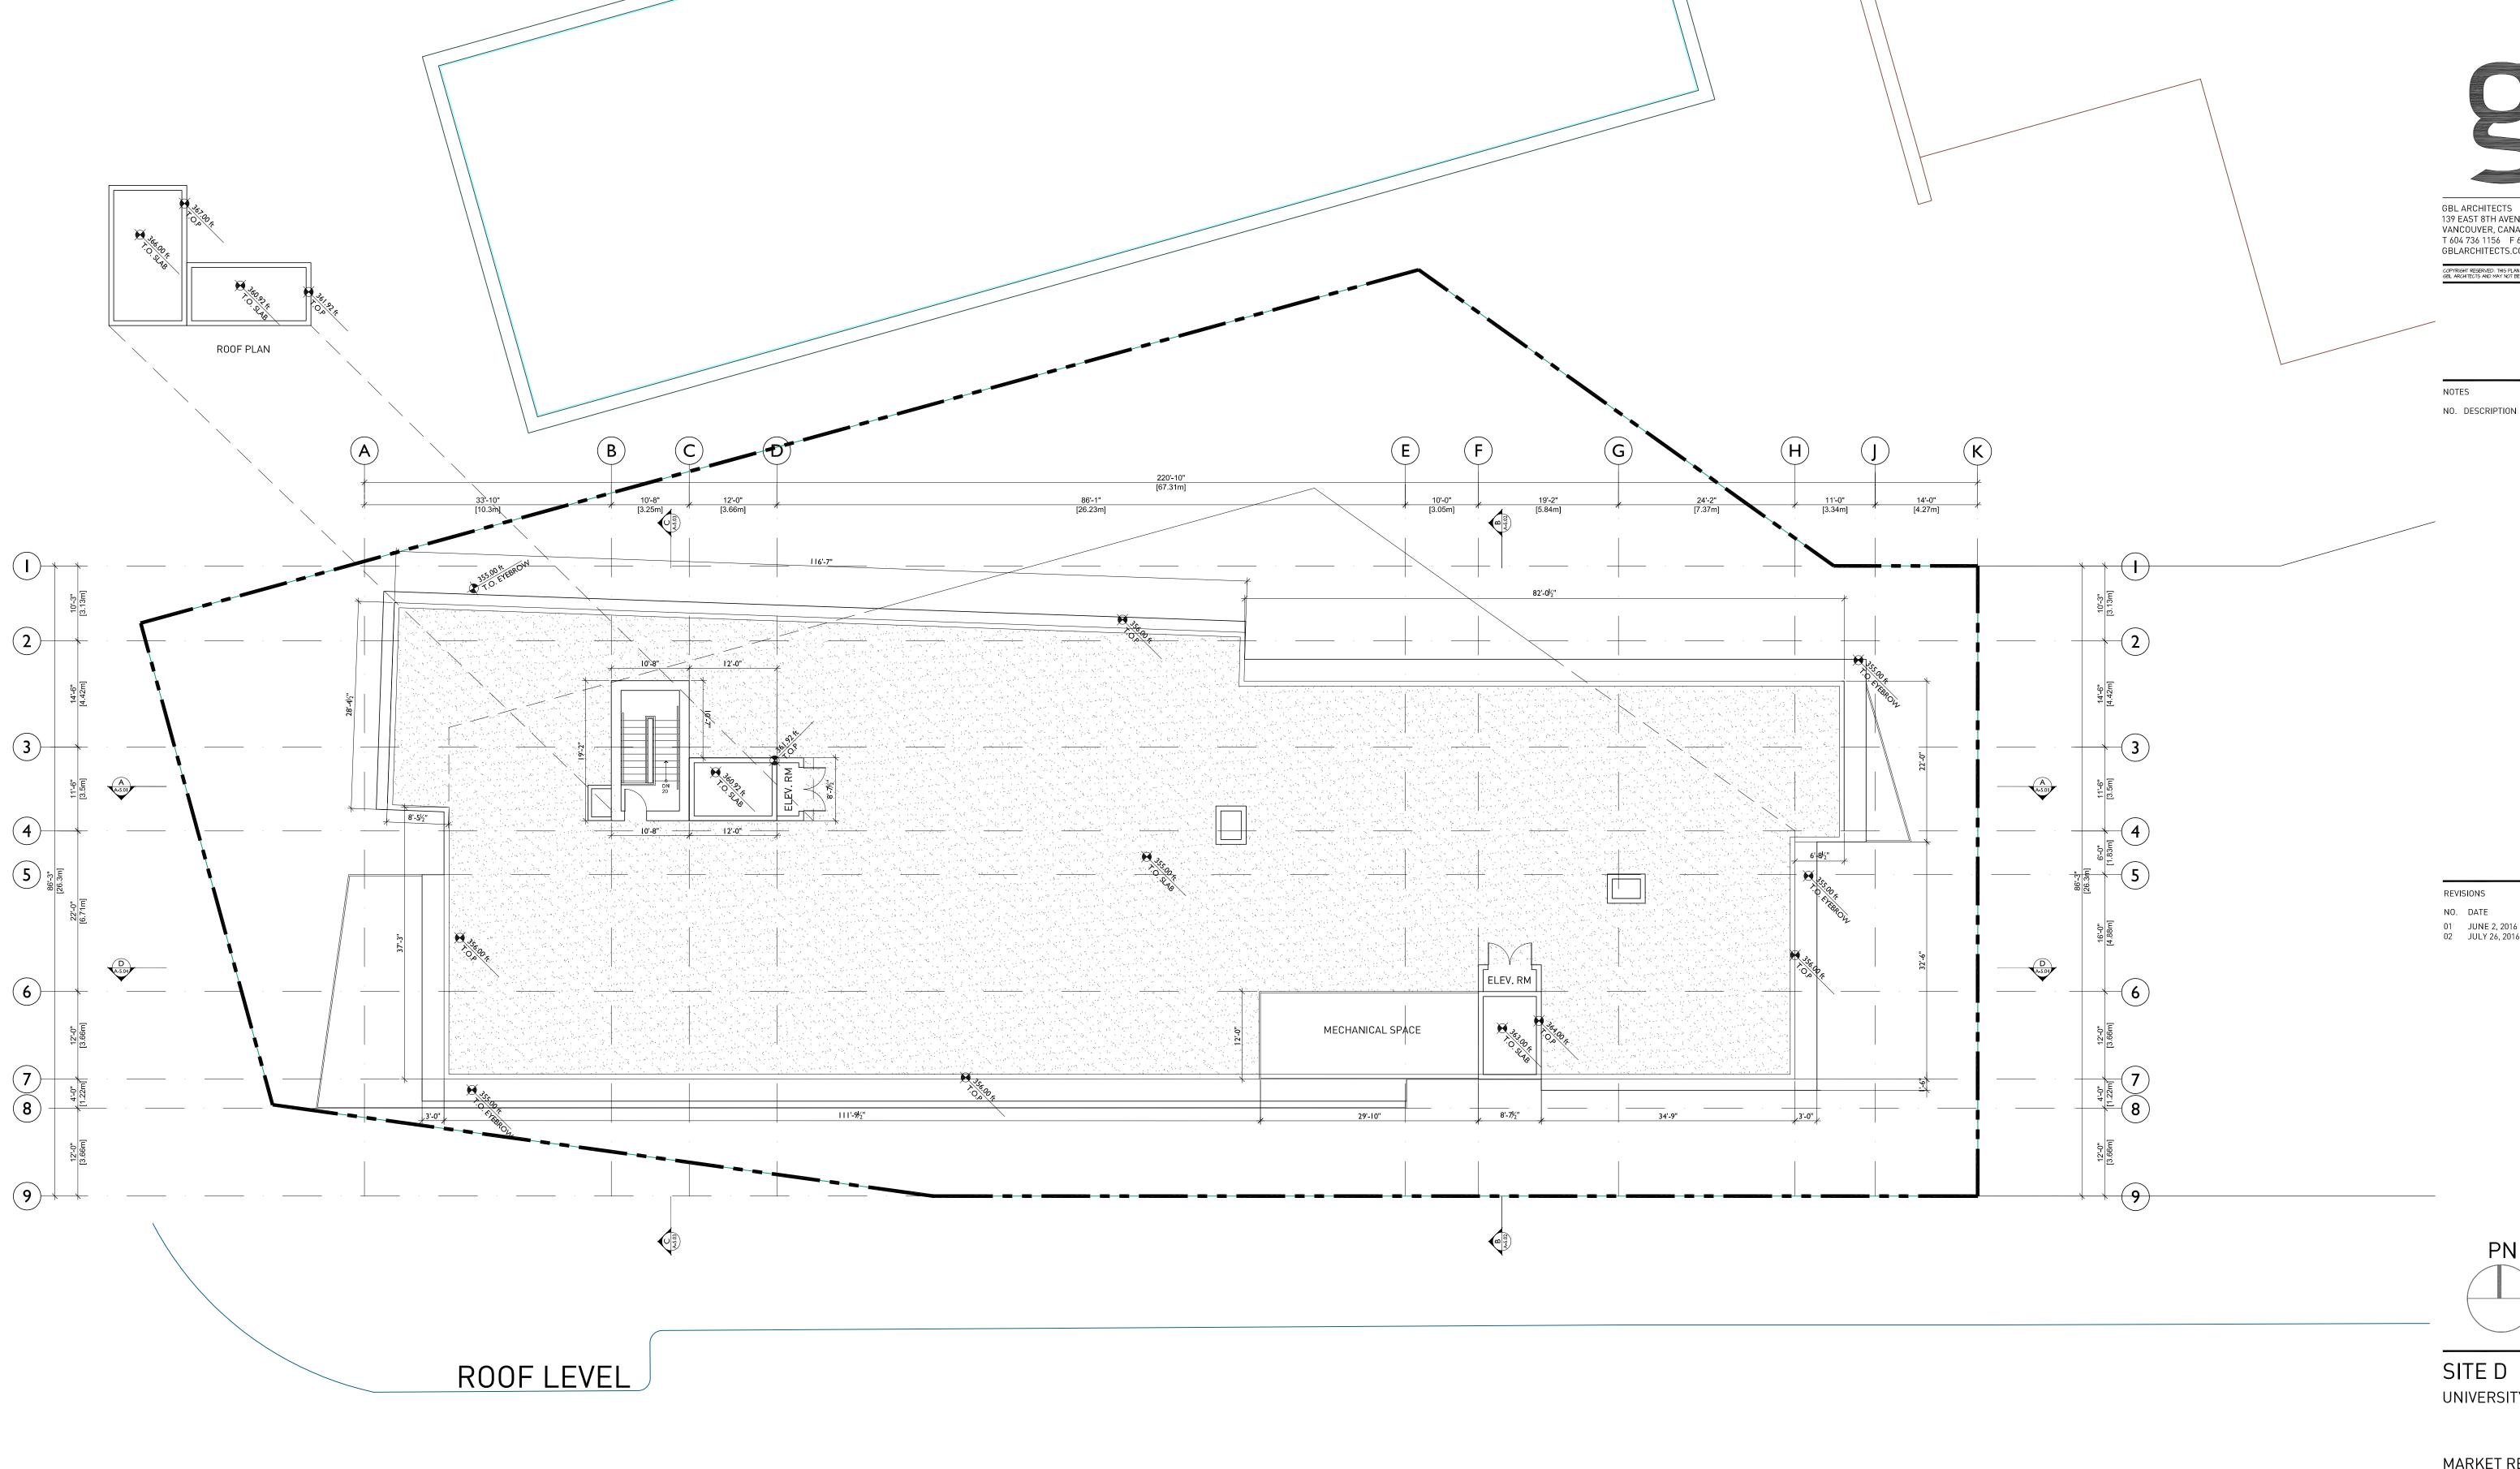



COPYRIGHT RESERVED: THIS PLAN AND DESIGN ARE AND AT ALL TIMES REMAIN THE EXCLUSIVE PROPERTY (GBL ARCHITECTS AND MAY NOT BE USED OR REPRODUCED WITHOUT THEIR WRITTEN CONSENT

NO. DESCRIPTION

01 JUNE 2, 2016 DEVELOPMENT PERMIT SUBMISSION
02 JULY 26, 2016 DEVELOPMENT PERMIT
RE-SUBMISSION

PN

UNIVERSITY BOULEVARD, UBC

MARKET RENTAL DEVELOPMENT


ROOF PLAN

APRIL 2016 DRAWN BY CHECKED BY

3/32" = 1'-0" SCALE 1617 JOB NUMBER



COPYRIGHT RESERVED; THIS PLAN AND DESIGN ARE AND AT ALL TIMES REMAIN THE EXCLUSIVE PROPERTY OF GBL ARCHITECTS AND MAY NOT BE USED OR REPRODUCED WITHOUT THEIR WRITTEN CONSENT

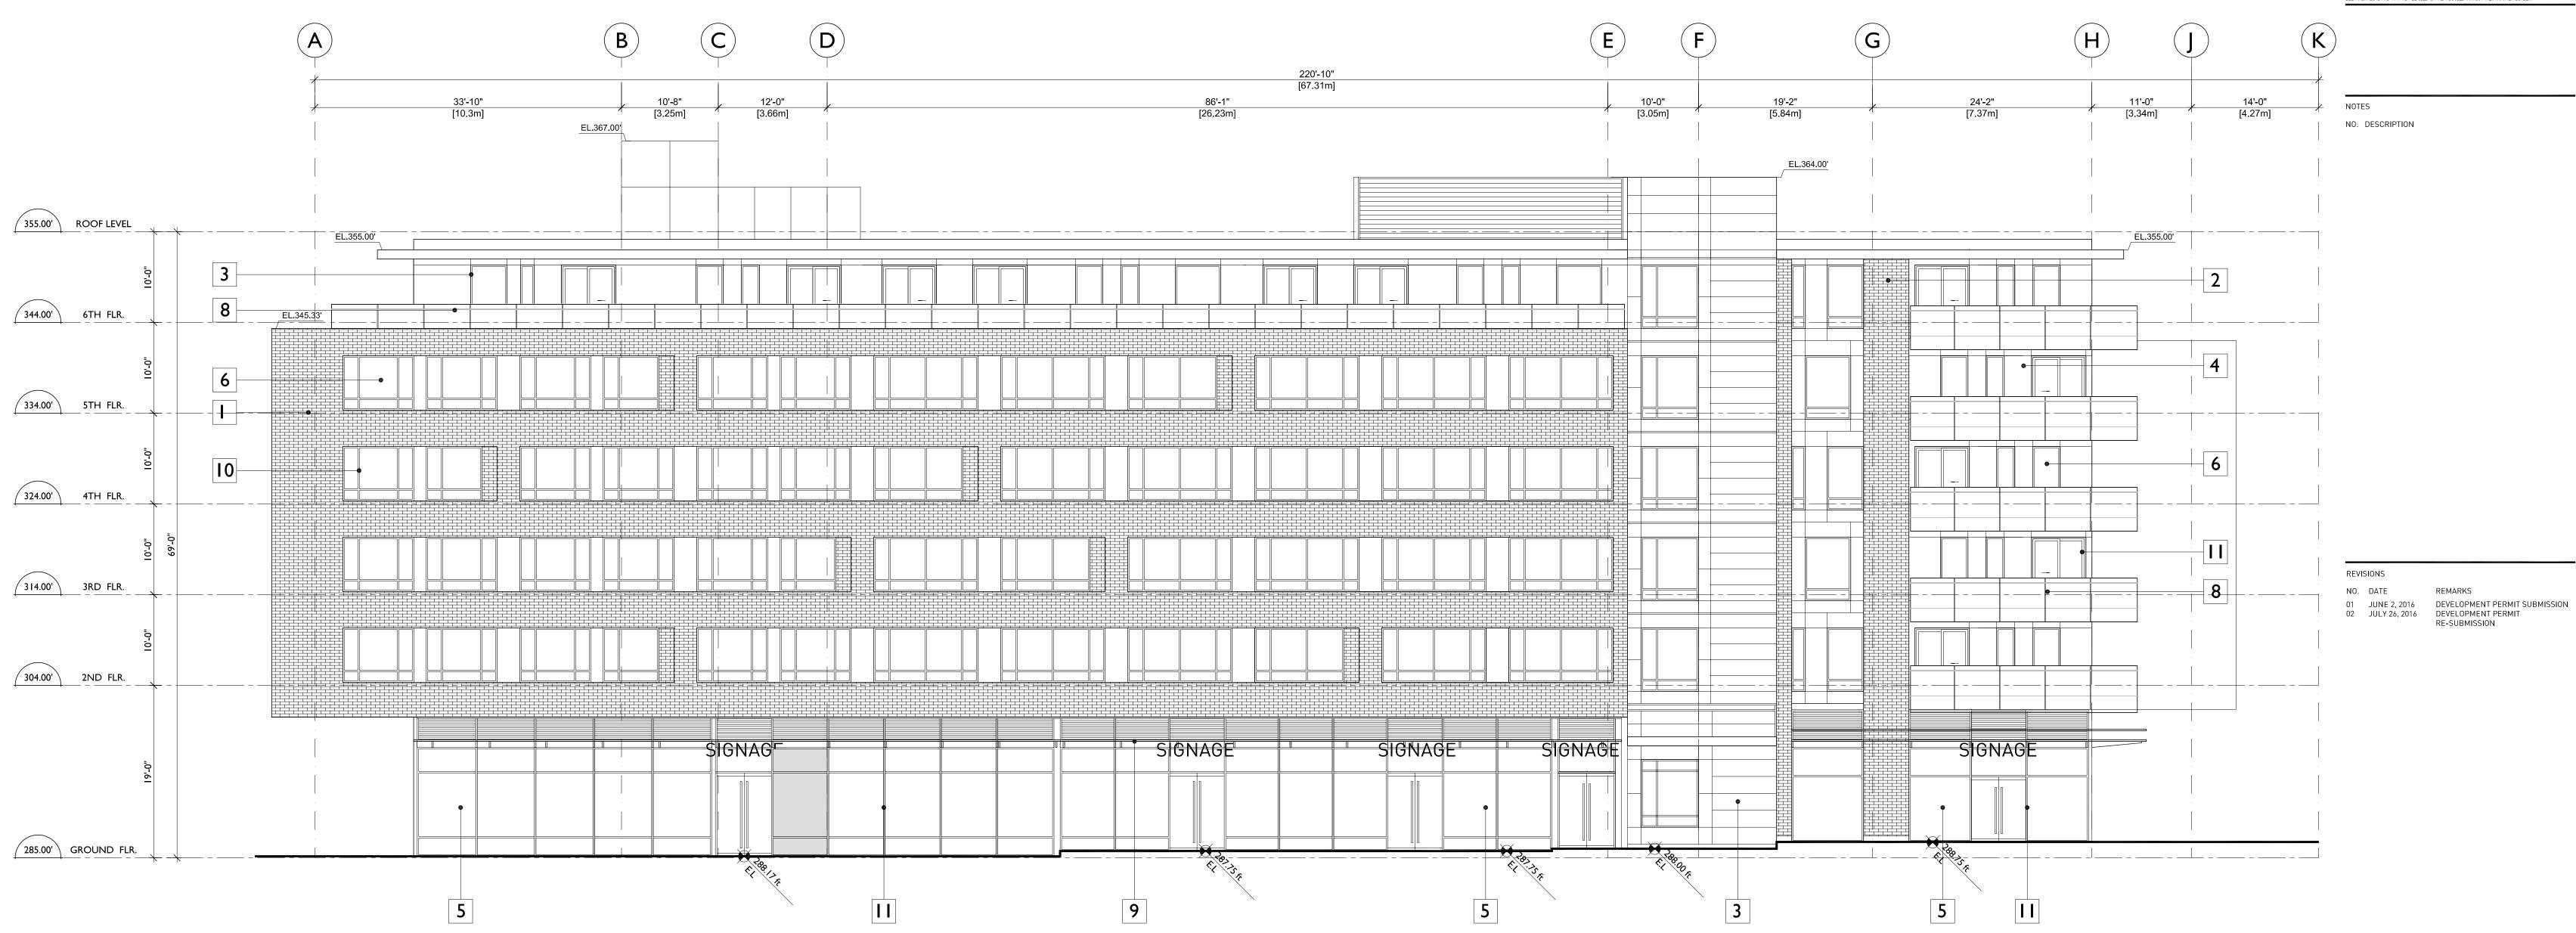

MATERIALS

WHITE BRICK

CHARCOAL BRICK

WHITE HARDI 2.0 PANEL CHARCOAL HARDI 2.0 PANEL

STOREFRONT GLAZING

PUNCHED WALL GLAZING

LONGBOARD "WOOD" PANEL CLEAR GLASS BALUSTRADE

CLEAR GLASS CANOPY

SILVER VINYL WINDOW FRAMES

CHARCOAL VINYL WINDOW FRAMES WHITE PAINTED CONCRETE

CHARCOAL STOREFRONT MULLIONS

SITE D

UNIVERSITY BOULEVARD, UBC


MARKET RENTAL DEVELOPMENT

SOUTH ELEVATION

DATE APRIL 2016 DRAWN BY AJE CHECKED BY

SCALE 1/8" = 1'-0" 1617

JOB NUMBER

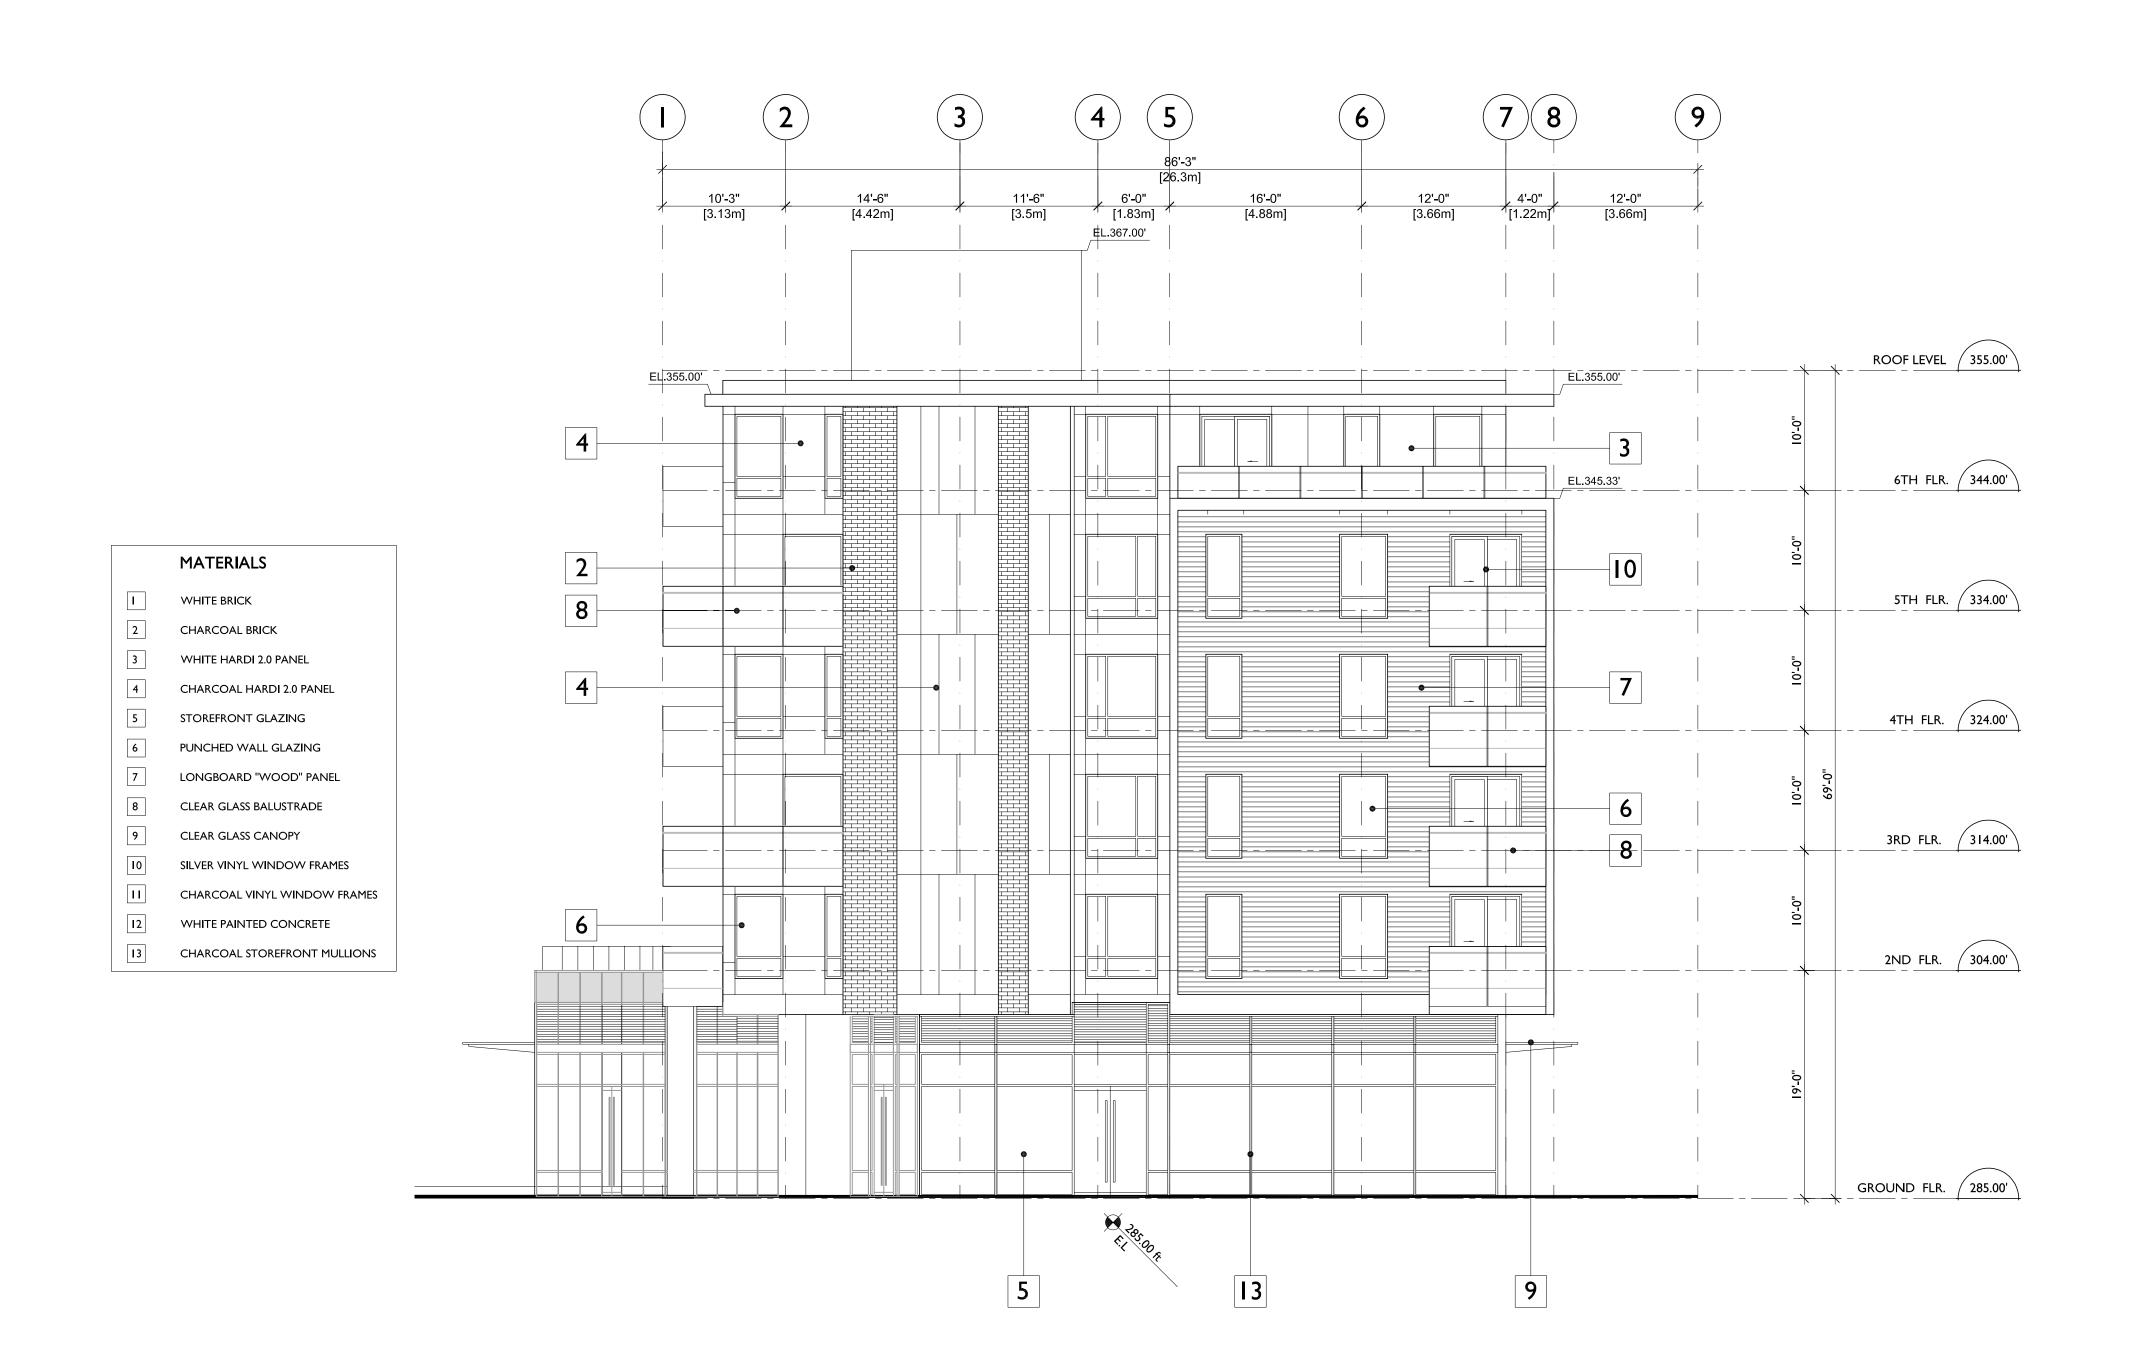



COPYRIGHT RESERVED. THIS PLAN AND DESIGN ARE AND AT ALL TIMES REMAIN THE EXCLUSIVE PROPERTY OF GBL ARCHITECTS AND MAY NOT BE USED OR REPRODUCED WITHOUT THEIR MRITTEN CONSENT

NOTES

NO. DESCRIPTION

REVISIONS

NO. DATE REMARKS

01 JUNE 2, 2016 DEVELOPMENT PERMIT SUBMISSION

02 JULY 26, 2016 DEVELOPMENT PERMIT

RE-SUBMISSION

SITE D

UNIVERSITY BOULEVARD, UBC

MARKET RENTAL DEVELOPMENT

WEST ELEVATION

DATE APRIL 2016
DRAWN BY AJE
CHECKED BY --

SCALE 1/8" = 1'-0"

JOB NUMBER 1617

.



COPYRIGHT RESERVED; THIS PLAN AND DESIGN ARE AND AT ALL TIMES REMAIN THE EXCLUSIVE PROPERTY OF 6BL ARCHITECTS AND MAY NOT BE USED OR REPRODUCED WITHOUT THEIR WRITTEN CONSENT

NOTES

01 JUNE 2, 2016 DEVELOPMENT PERMIT SUBMISSION
02 JULY 26, 2016 DEVELOPMENT PERMIT
RE-SUBMISSION

SITE D


UNIVERSITY BOULEVARD, UBC

MARKET RENTAL DEVELOPMENT

NORTH ELEVATION

DATE APRIL 2016 DRAWN BY AJE

CHECKED BY SCALE 1/8" = 1'-0" 1617 JOB NUMBER

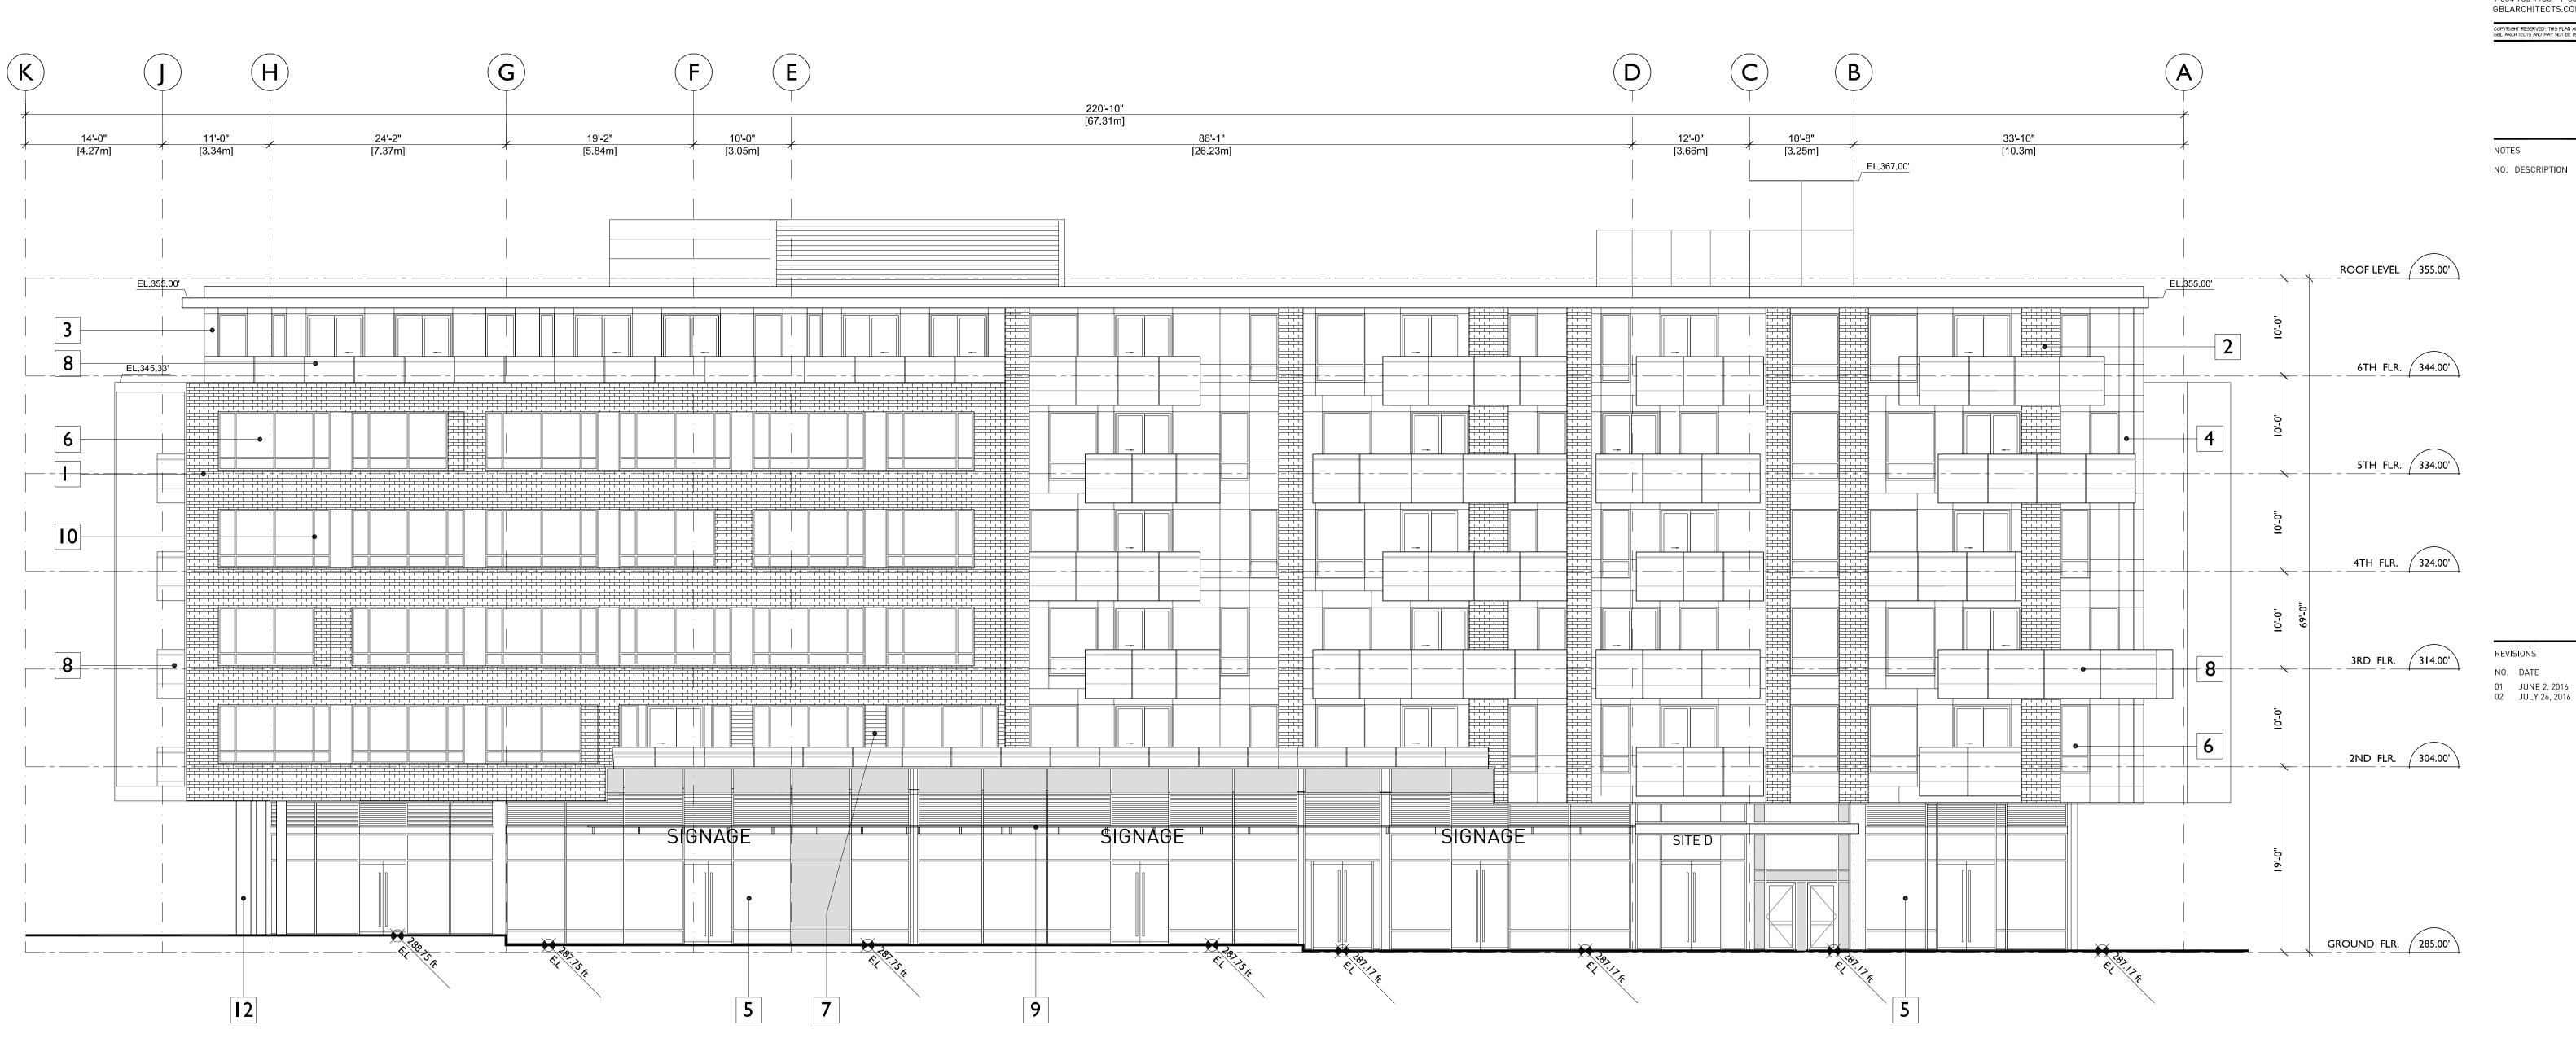

MATERIALS


- WHITE BRICK
- CHARCOAL BRICK
- CHARCOAL HARDI 2.0 PANEL

WHITE HARDI 2.0 PANEL

- STOREFRONT GLAZING
- PUNCHED WALL GLAZING
- CLEAR GLASS BALUSTRADE
- CLEAR GLASS CANOPY
- SILVER VINYL WINDOW FRAMES

LONGBOARD "WOOD" PANEL

- CHARCOAL VINYL WINDOW FRAMES WHITE PAINTED CONCRETE
- CHARCOAL STOREFRONT MULLIONS

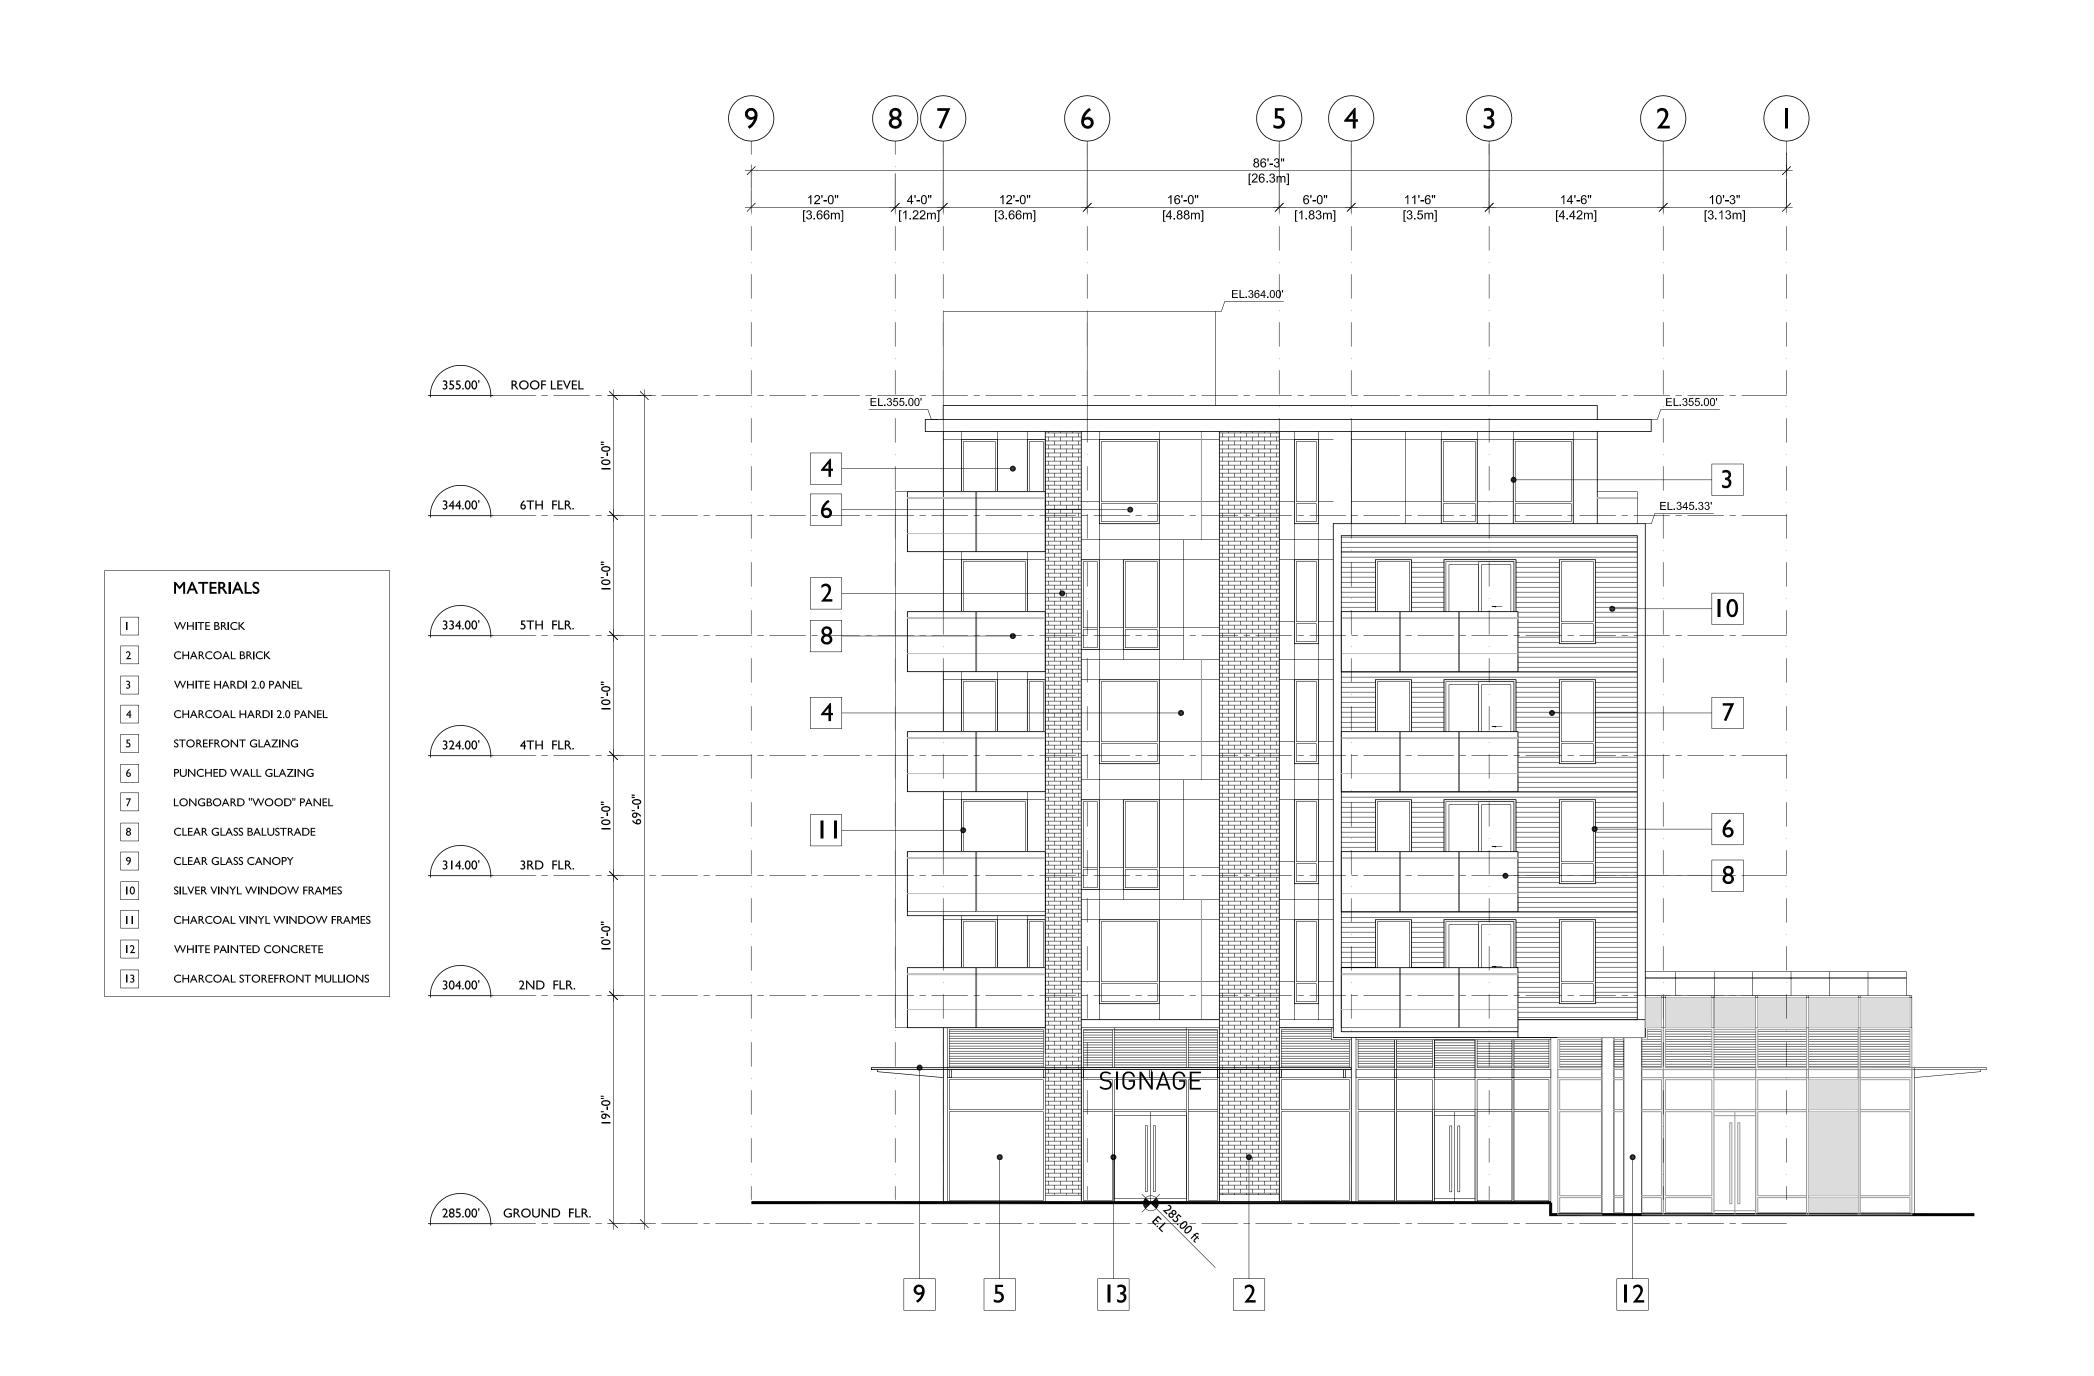



COPYRIGHT RESERVED: THIS PLAN AND DESIGN ARE AND AT ALL TIMES REMAIN THE EXCLUSIVE PROPERTY OF GBL ARCHITECTS AND MAY NOT BE USED OR REPRODUCED WITHOUT THEIR WRITTEN CONSENT

NOTES

NO. DESCRIPTION

REVISIONS

NO. DATE 01 JUNE 2, 2016 DEVELOPMENT PERMIT SUBMISSION
02 JULY 26, 2016 DEVELOPMENT PERMIT
RE-SUBMISSION

SITE D

UNIVERSITY BOULEVARD, UBC

MARKET RENTAL DEVELOPMENT

EAST ELEVATION


DATE APRIL 2016 DRAWN BY AJE CHECKED BY

SCALE 1617 JOB NUMBER

1/8" = 1'-0"



COPYRIGHT RESERVED: THIS PLAN AND DESIGN ARE AND AT ALL TIMES REMAIN THE EXCLUSIVE PROPERTY OF 6BL ARCHITECTS AND MAY NOT BE USED OR REPRODUCED WITHOUT THEIR WRITTEN CONSENT

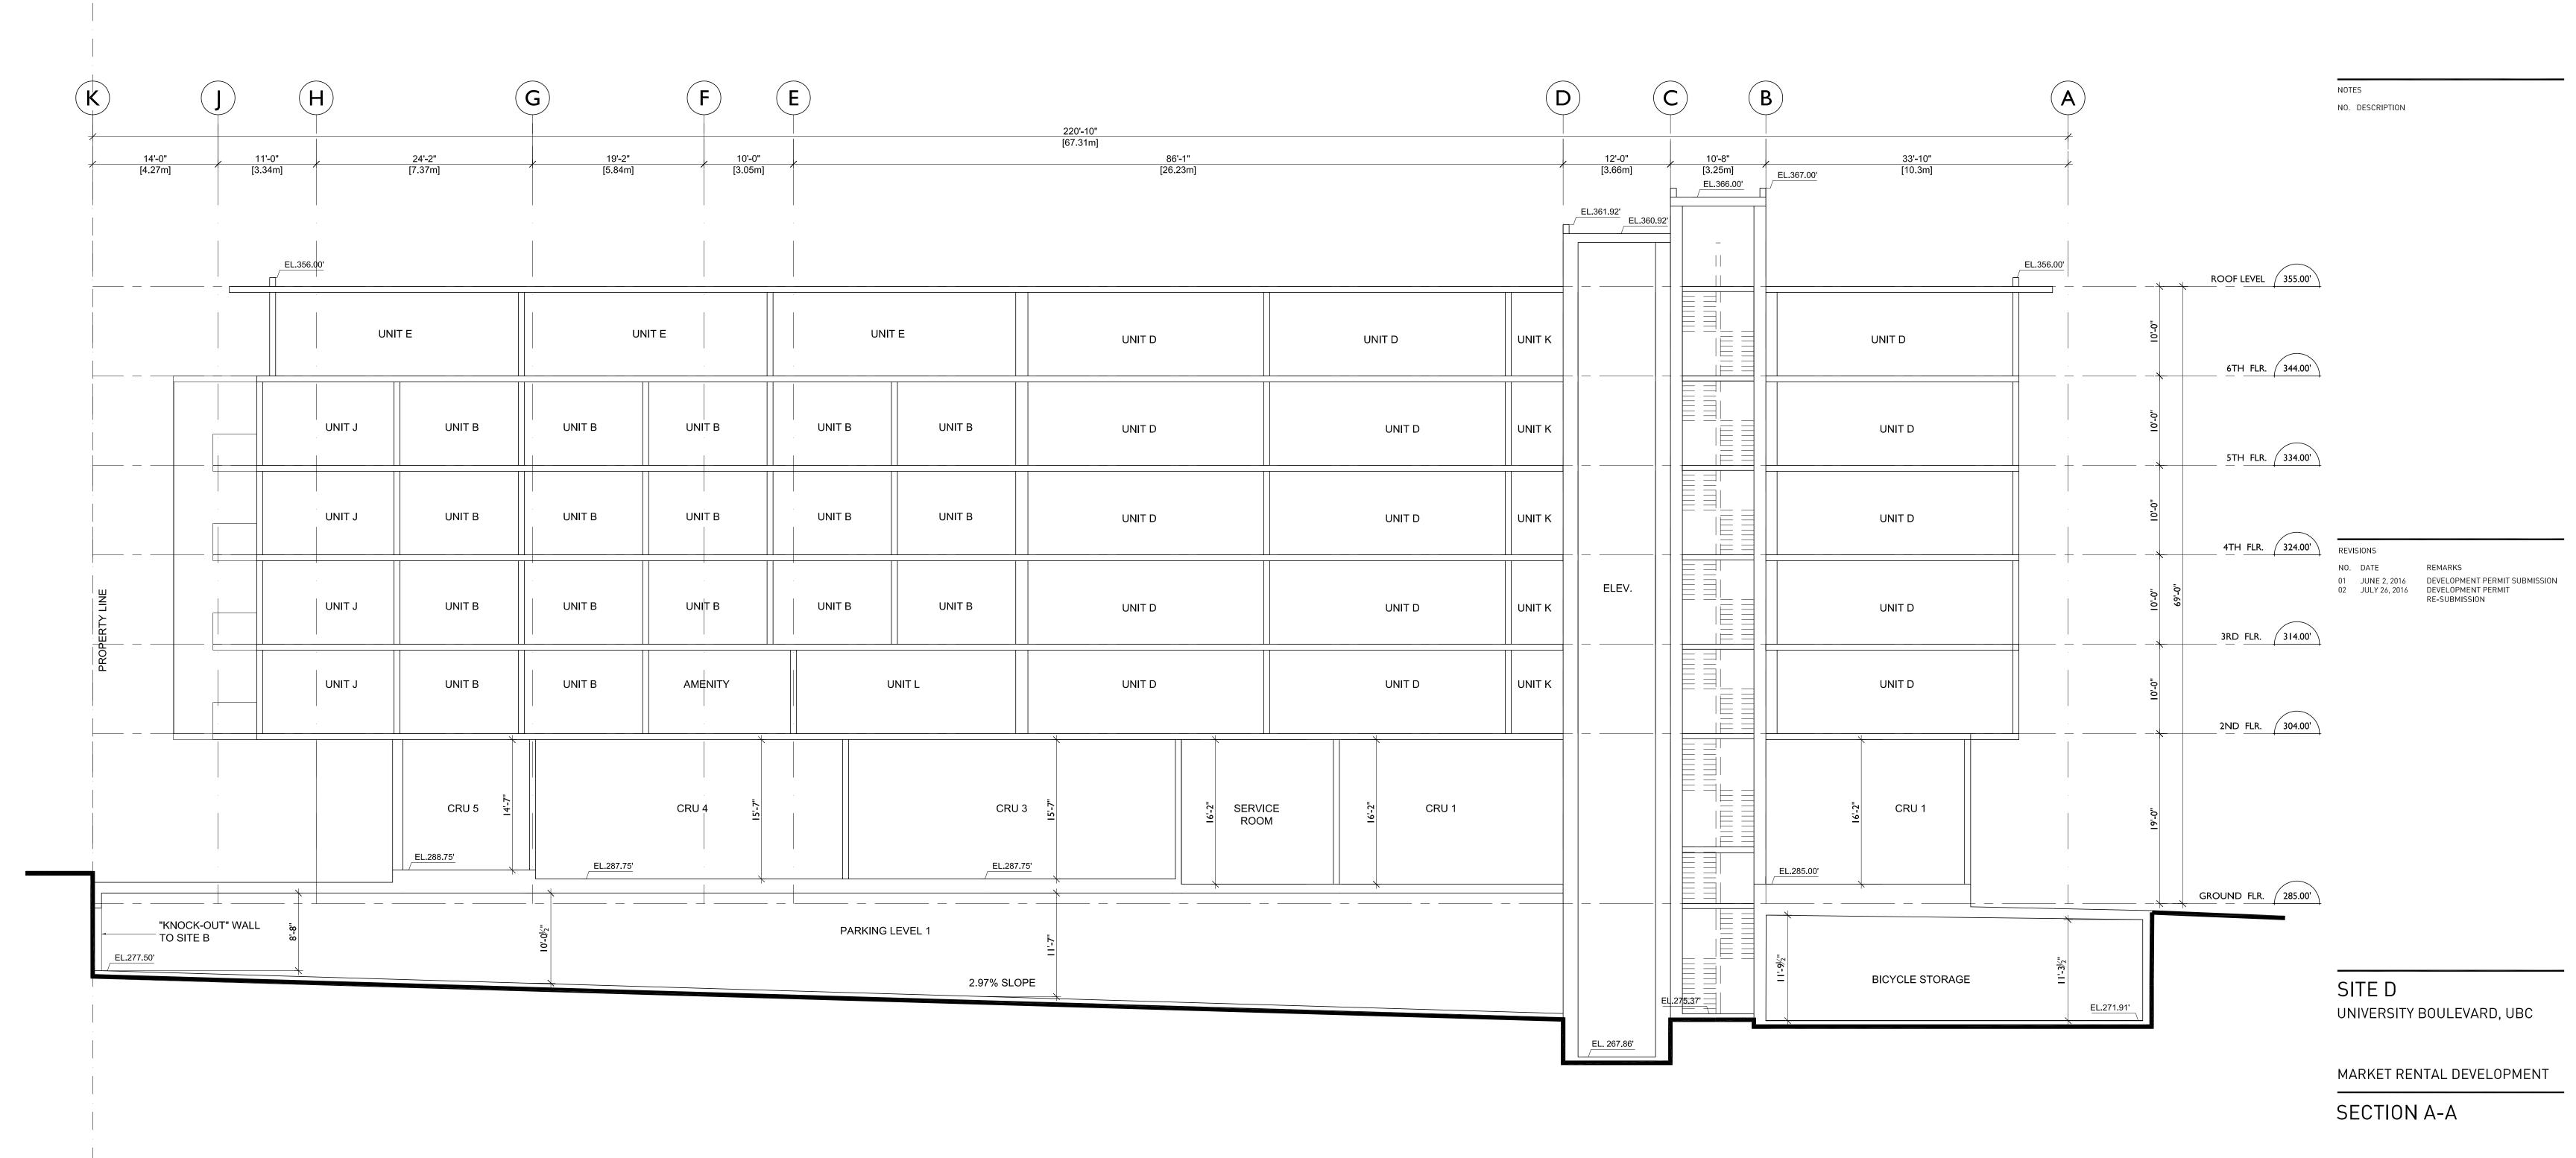

SECTION A

A-5.01

APRIL 2016

1/8" = 1'-0"

1617


AJE

DATE

DRAWN BY

CHECKED BY SCALE

JOB NUMBER

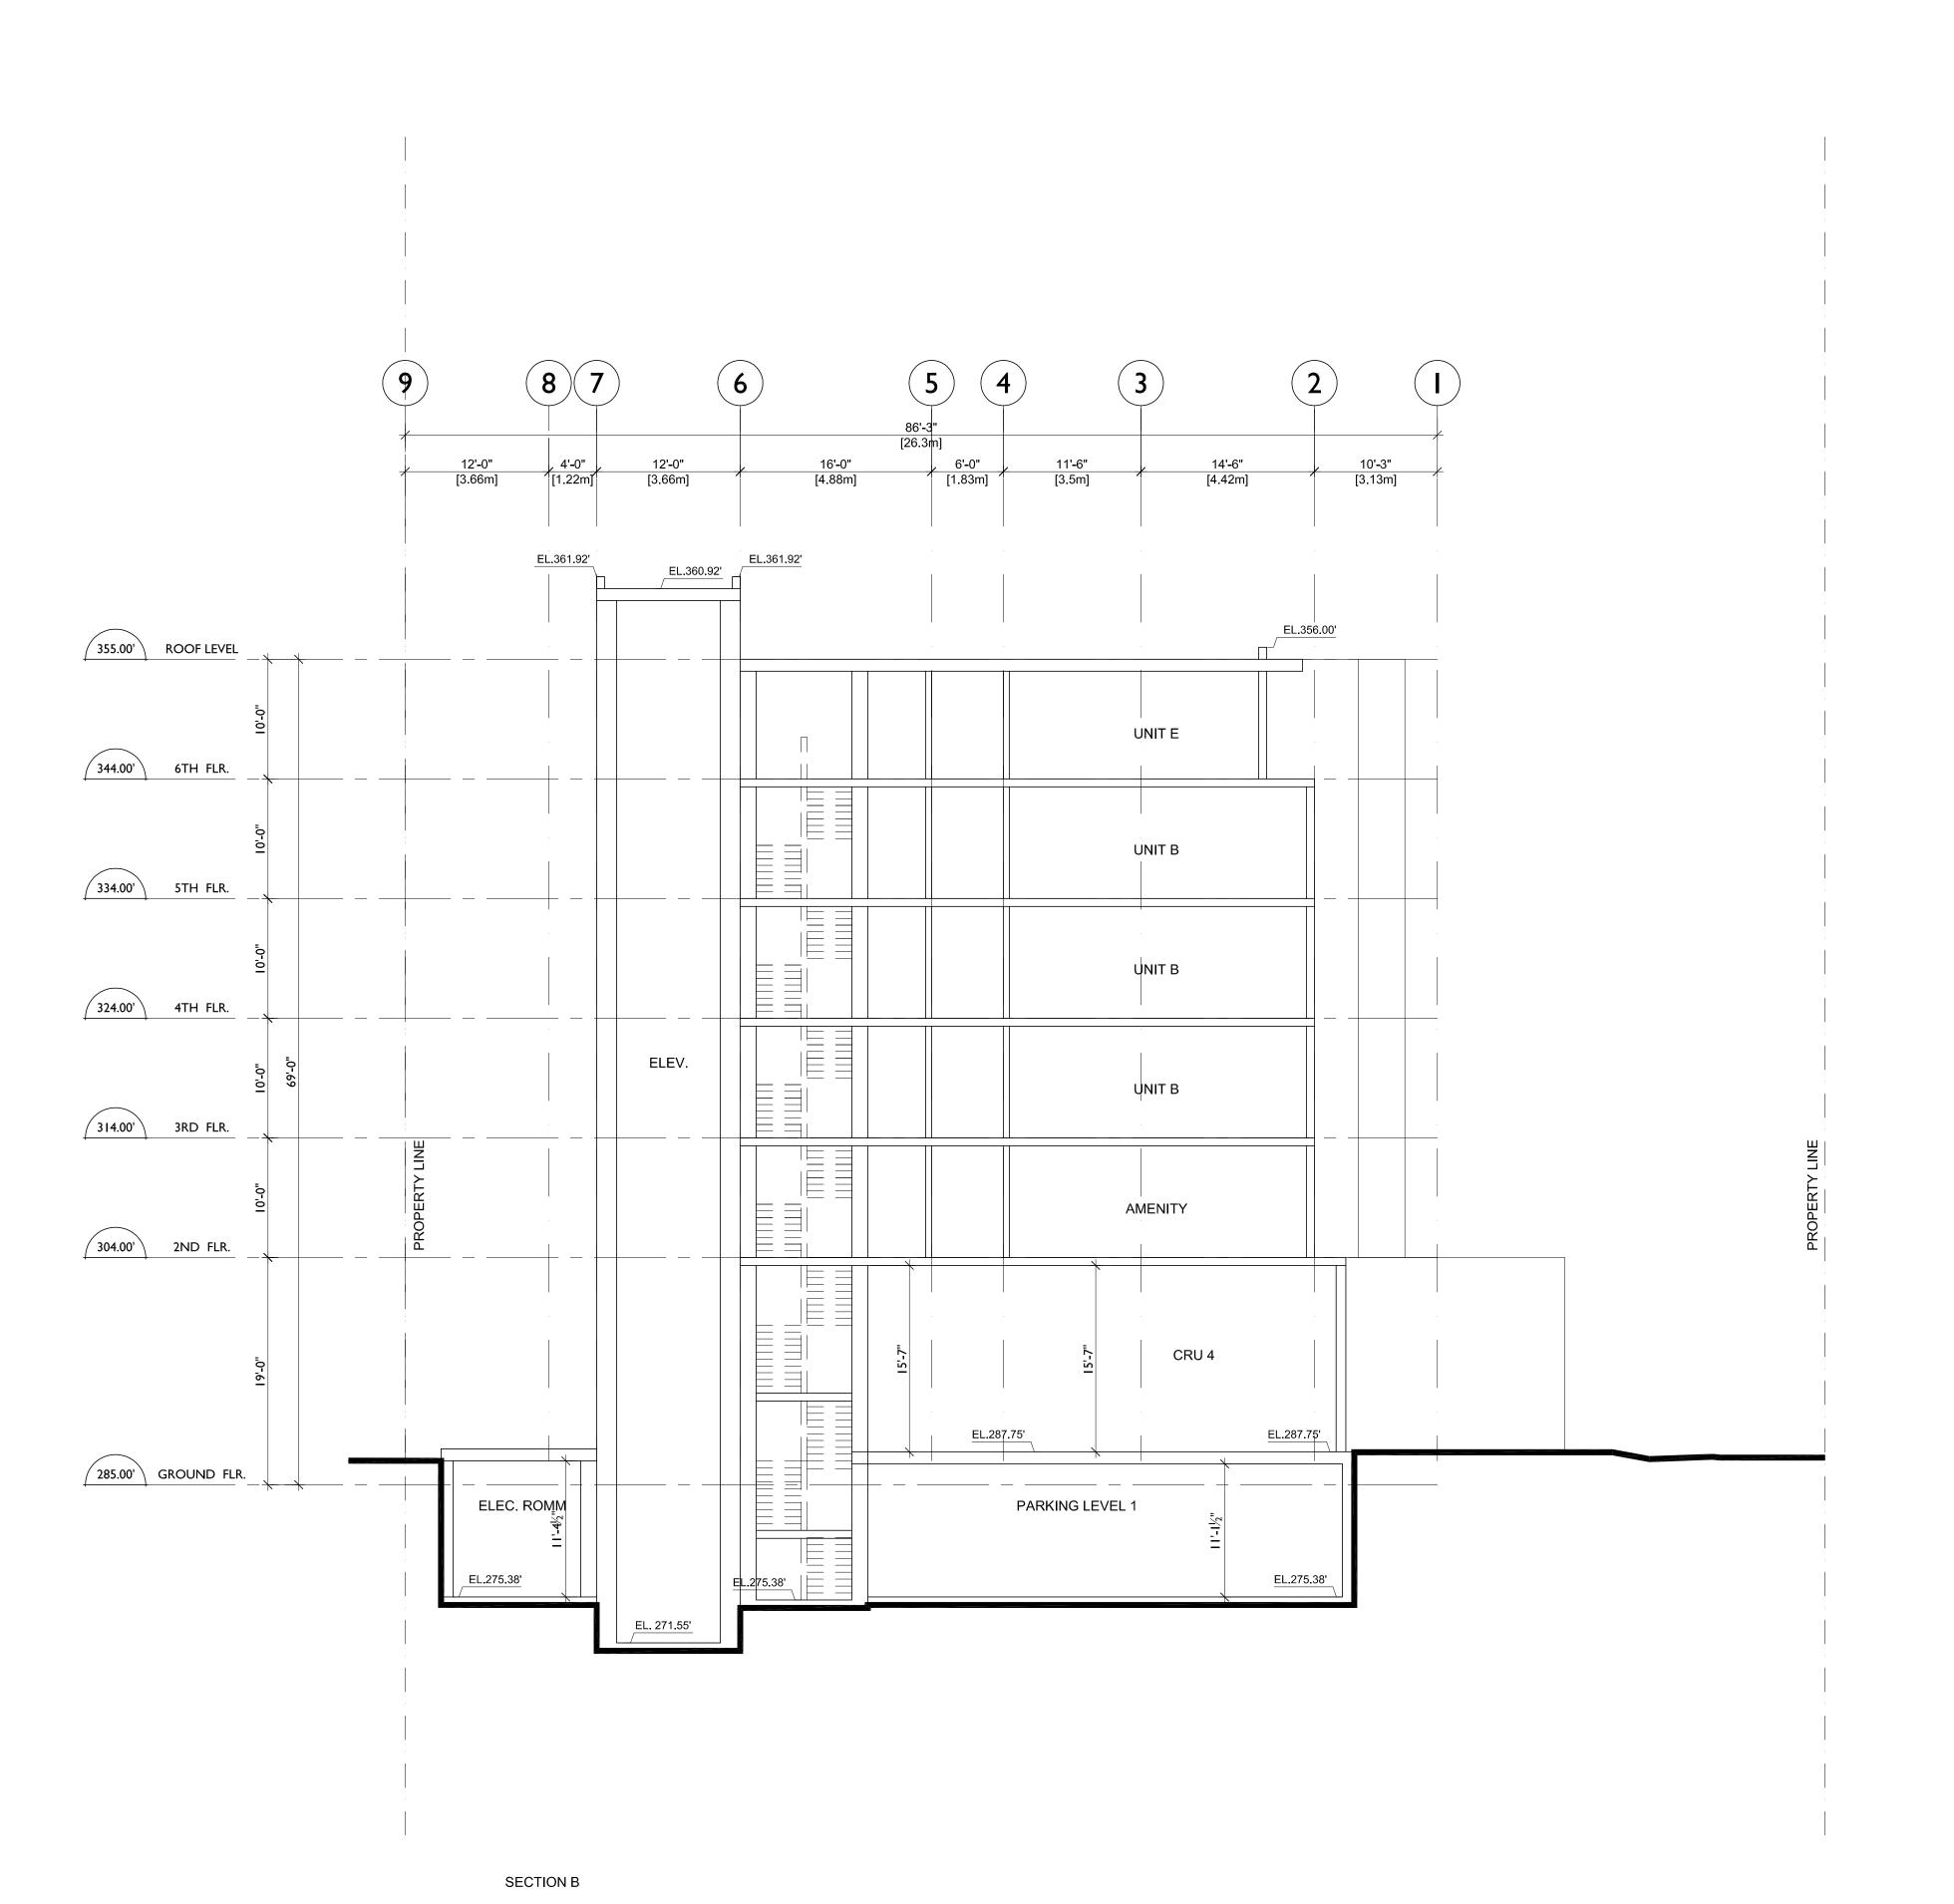



COPYRIGHT RESERVED: THIS PLAN AND DESIGN ARE AND AT ALL TIMES REMAIN THE EXCLUSIVE PROPERTY OF 65L ARCHITECTS AND MAY NOT BE USED OR REPRODUCED MITHOUT THEIR WRITTEN CONSENT

NOTES

NO. DESCRIPTION

REVISIONS

NO. DATE REMARKS

01 JUNE 2, 2016 DEVELOPMENT PERMIT SUBMISSION
02 JULY 26, 2016 DEVELOPMENT PERMIT
RE-SUBMISSION

SITE D

UNIVERSITY BOULEVARD, UBC

MARKET RENTAL DEVELOPMENT

SECTION B-B


DATE APRIL 2016
DRAWN BY AJE
CHECKED BY --

JOB NUMBER 1617

SCALE

A - 5.02

3/32" = 1'-0"

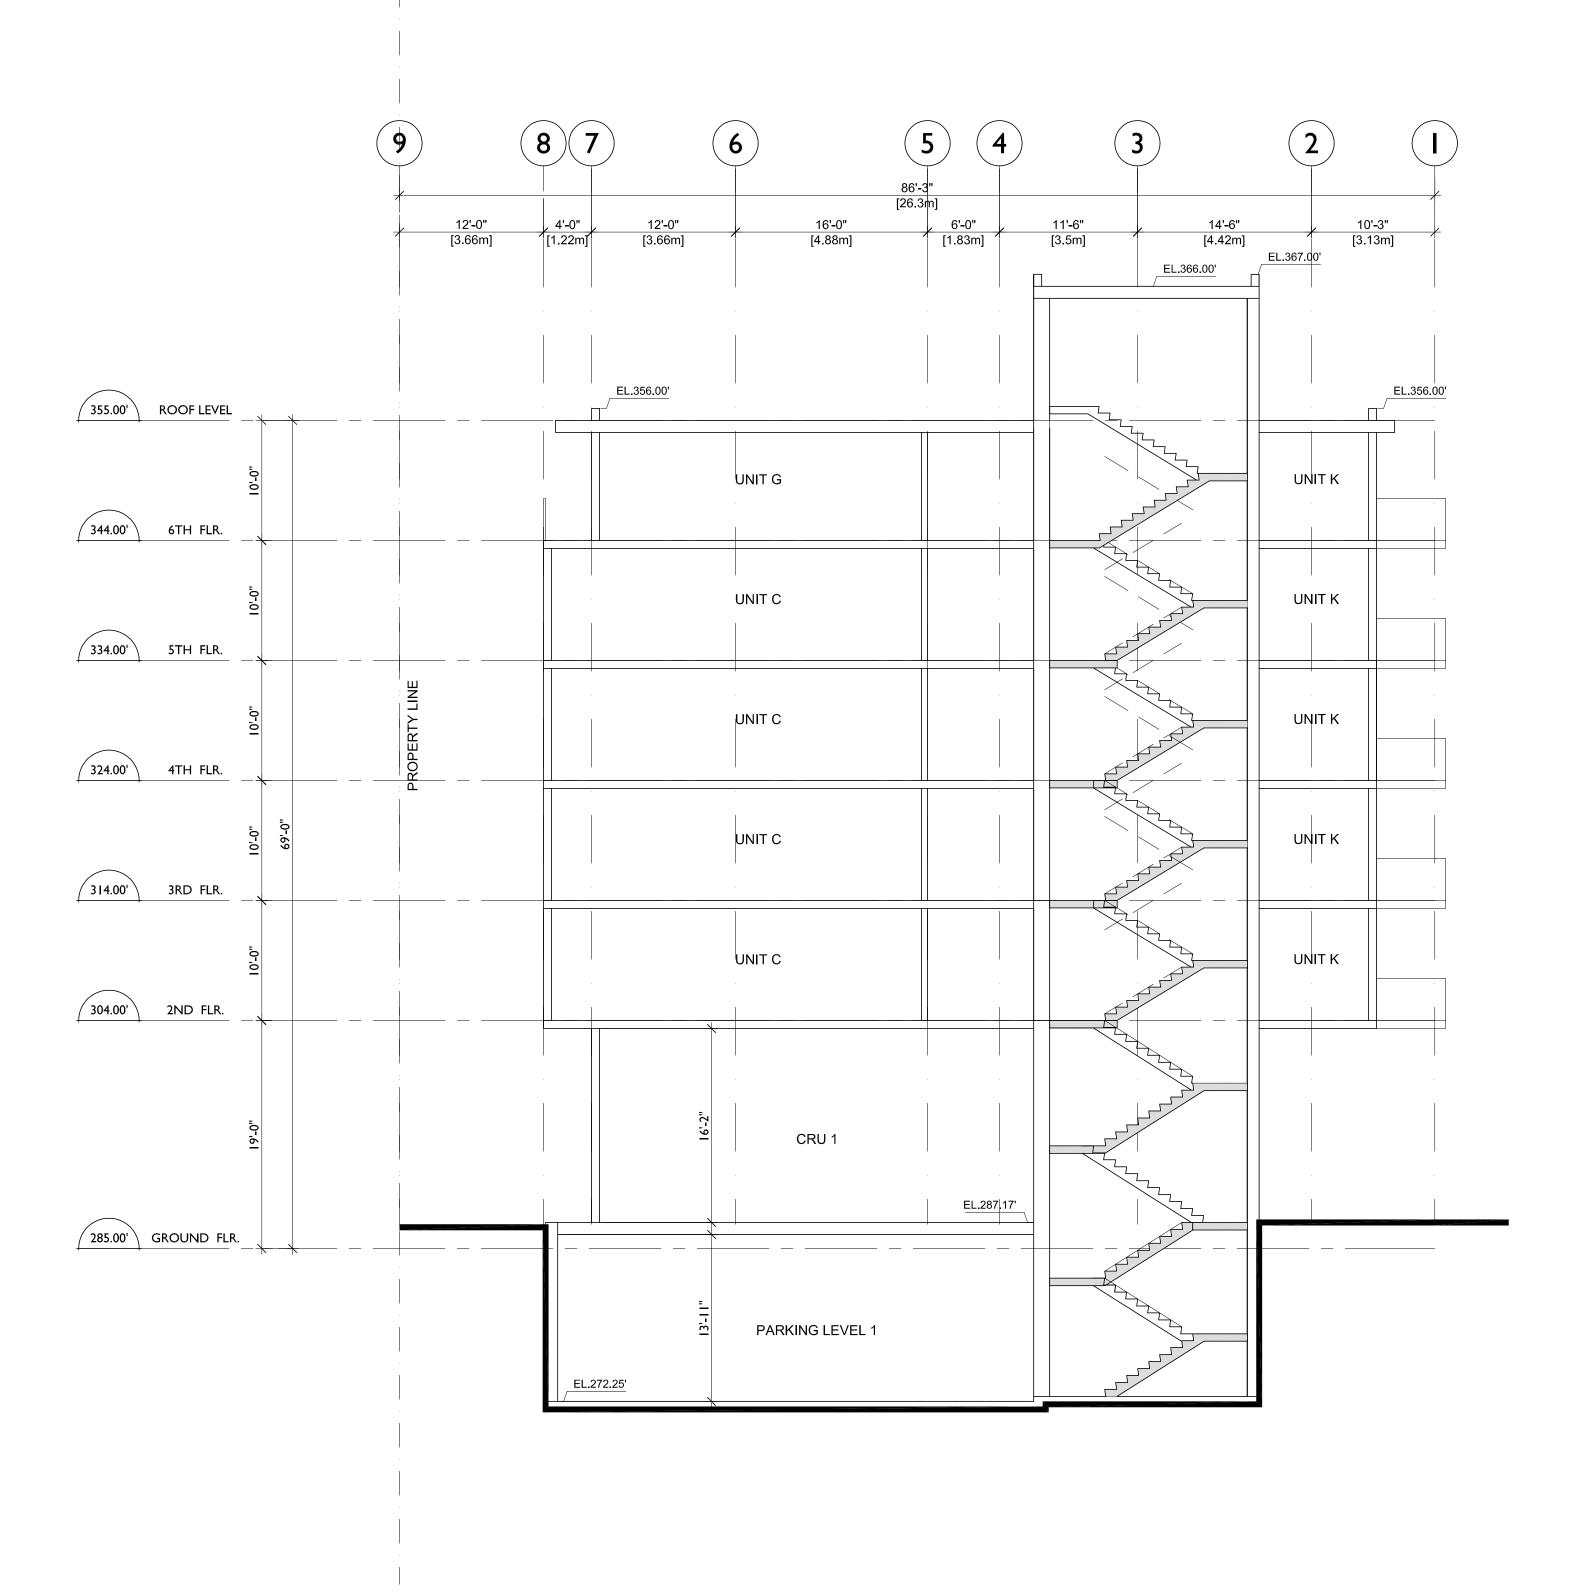

SECTION C



GBL ARCHITECTS
139 EAST 8TH AVENUE
VANCOUVER, CANADA V5T 1R8
T 604 736 1156 F 604 731 5279
GBLARCHITECTS.COM

COPYRIGHT RESERVED. THIS PLAN AND DESIGN ARE AND AT ALL TIMES REMAIN THE EXCLUSIVE PROPERTY OF SBL ARCHTECTS AND MAY NOT BE USED OR REPRODUCED WITHOUT THEIR MRITTEN CONCENT

NOTES

NO. DESCRIPTION

REVISIONS

NO. DATE REMARKS

01 JUNE 2, 2016 DEVELOPMENT PERMIT SUBMISSION

02 JULY 26, 2016 DEVELOPMENT PERMIT

RE-SUBMISSION

SITE D

UNIVERSITY BOULEVARD, UBC

MARKET RENTAL DEVELOPMENT


SECTION C-C

DATE APRIL 2016
DRAWN BY AJE
CHECKED BY --

3/32" = 1'-0"

JOB NUMBER 1617



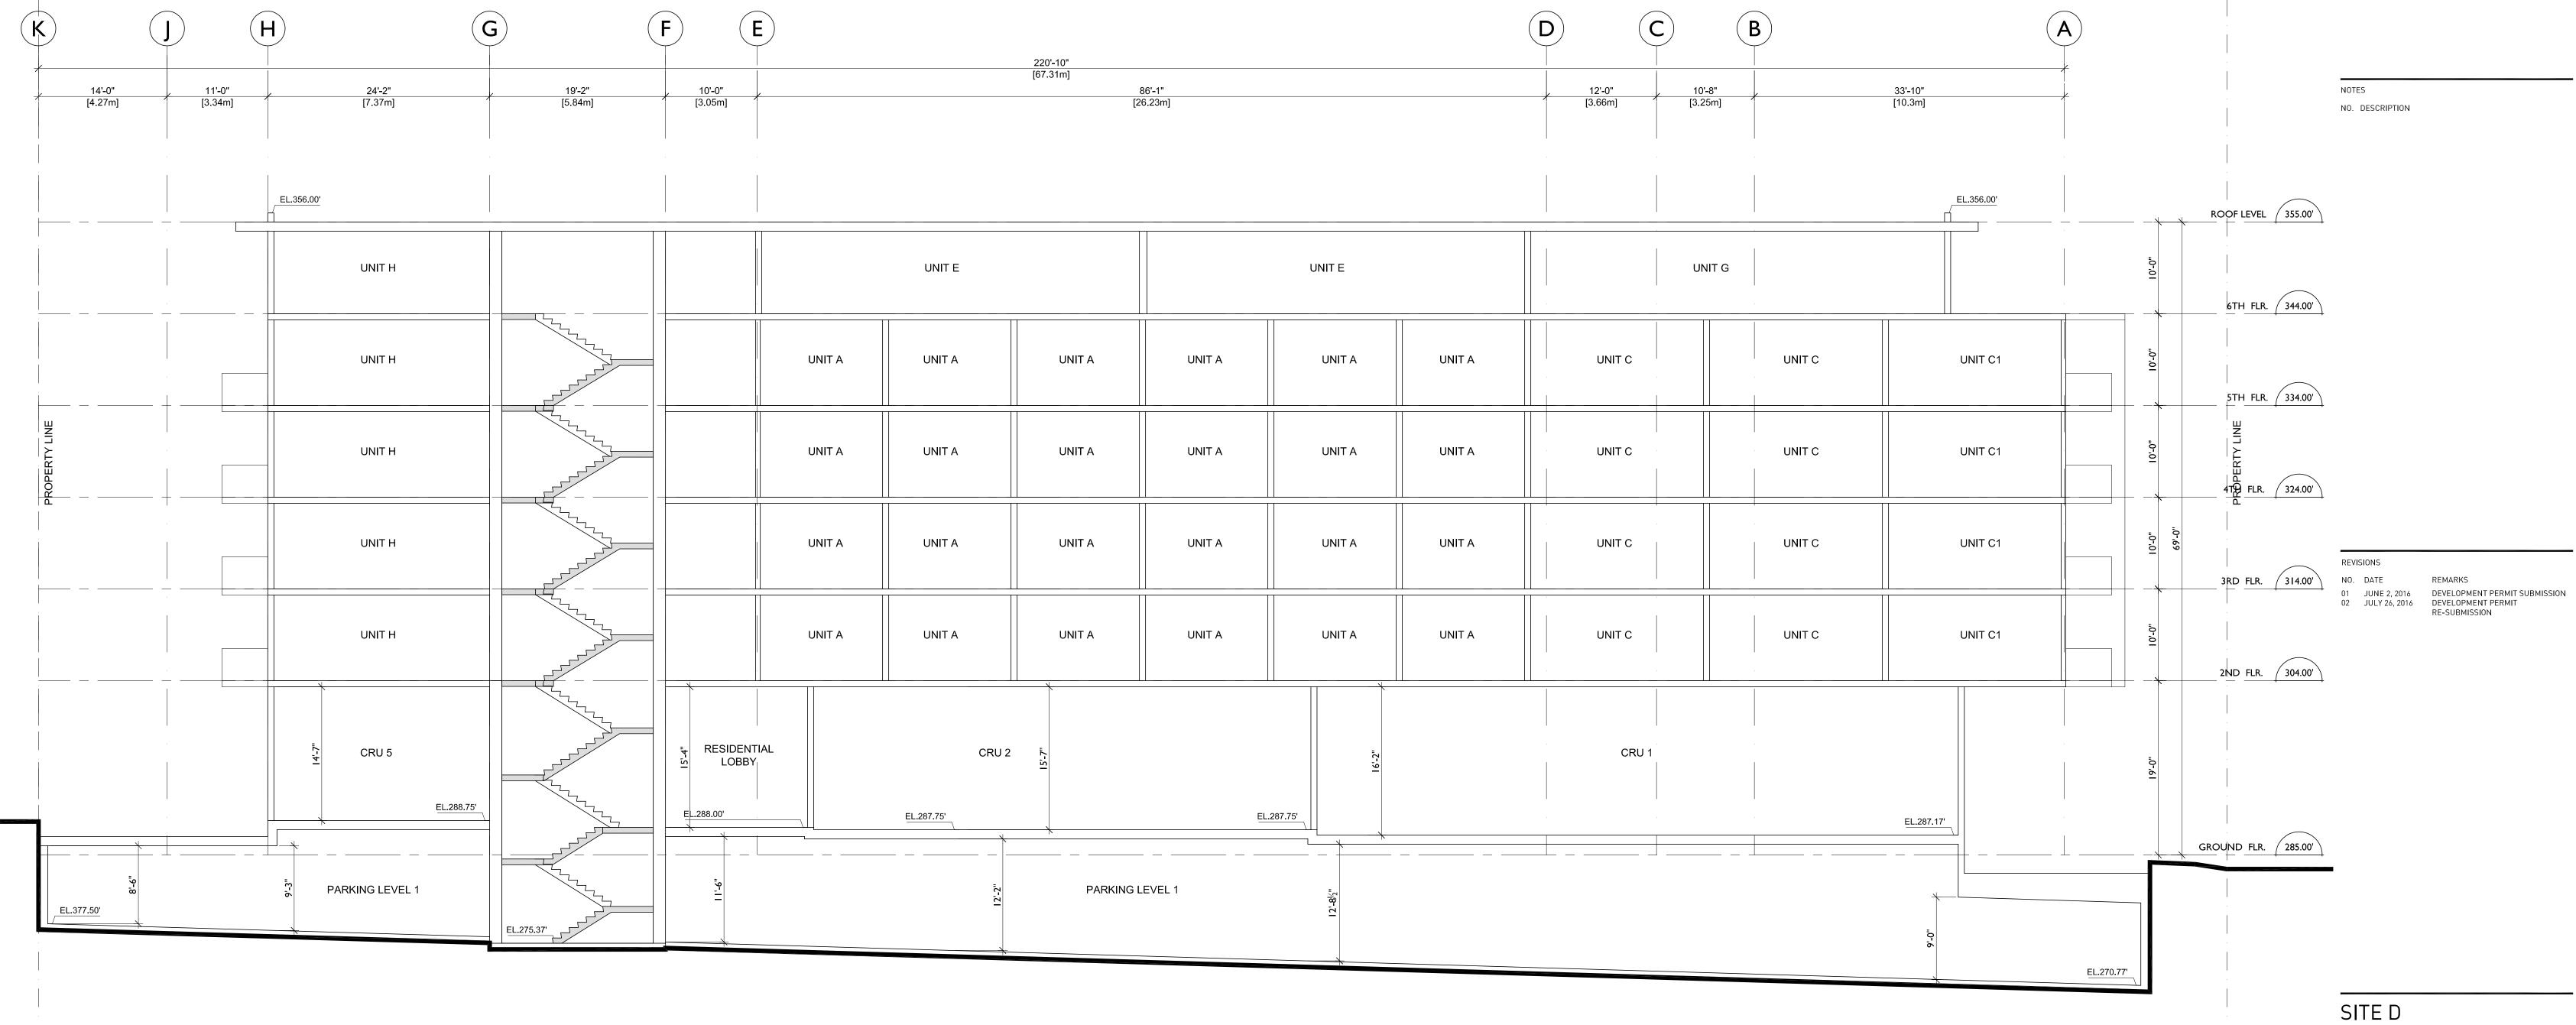

SECTION D


UNIVERSITY BOULEVARD, UBC

MARKET RENTAL DEVELOPMENT

SECTION D-D

JOB NUMBER

DATE APRIL 2016 DRAWN BY AJE CHECKED BY SCALE 1/8" = 1'-0" 1617

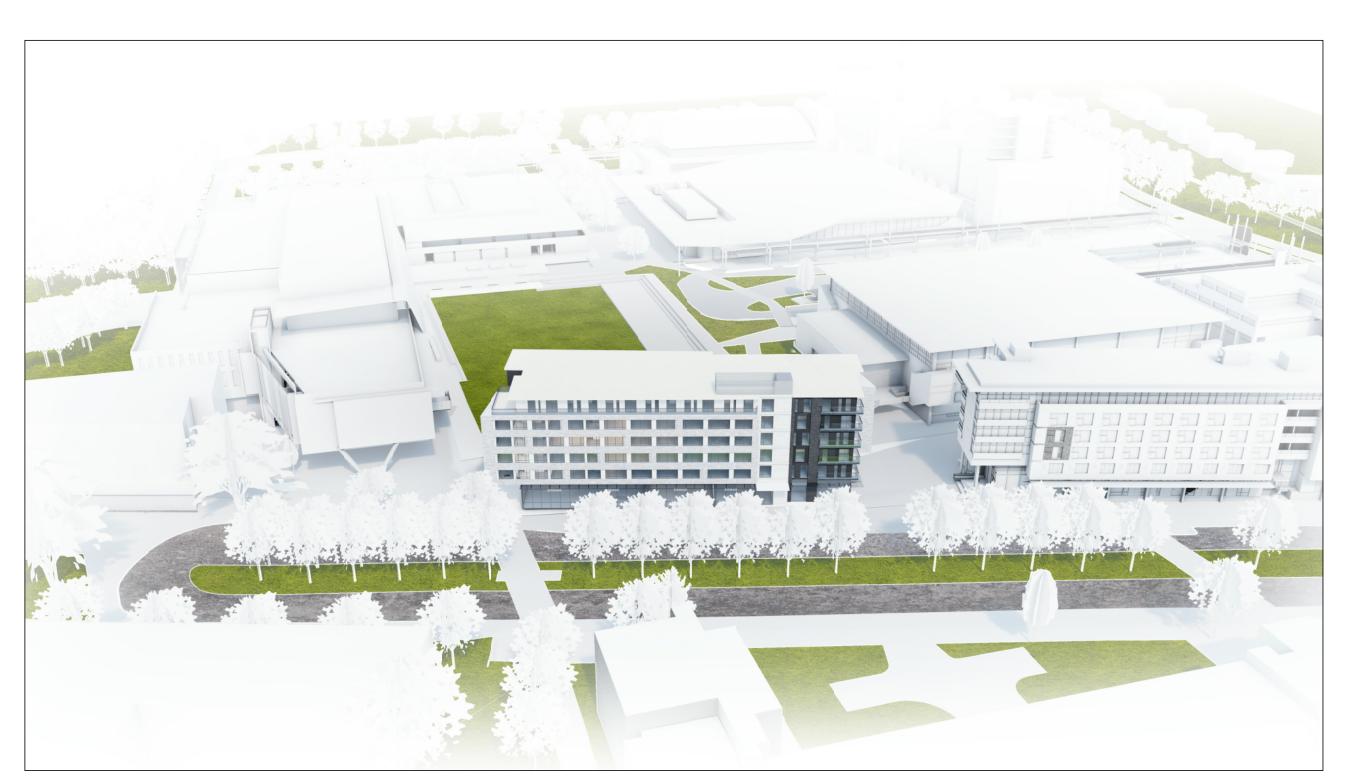

AERIAL VIEW LOOKING NORTH



PLAZA VIEW LOOKING WEST



STREET VIEW LOOKING WEST



PARK VIEW LOOKING SOUTH



COPYRIGHT RESERVED. THIS PLAN AND DESIGN ARE AND AT ALL TIMES REMAIN THE EXCLUSIVE PROPERTY GBL ARCHITECTS AND MAY NOT BE USED OR REPRODUCED WITHOUT THEIR WRITTEN CONSENT

NOTES

NO. DESCRIPTION

REVISIONS

NO. DATE REMARKS

01 JUNE 2, 2016 DEVELOPMENT PERMIT SUBMISSION
02 JULY 26, 2016 DEVELOPMENT PERMIT
RE-SUBMISSION

SITE D

UNIVERSITY BOULEVARD, UBC

MARKET RENTAL DEVELOPMENT

3D VIEWS


DATE APRIL 2016

DRAWN BY AJE

CHECKED BY -
SCALE NTS

JOB NUMBER 1617

A-6.01

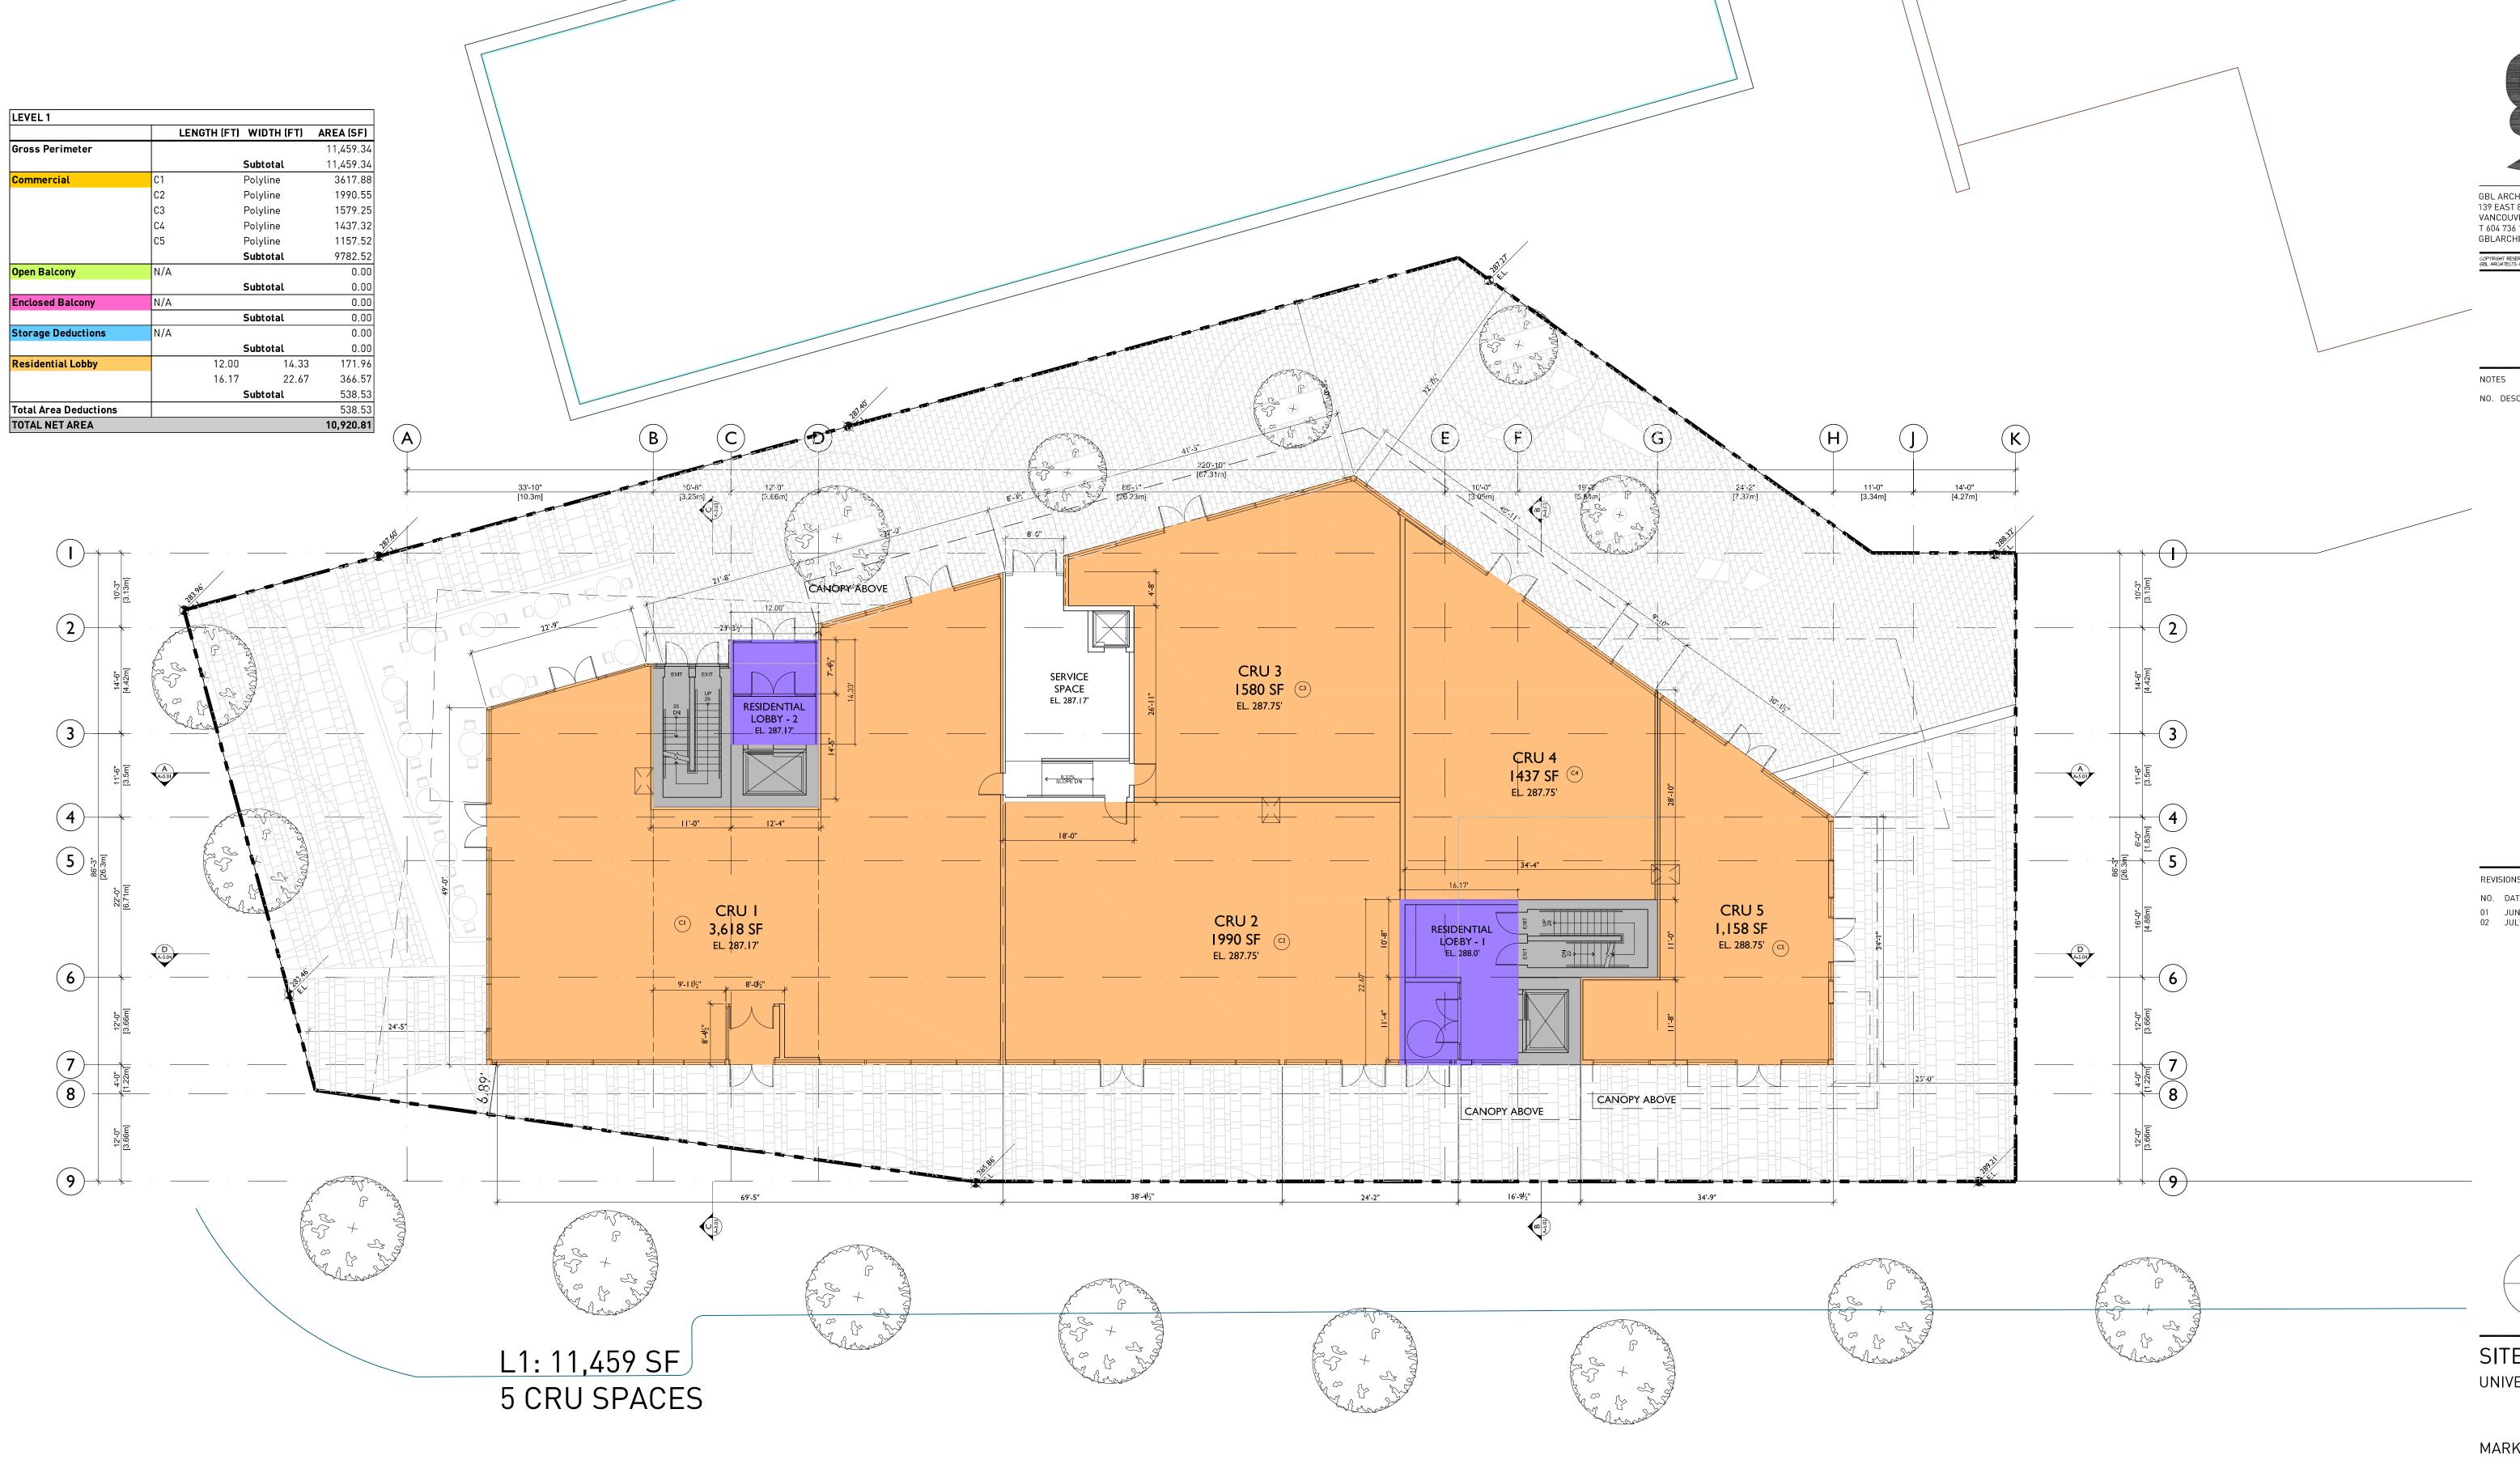



COPYRIGHT RESERVED: THIS PLAN AND DESIGN ARE AND AT ALL TIMES REMAIN THE EXCLUSIVE PROPERTY GBL ARCHITECTS AND MAY NOT BE USED OR REPRODUCED WITHOUT THEIR MRITTEN CONSENT

NO. DESCRIPTION

REVISIONS

01 JUNE 2, 2016 DEVELOPMENT PERMIT SUBMISSION
02 JULY 26, 2016 DEVELOPMENT PERMIT
RE-SUBMISSION

PN

SITE D

UNIVERSITY BOULEVARD, UBC

MARKET RENTAL DEVELOPMENT

FSR - LEVEL 1

DATE APRIL 2016 DRAWN BY CHECKED BY 3/32" = 1'-0" SCALE

JOB NUMBER

A-7.01

1617





COPYRIGHT RESERVED: THIS PLAN AND DESIGN ARE AND AT ALL TIMES REMAIN THE EXCLUSIVE PROPERT GBL ARCHITECTS AND MAY NOT BE USED OR REPRODUCED WITHOUT THEIR WRITTEN CONSENT

NOTES

NO. DESCRIPTION

REVISIONS NO. DATE

01 JUNE 2, 2016 DEVELOPMENT PERMIT SUBMISSION
02 JULY 26, 2016 DEVELOPMENT PERMIT
RE-SUBMISSION

PΝ

SITE D

UNIVERSITY BOULEVARD, UBC

MARKET RENTAL DEVELOPMENT

FSR - LEVEL 2

DATE APRIL 2016

DRAWN BY AJE

CHECKED BY -
SCALE 3/32" = 1'-0"

JOB NUMBER 1617

A-7.02





COPYRIGHT RESERVED: THIS PLAN AND DESIGN ARE AND AT ALL TIMES REMAIN THE EXCLUSIVE PROPERT GBL ARCHITECTS AND MAY NOT BE USED OR REPRODUCED WITHOUT THEIR WRITTEN CONSENT

01 JUNE 2, 2016 DEVELOPMENT PERMIT SUBMISSION DEVELOPMENT PERMIT RE-SUBMISSION

UNIVERSITY BOULEVARD, UBC


FSR - LEVELS 3-5

APRIL 2016 DRAWN BY CHECKED BY 3/32" = 1'-0"

JOB NUMBER

A-7.03

1617

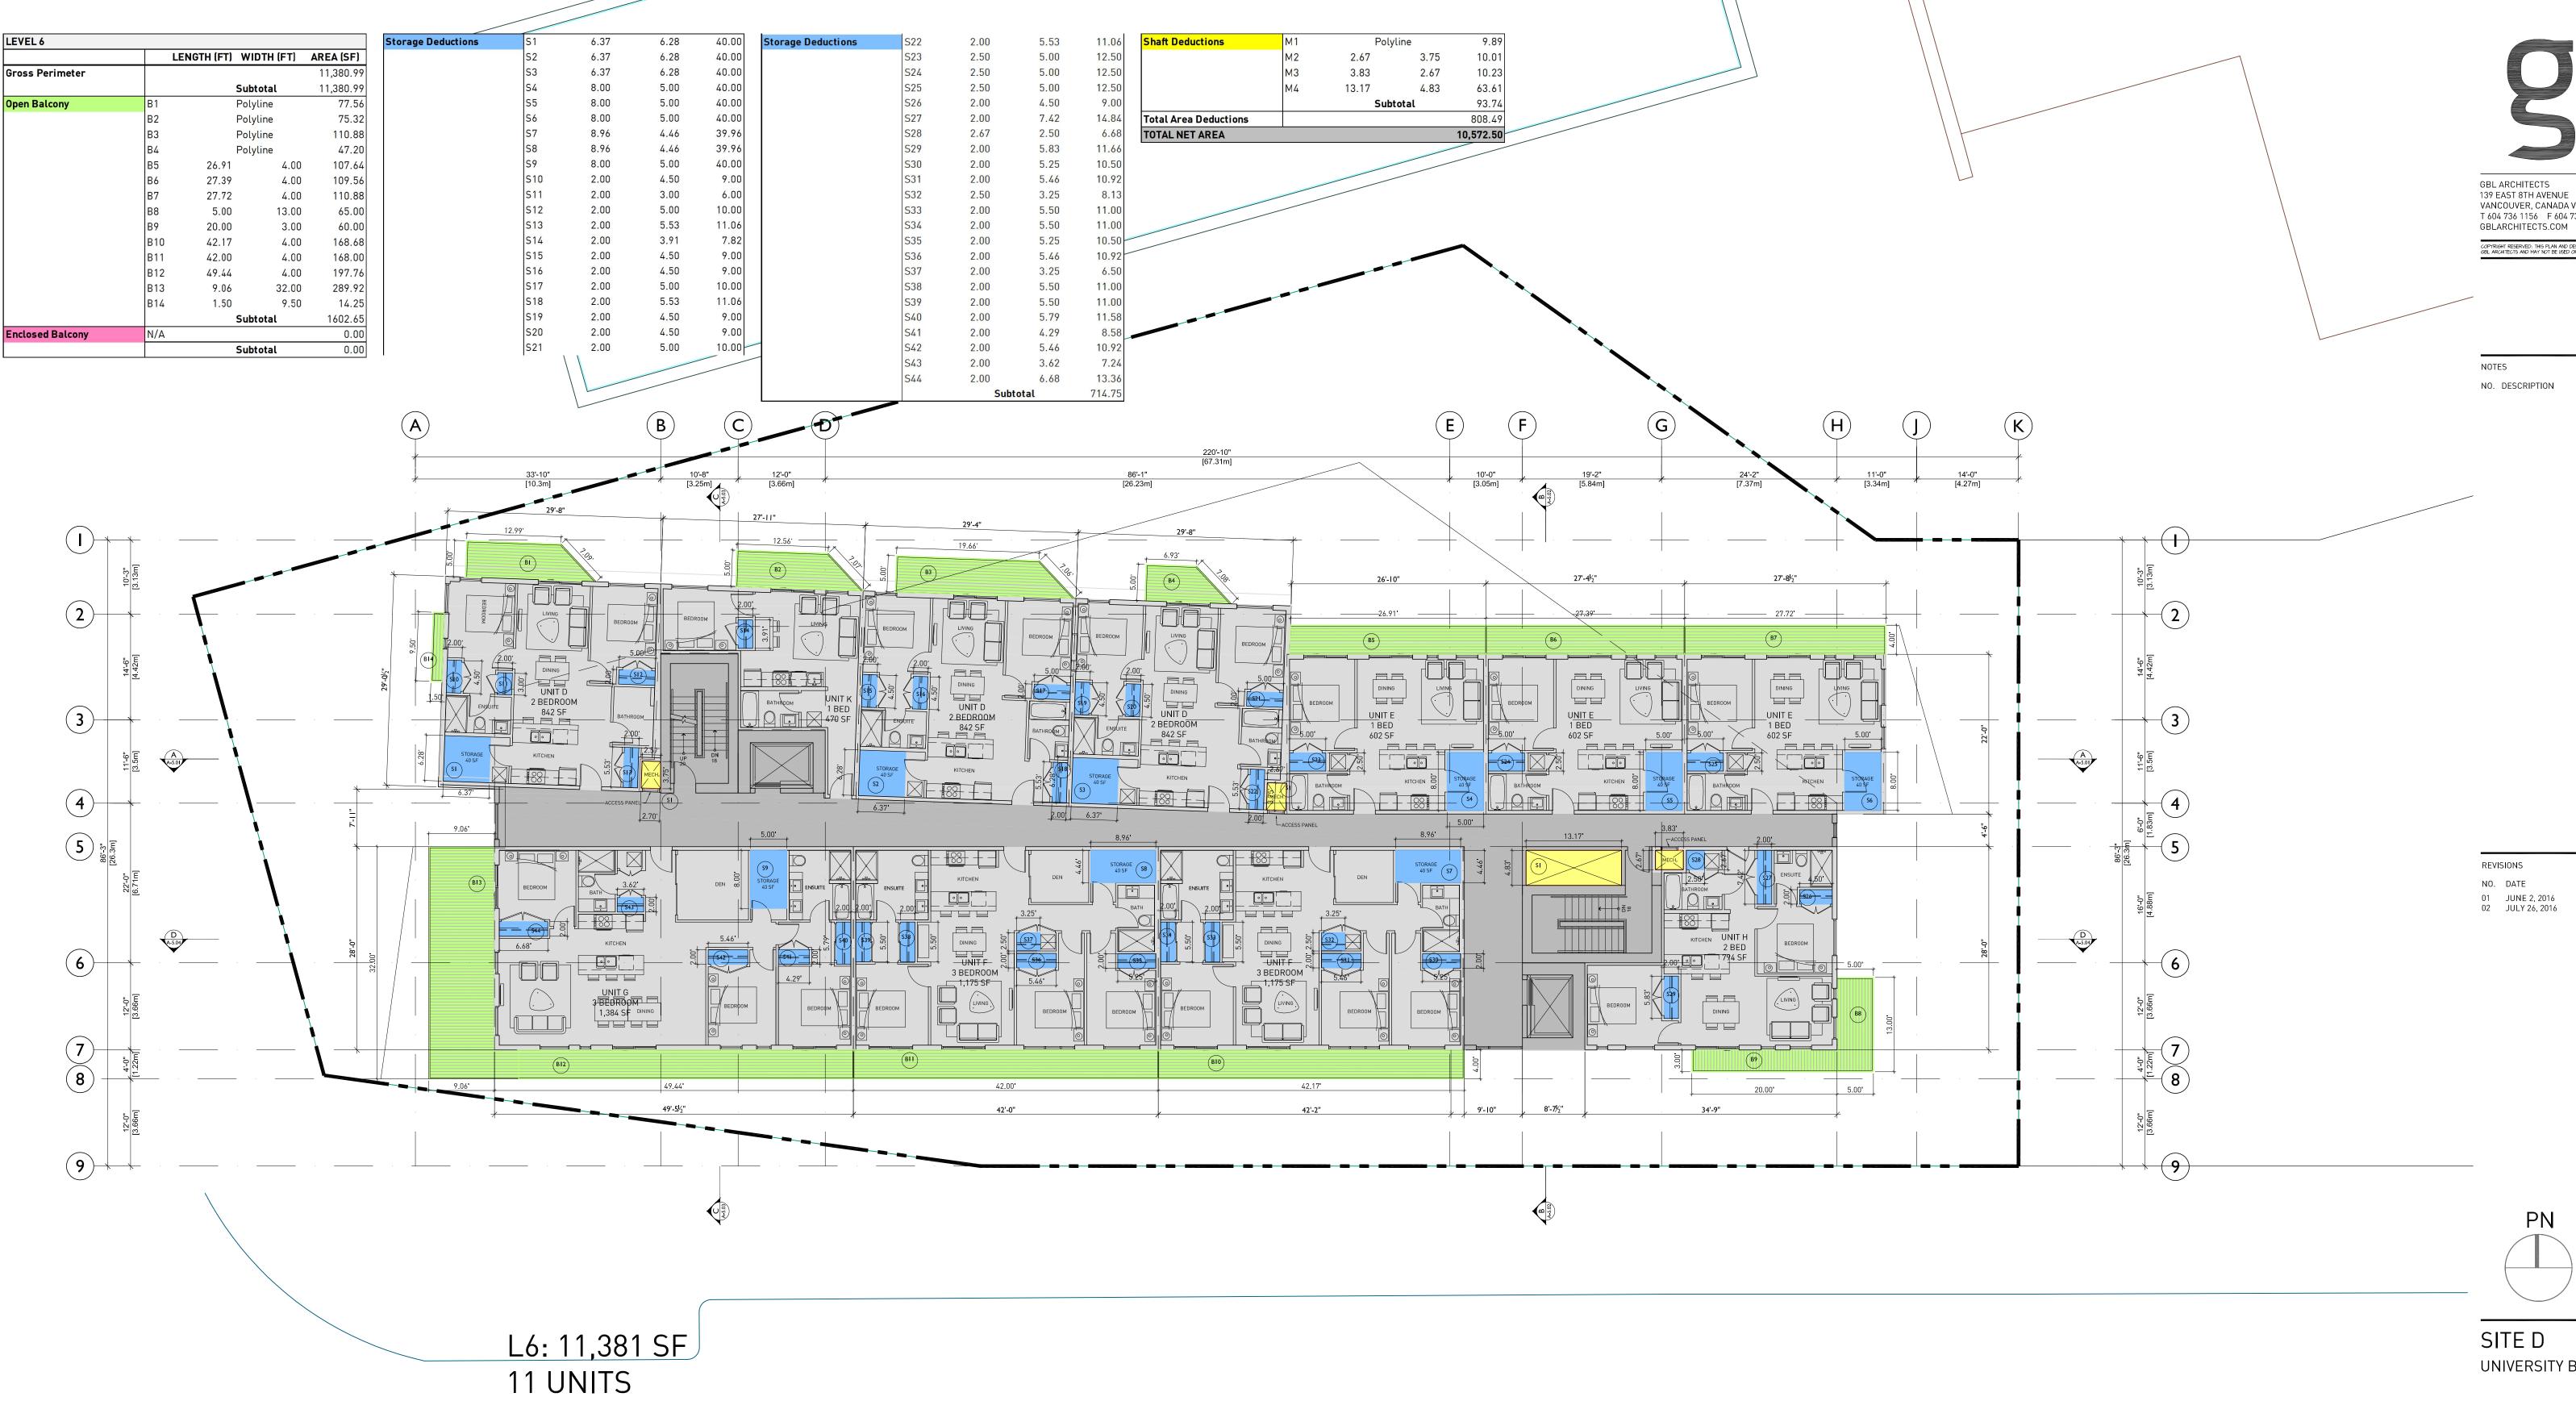



GBL ARCHITECTS 139 EAST 8TH AVENUE VANCOUVER, CANADA V5T 1R8 T 604 736 1156 F 604 731 5279

COPYRIGHT RESERVED: THIS PLAN AND DESIGN ARE AND AT ALL TIMES REMAIN THE EXCLUSIVE PROPERT GBL ARCHITECTS AND MAY NOT BE USED OR REPRODUCED WITHOUT THEIR WRITTEN CONSENT

NO. DESCRIPTION

REVISIONS

01 JUNE 2, 2016 DEVELOPMENT PERMIT SUBMISSION DEVELOPMENT PERMIT RE-SUBMISSION

PΝ

SITE D


UNIVERSITY BOULEVARD, UBC

MARKET RENTAL DEVELOPMENT

FSR - LEVEL 6

APRIL 2016 DRAWN BY CHECKED BY 3/32" = 1'-0"

1617 JOB NUMBER

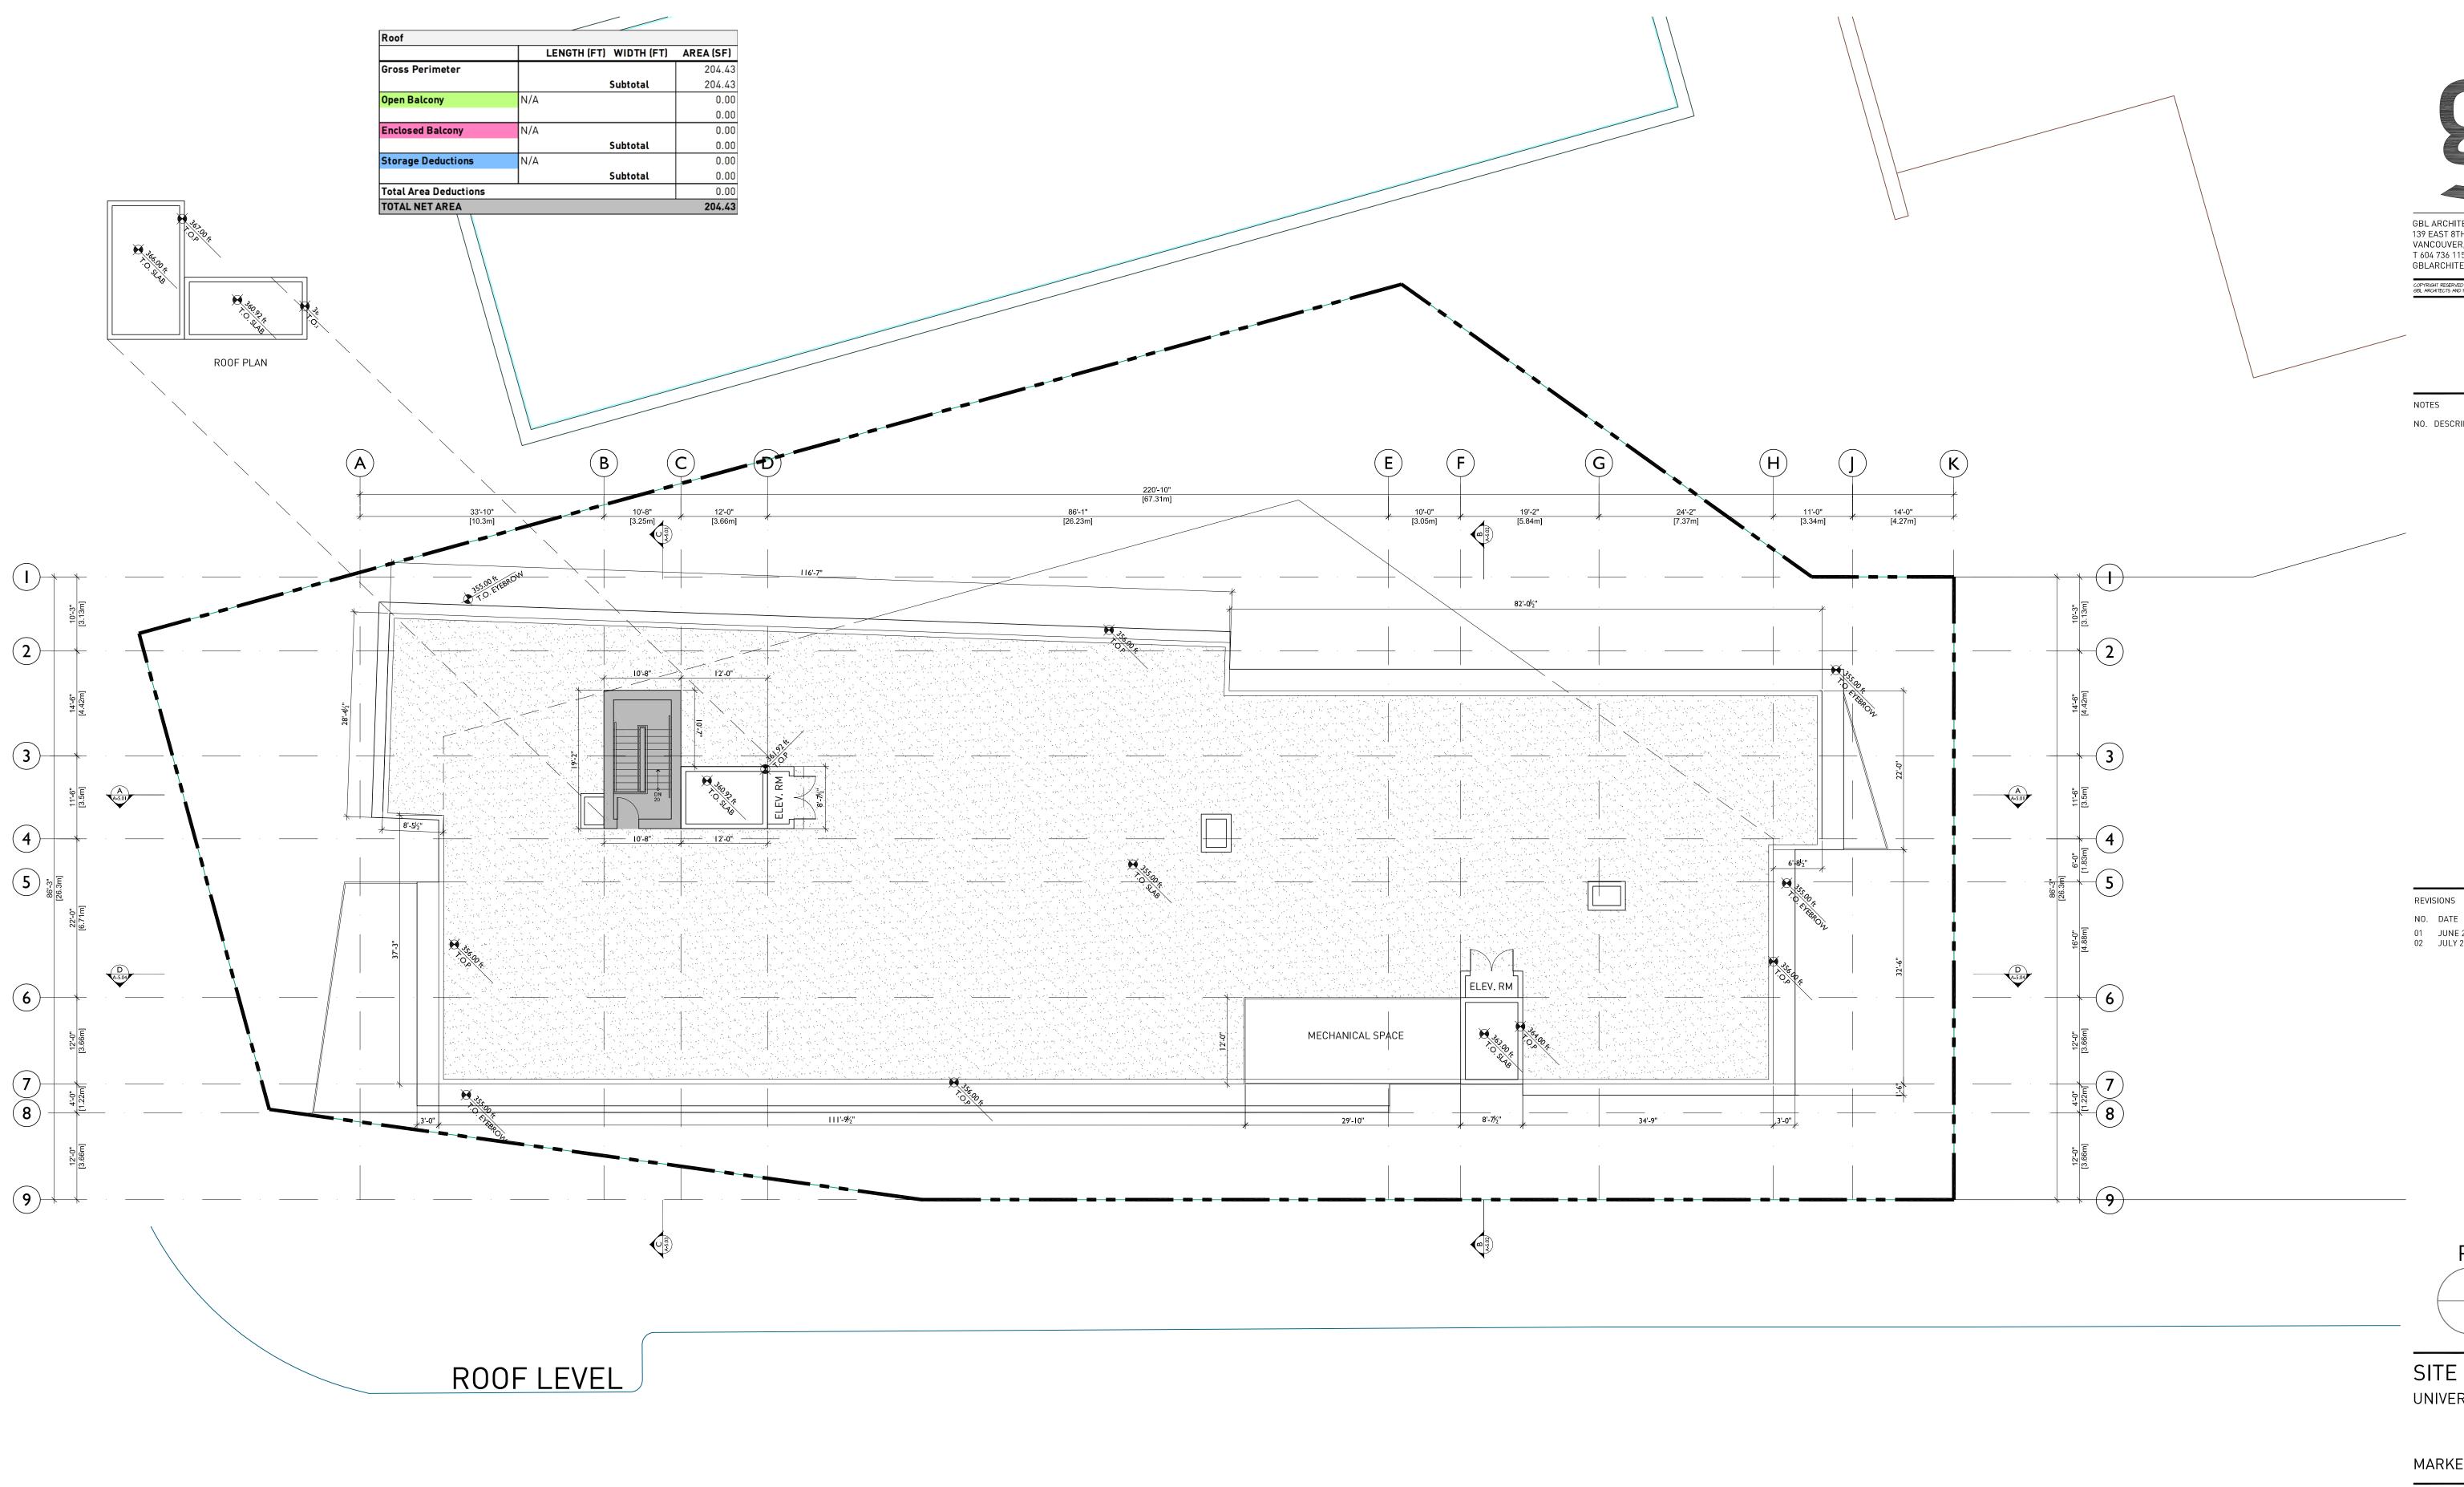

COPYRIGHT RESERVED: THIS PLAN AND DESIGN ARE AND AT ALL TIMES REMAIN THE EXCLUSIVE PROPERTY (GBL ARCHITECTS AND MAY NOT BE USED OR REPRODUCED WITHOUT THEIR WRITTEN CONSENT

NO. DESCRIPTION

NO. DATE 01 JUNE 2, 2016 DEVELOPMENT PERMIT SUBMISSION
02 JULY 26, 2016 DEVELOPMENT PERMIT
RE-SUBMISSION

PΝ

SITE D

UNIVERSITY BOULEVARD, UBC

MARKET RENTAL DEVELOPMENT


FSR - ROOF PLAN

APRIL 2016 DRAWN BY CHECKED BY SCALE 3/32" = 1'-0"

JOB NUMBER

A-7.05

1617

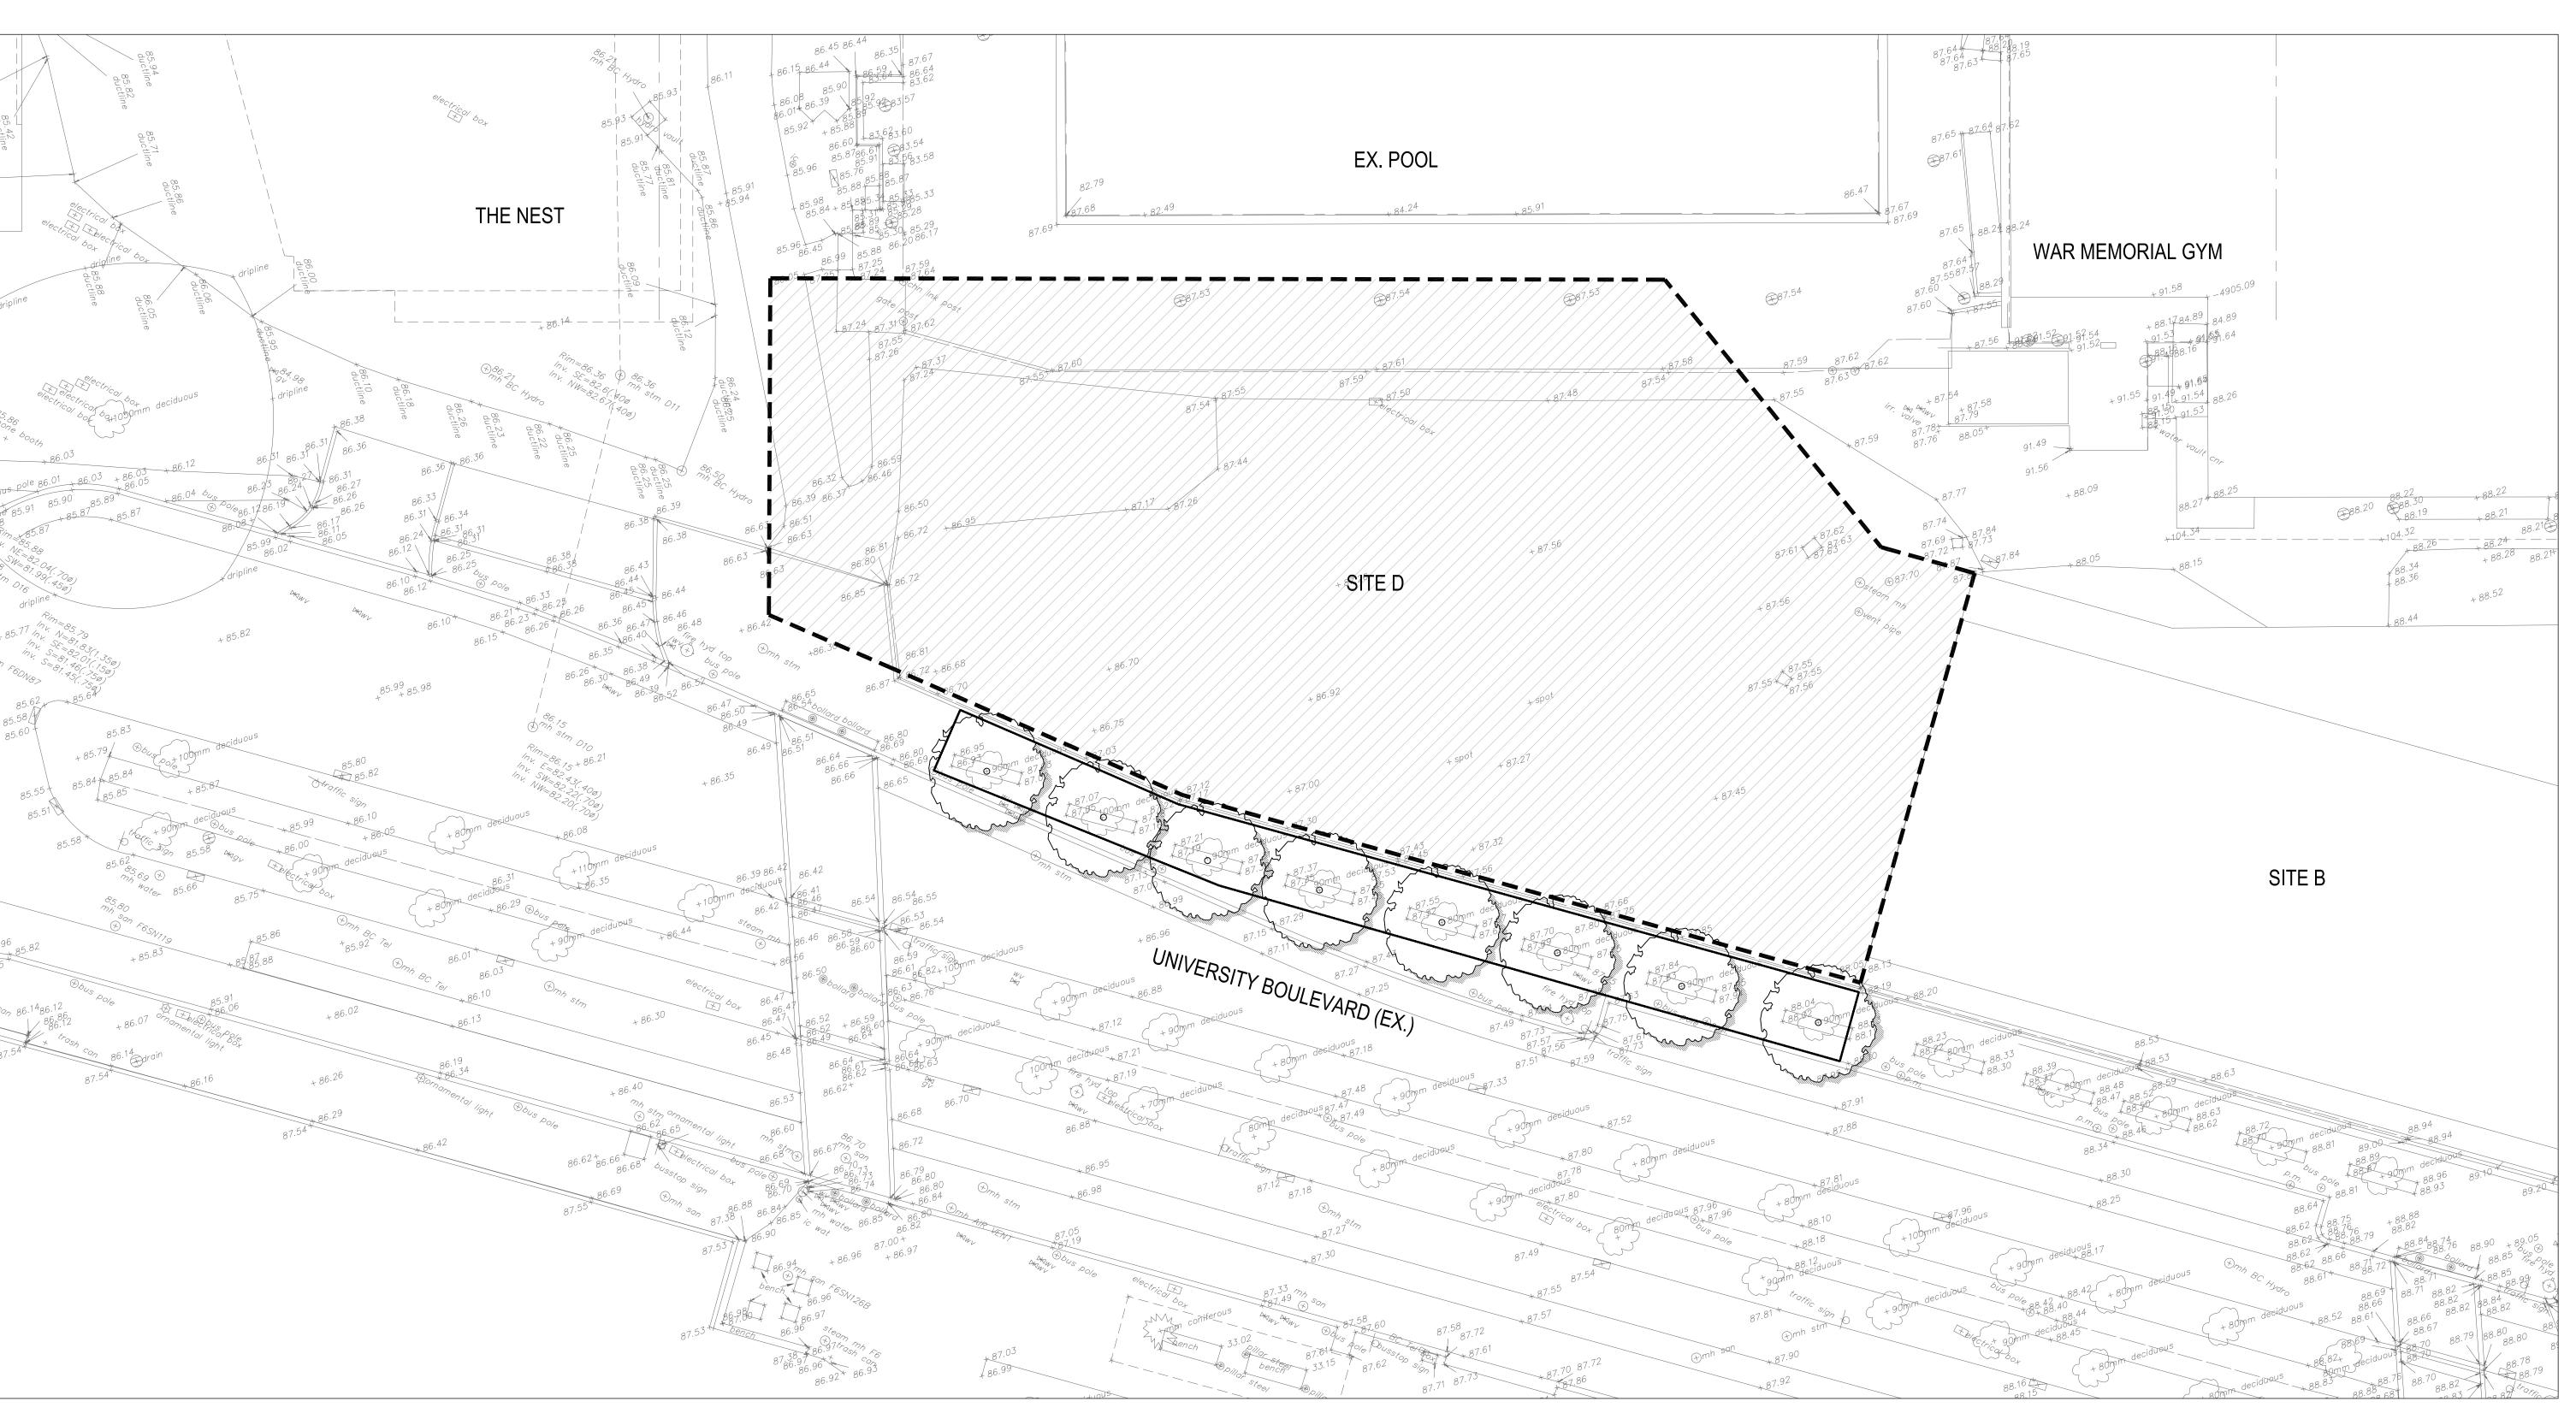

LANDSCAPE ARCHITECTS:

NO. DESCRIPTION

1 6/1/2016 ISSUE FOR DEVELOPMENT PERMIT

2 7/27/2016 RE-ISSUE FOR DEVELOPMENT PERMIT

PROJECT SCOPE BOUNDARY



TREE PROTECTION FENCE - SEE DETAIL THIS PAGE


AREA TO BE DEMOLISHED - SEE DEMO NOTES

TREE PROTECTION NOTES

- NO STORAGE OF BUILDING /CONSTRUCTION MATERIALS WITHIN PROTECTED AREAS OR AGAINST PROTECTION BARRIER.
- 2. ANY PRUNING OF BRANCHES OR ROOTS MUST BE DONE BY THE PROJECT ARBORIST. CONTRACTOR TO UNDERTAKE TREE PROTECTION MEASURES TO UNIVERSITY OF BRITISH COLUMBIA
- STANDARDS.
- 4. HAND EXCAVATE ONLY WITHIN DRIPLINE OF TREES TO BE RETAINED. SEVER ROOTS CLEANLY. CONTACT
- PROJECT ARBORIST FOR APPROVAL PRIOR TO SEVERING ROOTS IN EXCESS OF 100mm DIA. 5. TREE PROTECTION FENCE IS NOT TO BE LIFTED OR REMOVED AT ANY TIME FOR VEHICULAR ACCESS. VEHICLES AND HEAVY EQUIPMENT CAN CAUSE SOIL COMPACTION IN THE ROOT ZONE DEPLETING THE AIR
- SPACE THAT IS ESSENTIAL TO THE TREE'S HEALTH. 6. LOCATION OF TREE PROTECTION FENCING AND LIMIT OF ACCESS FENCING TO BE VERIFIED WITH CONSULTANT AND PROJECT ARBORIST PRIOR TO INSTALLATION.
- 7. BASED ON CONTRACTOR'S STAGING AND ACCESS REQUIREMENTS, FINAL TREE PROTECTION LOCATION TBD ON SITE. ADDITIONAL TREE PROTECTION FENCING MAY BE REQUIRED.

SITE DEMOLITION NOTES

- PLAN BASED ON SURVEY CONDUCTED BY MURRAY & ASSOCIATES, SURREY, BC AND SUPPLIED BY UBC. ALL EXISTING HARDSCAPE AND SOFTSCAPE WITHIN PROJECT BOUNDARY TO BE DEMOLISHED.
- REMOVE AND STOCKPILE ANY EXISTING SITE FURNISHINGS WITHIN HATCHED AREAS. COORDINATE STORAGE WITH UBC PLANT OPERATIONS.
- 4. REMOVE AND RETAIN ANY MEMORIAL OR HISTORIC LANDSCAPE ITEMS, PLAQUES, BENCHES, TREES, ETC. AND
- 5. LOCATION OF AT-GRADE SERVICES SHOWN ON DRAWINGS ARE INDICATIVE ONLY. CONTRACTOR TO VERIFY LOCATION AND PROTECT ALL SITE SERVICES WITHIN SCOPE OF WORK PRIOR TO COMMENCEMENT OF
- EXCAVATION. REFER TO CIVIL FOR SUB SURFACE UTILITY LOCATIONS. REFER TO CIVIL FOR UTILITY DEMOLITION AND PROTECTION MEASURES.
- REFER TO CIVIL FOR EROSION CONTROL MEASURES.
- 8. CONTRACTOR TO MAKE GOOD ANY DAMAGE DONE DURING THE CONSTRUCTION PERIOD TO EXISTING FEATURES TO BE RETAINED.

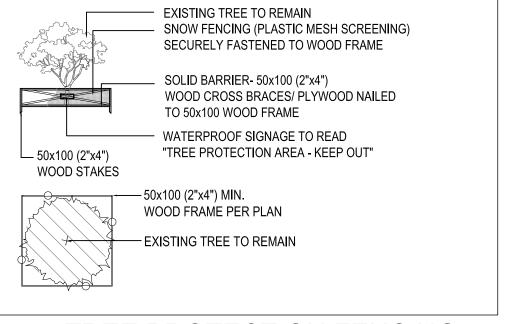



SITE D UNIVERSITY BOULEVARD, UBC


MARKET RENTAL DEVELOPMENT

JUNE 2016

Surface Demolition and Tree Management

DATE 6/1/2016 DRAWN BY NST CHECKED BY SCALE 1: 200METRIC OR AS NOTED

1617 JOB NUMBER PFS STUDIO #16007

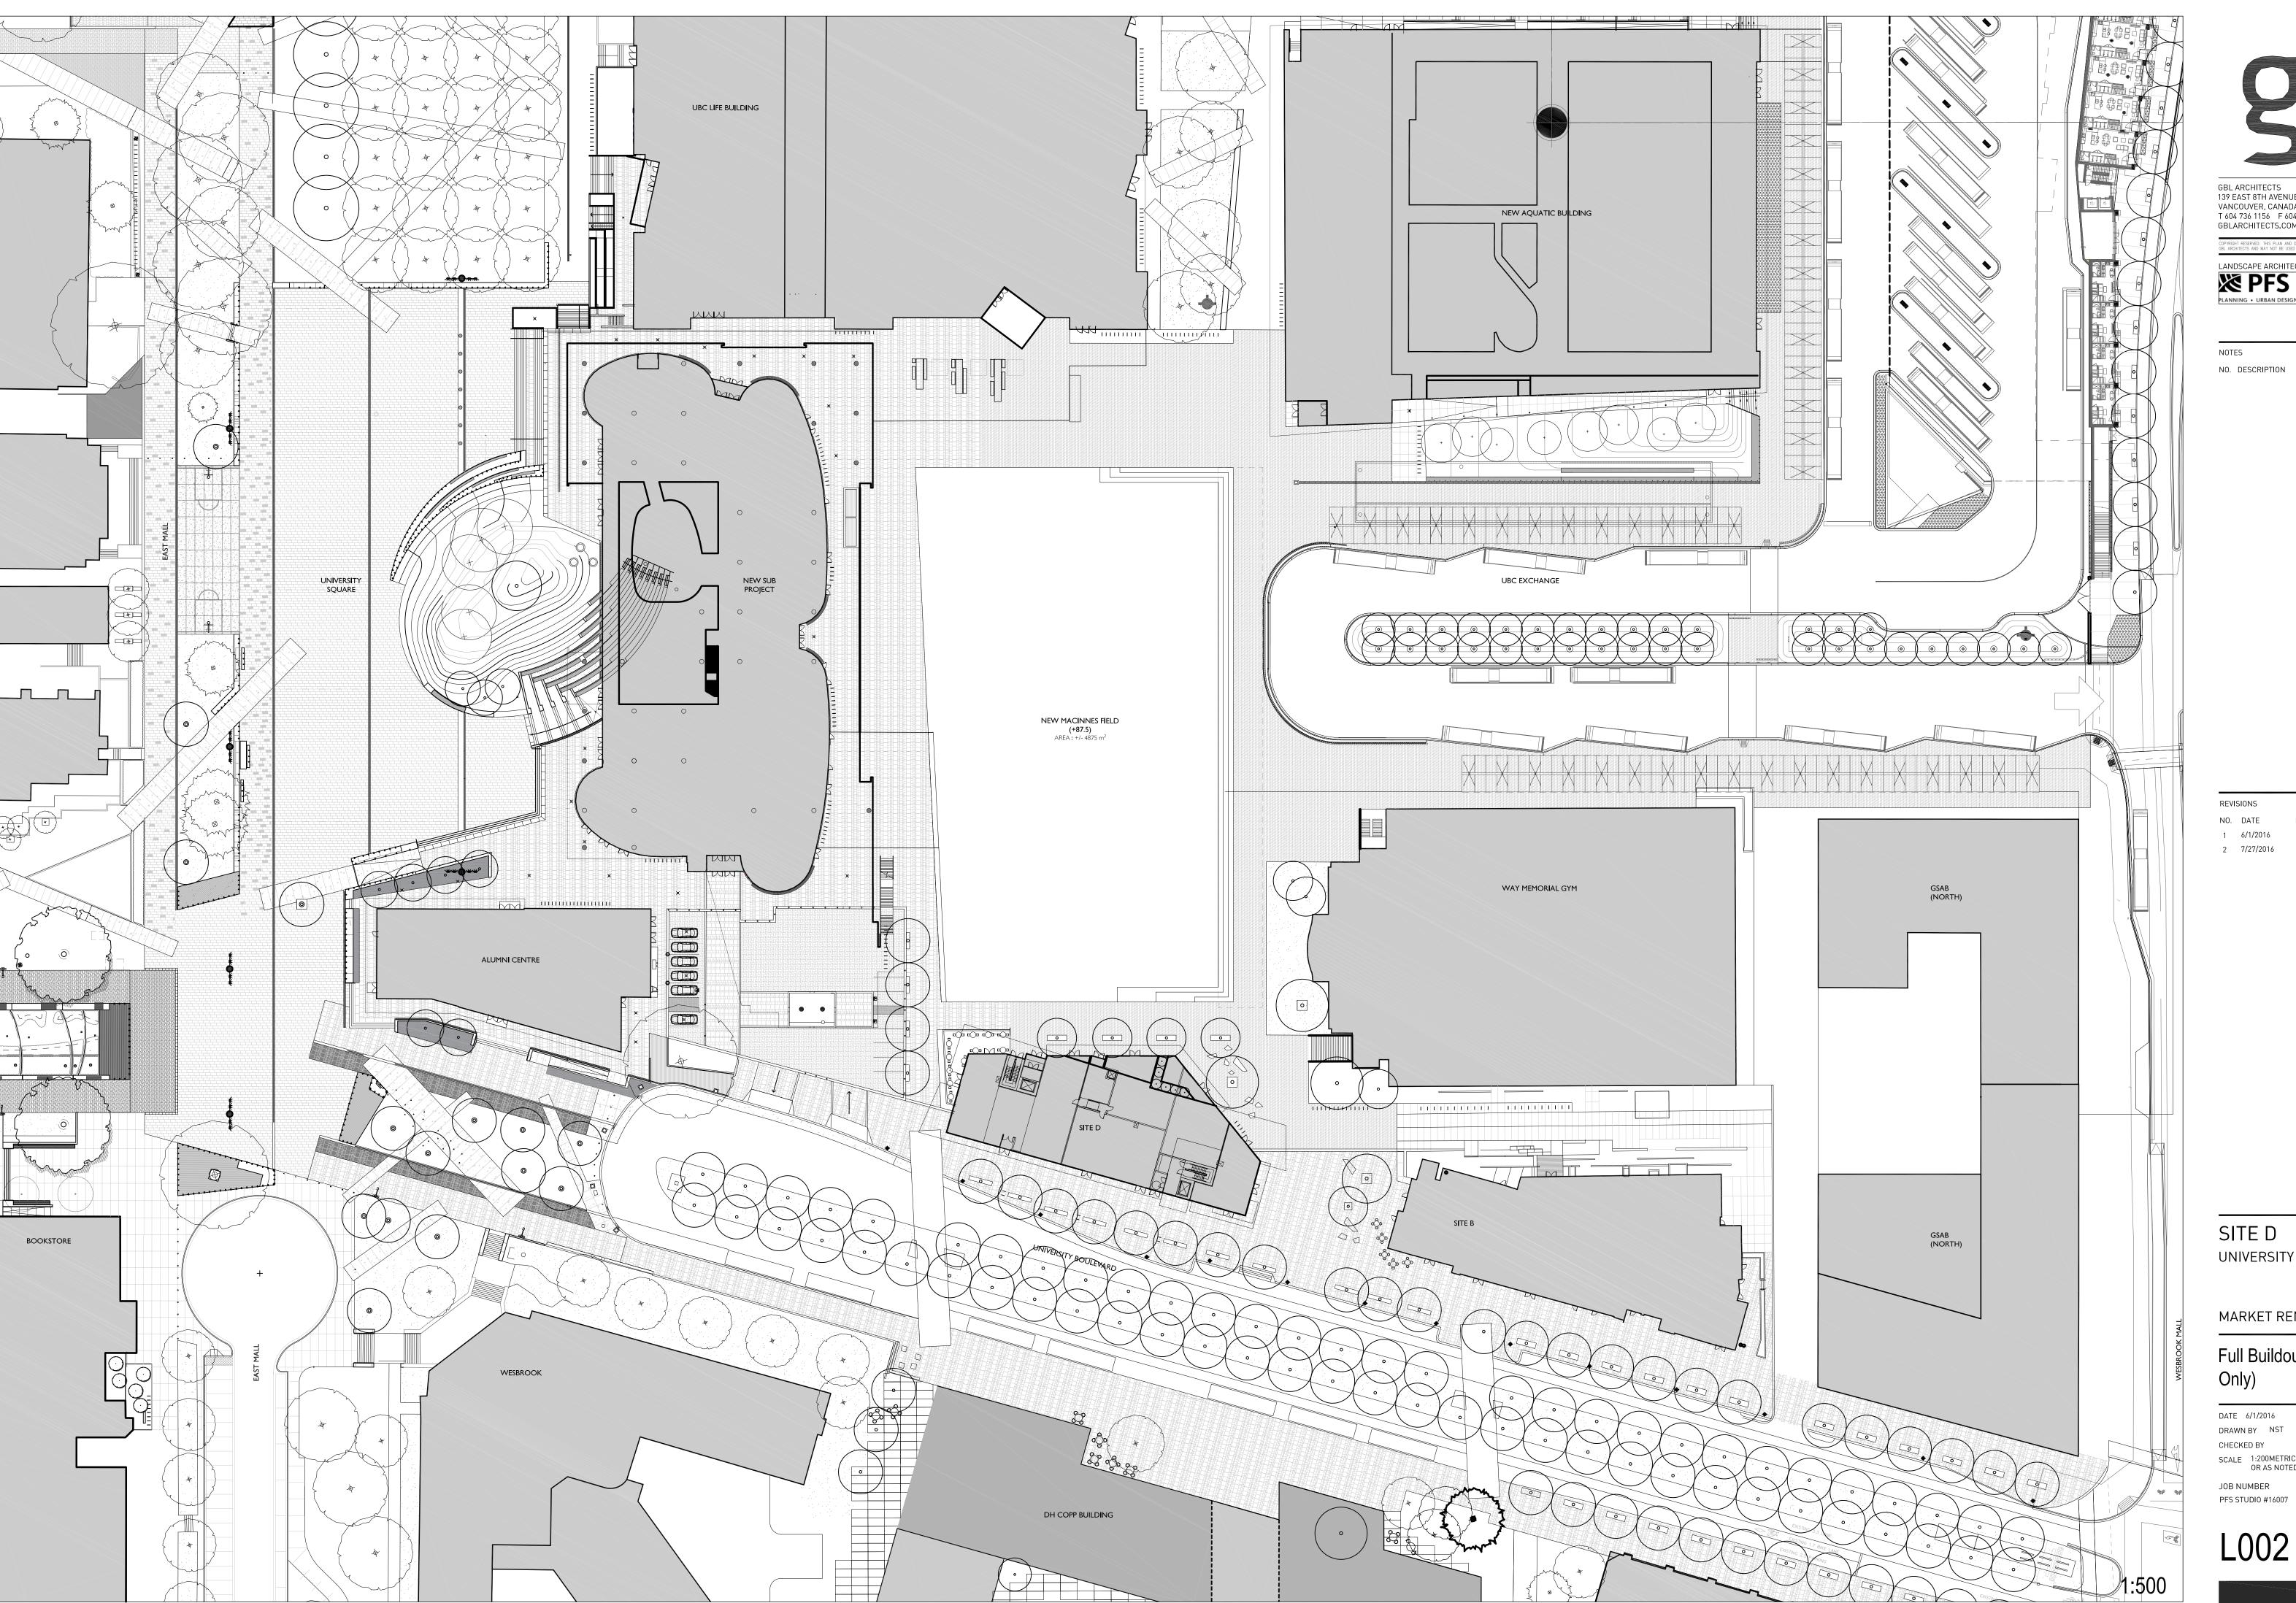



COPYRIGHT RESERVED: THIS PLAN AND DESIGN ARE AND AT ALL TIMES REMAIN THE EXCLUSIVE PROPERTY OF GBL ARCHITECTS AND MAY NOT BE USED OR REPRODUCED WITHOUT THEIR WRITTEN CONSENT LANDSCAPE ARCHITECTS:

NO. DESCRIPTION

REVISIONS

NO. DATE REMARKS 1 6/1/2016 ISSUE FOR DEVELOPMENT PERMIT 2 7/27/2016 RE-ISSUE FOR DEVELOPMENT PERMIT

SITE D

UNIVERSITY BOULEVARD, UBC


MARKET RENTAL DEVELOPMENT

JUNE 2016

Full Buildout (For Reference Only)

DATE 6/1/2016 DRAWN BY NST CHECKED BY SCALE 1:200METRIC OR AS NOTED

1617 JOB NUMBER

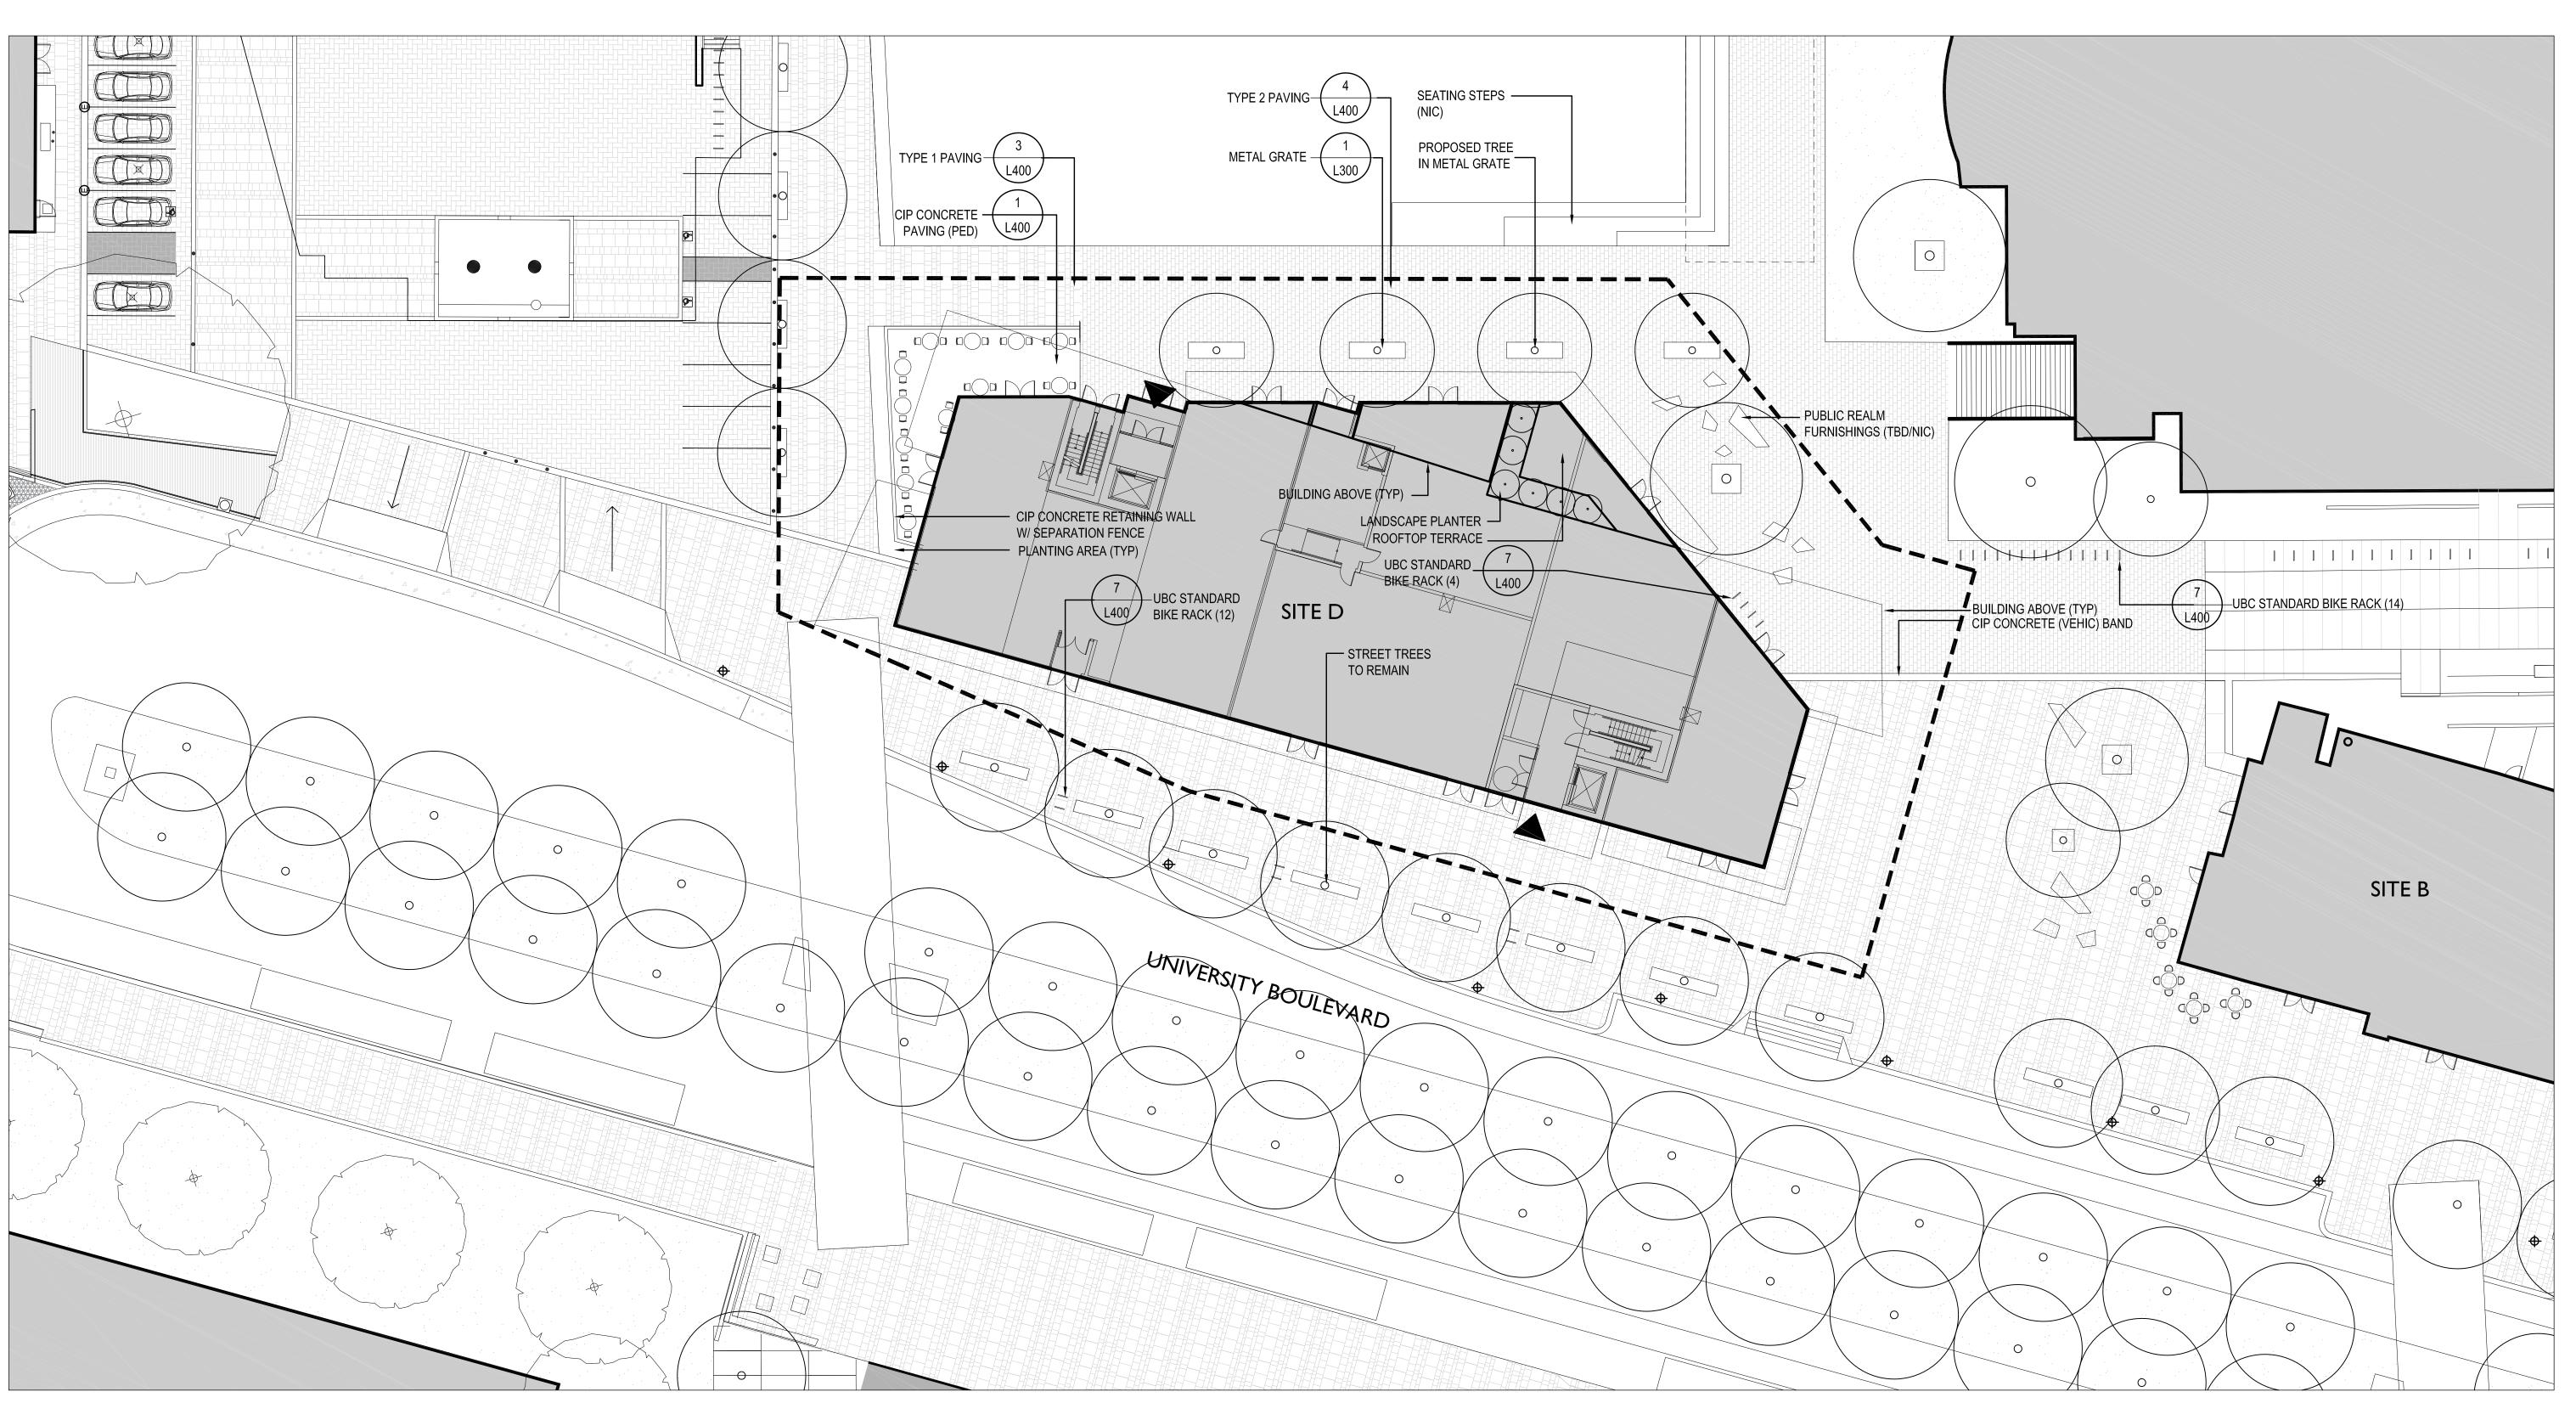

GBL ARCHITECTS 139 EAST 8TH AVENUE VANCOUVER, CANADA V5T 1R8 T 604 736 1156 F 604 731 5279

GBLARCHITECTS.COM

LANDSCAPE ARCHITECTS:

NO. DESCRIPTION

REVISIONS

1 6/1/2016 ISSUE FOR DEVELOPMENT PERMIT 2 7/27/2016 RE-ISSUE FOR DEVELOPMENT PERMIT

LEGEND

RESIDENTIAL LOBBY ENTRY

BIKE RACKS

— EXISTING POLE LIGHT TO REMAIN (U BOULEVARD BUS POLE)

NOTES:


- 1. LIGHT LEVELS TO COMPLY WITH VANCOUVER CAMPUS PLAN AND TO BE ACHIEVED THROUGH EXISTING POLE FIXTURES ALONG UNIVERSITY BOULEVARD AND AMBIENT LIGHT FROM BUILDINGS FOR THE SITE D PROJECT. A FUTURE COMPREHENSIVE LIGHTING STUDY WILL IDENTIFY LIGHTING TREATMENT AND LEVELS FOR THE REMAINDER OF THE PRECINCT INCLUDING MACINNES FIELD AND ATHLETE'S WAY.
- 2. FINAL LOCATIONS OF BIKE RACKS TO BE COORDINATED WITH ARCHITECTS AND CAMPUS+COMMUNITY PLANNING

MATERIALS AND FURNISHINGS





PAVING TYPE 2

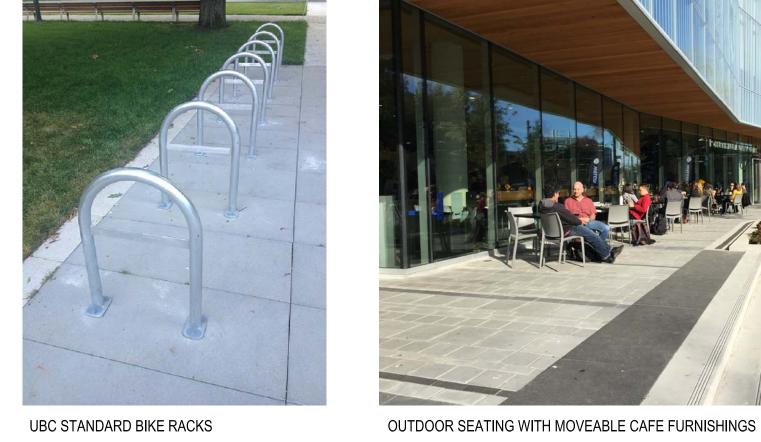





TREE GRATE

SITE D


UNIVERSITY BOULEVARD, UBC

MARKET RENTAL DEVELOPMENT

Site Plan

DATE 6/1/2016 JUNE 2016 DRAWN BY NST CHECKED BY SCALE 1:200METRIC OR AS NOTED

1617 JOB NUMBER PFS STUDIO #16007

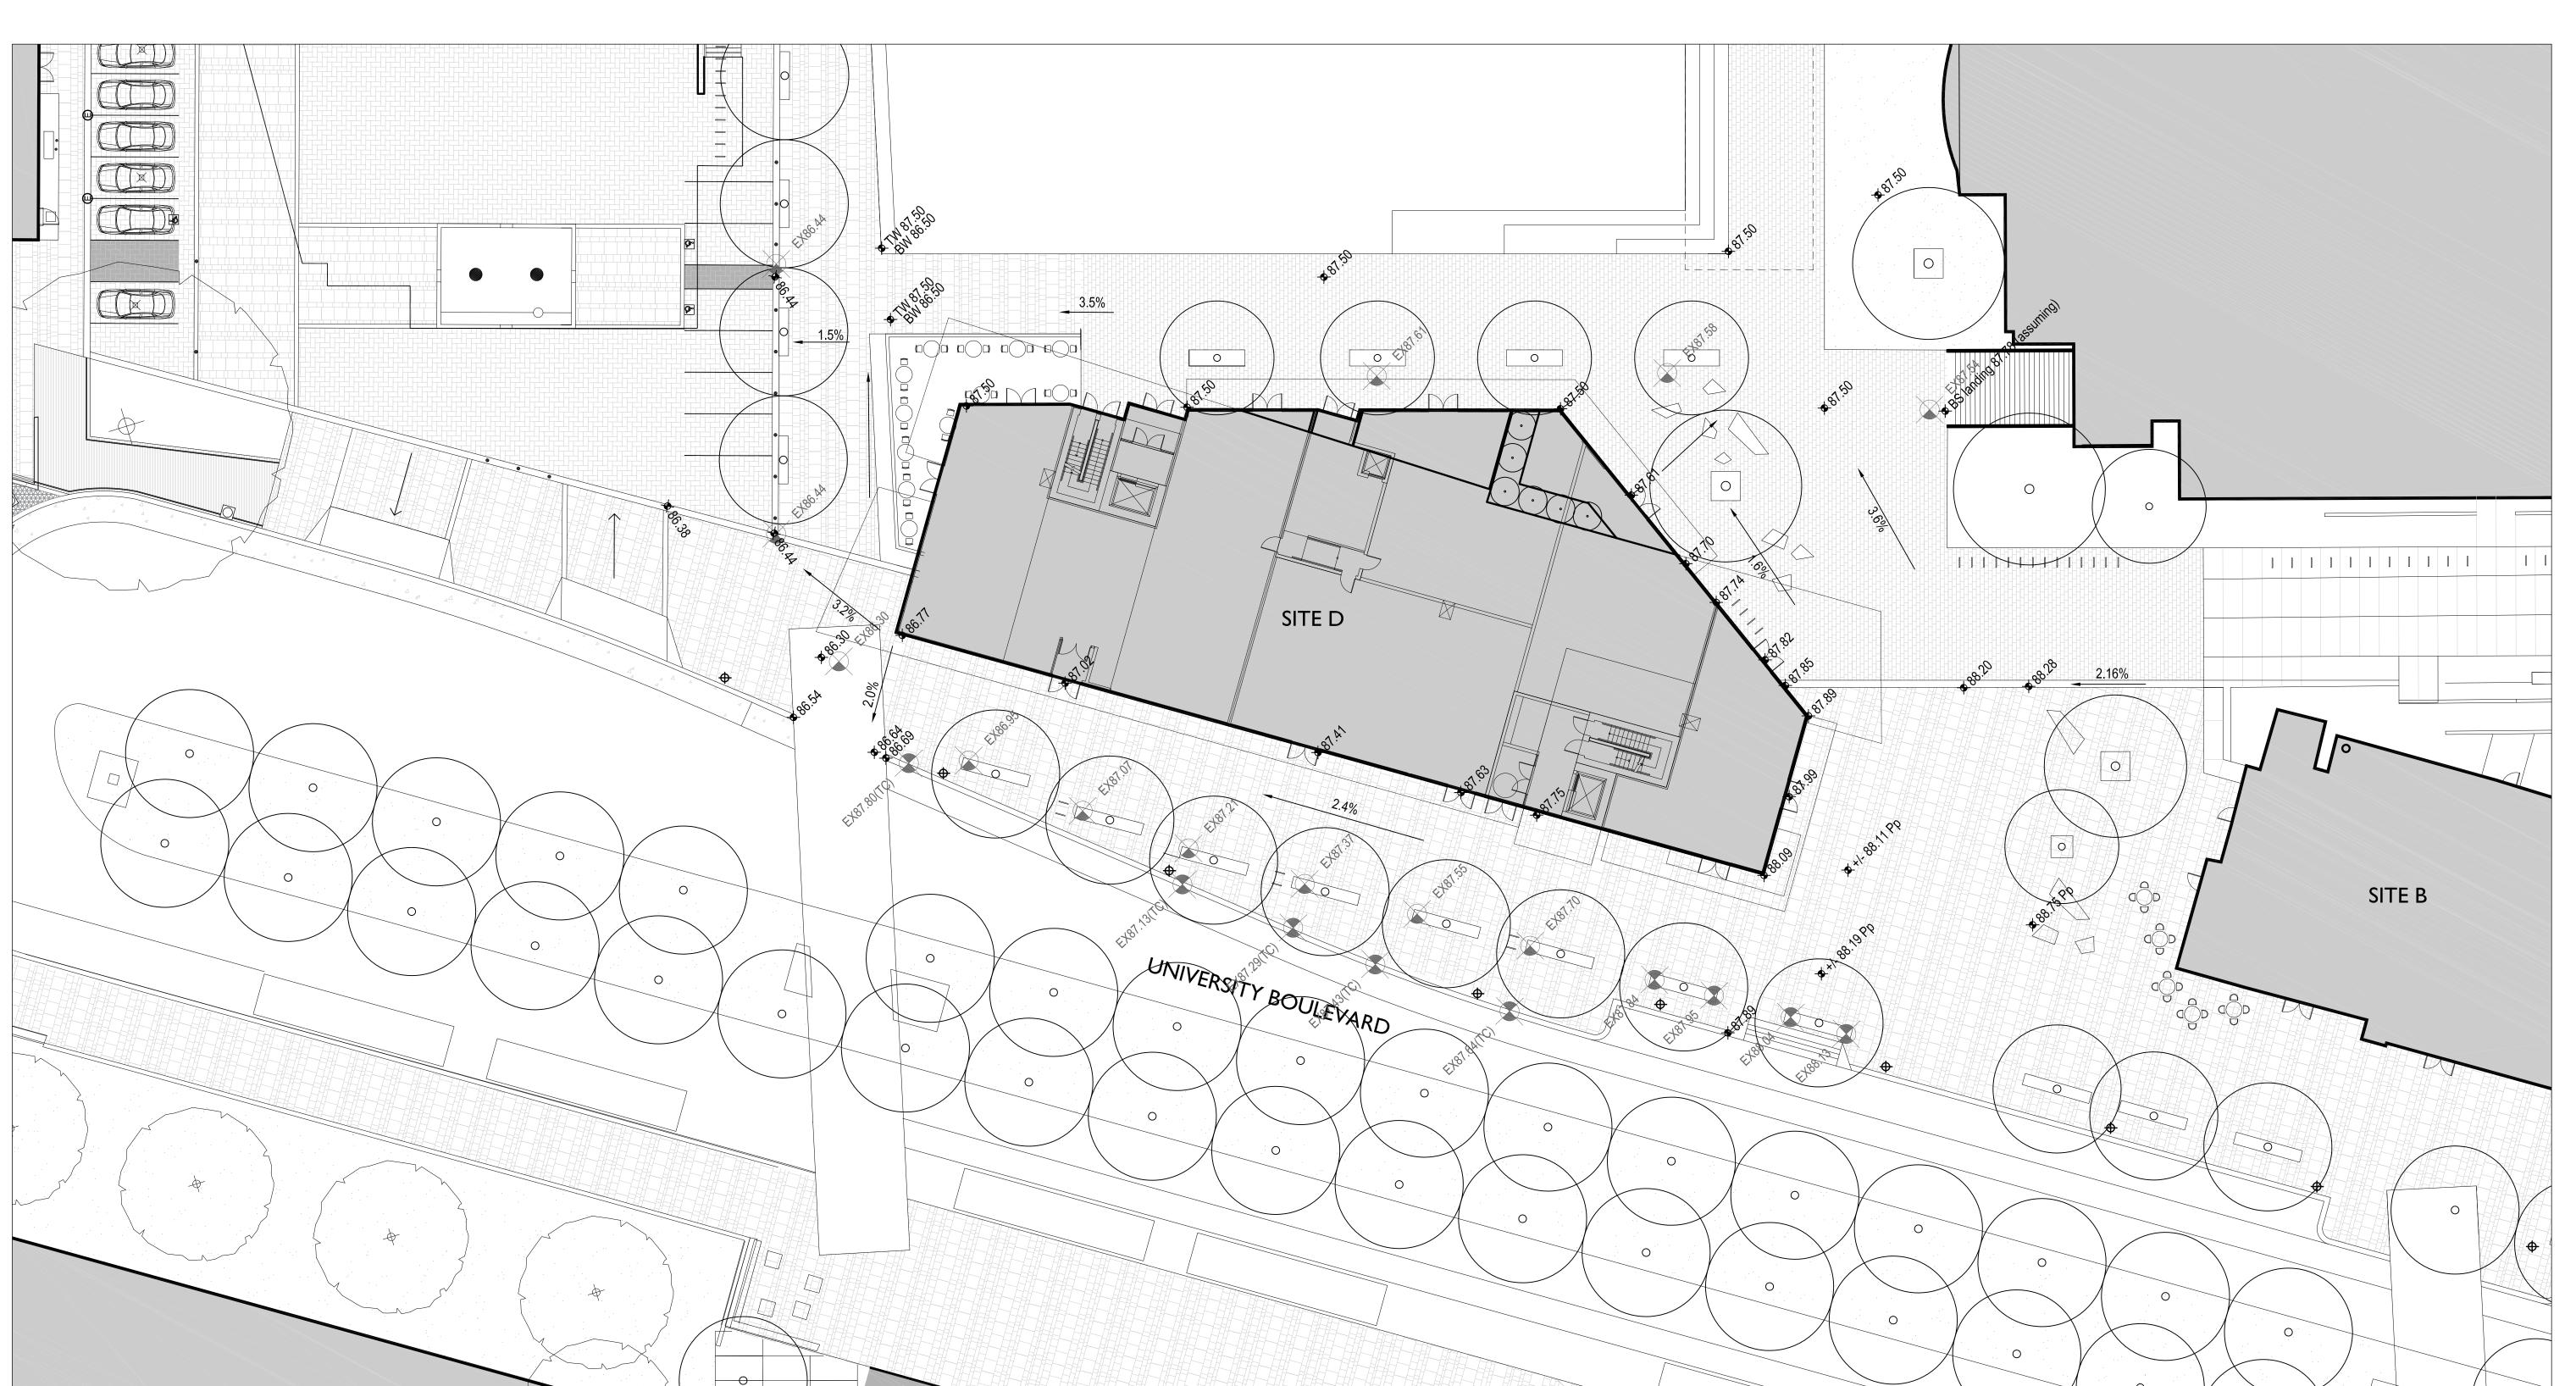

GBL ARCHITECTS
139 EAST 8TH AVENUE
VANCOUVER, CANADA V5T 1R8
T 604 736 1156 F 604 731 5279

GBLARCHITECTS.COM

SCAPE ARCHITECTS:

1777 West 3rd Avenue
Vancouver BC V6J 1K7
604.736.5168
658866 bc ca

NOTES

NO. DESCRIPTION

REVISIONS

NO. DATE REMARKS
 1 6/1/2016 ISSUE FOR DEVELOPMENT PERMIT
 2 7/27/2016 RE-ISSUE FOR DEVELOPMENT PERMIT

GRADING NOTES

- MATCH NEW CONSTRUCTION TO SURROUNDING ESTABLISHED GRADES. REPORT ANY DISCREPANCIES TO THE LANDSCAPE ARCHITECT.
- ALL AREAS ARE TO BE GRADED TO PROVIDE POSITIVE DRAINAGE AND AS SHOWN ON THE PLANS.
 WALL TOPS SHALL RECEIVE A MINIMUM OF 1% SLOPE TO PROVIDE WASH. STEPS TO
- RECEIVE A 2% SLOPE PER DETAILS.

 4. ALL UTILITY COVERS INCLUDING FRAMES, GRATES, CLEAN OUTS, VALVE COVERS AND OTHER SURFACE UTILITY FEATURES SHALL BE ADJUSTED TO MEET FINAL GRADES WITH APPROPRIATE INSTALLATION DETAILS.
- 5. SEATING WALL HEIGHTS NOT TO EXCEED 600MM. REPORT ANY DISCREPANCIES TO THE LANDSCAPE ARCHITECT.
- 6. ALL NEW TREES TO BE PLANTED 1M AWAY FROM UTILITIES.

SITE D

UNIVERSITY BOULEVARD, UBC

MARKET RENTAL DEVELOPMENT

Grading Plan


DATE 6/1/2016


DRAWN BY NST

CHECKED BY

SCALE 1:200METRIC
OR AS NOTED

JOB NUMBER
PFS STUDIO #16007

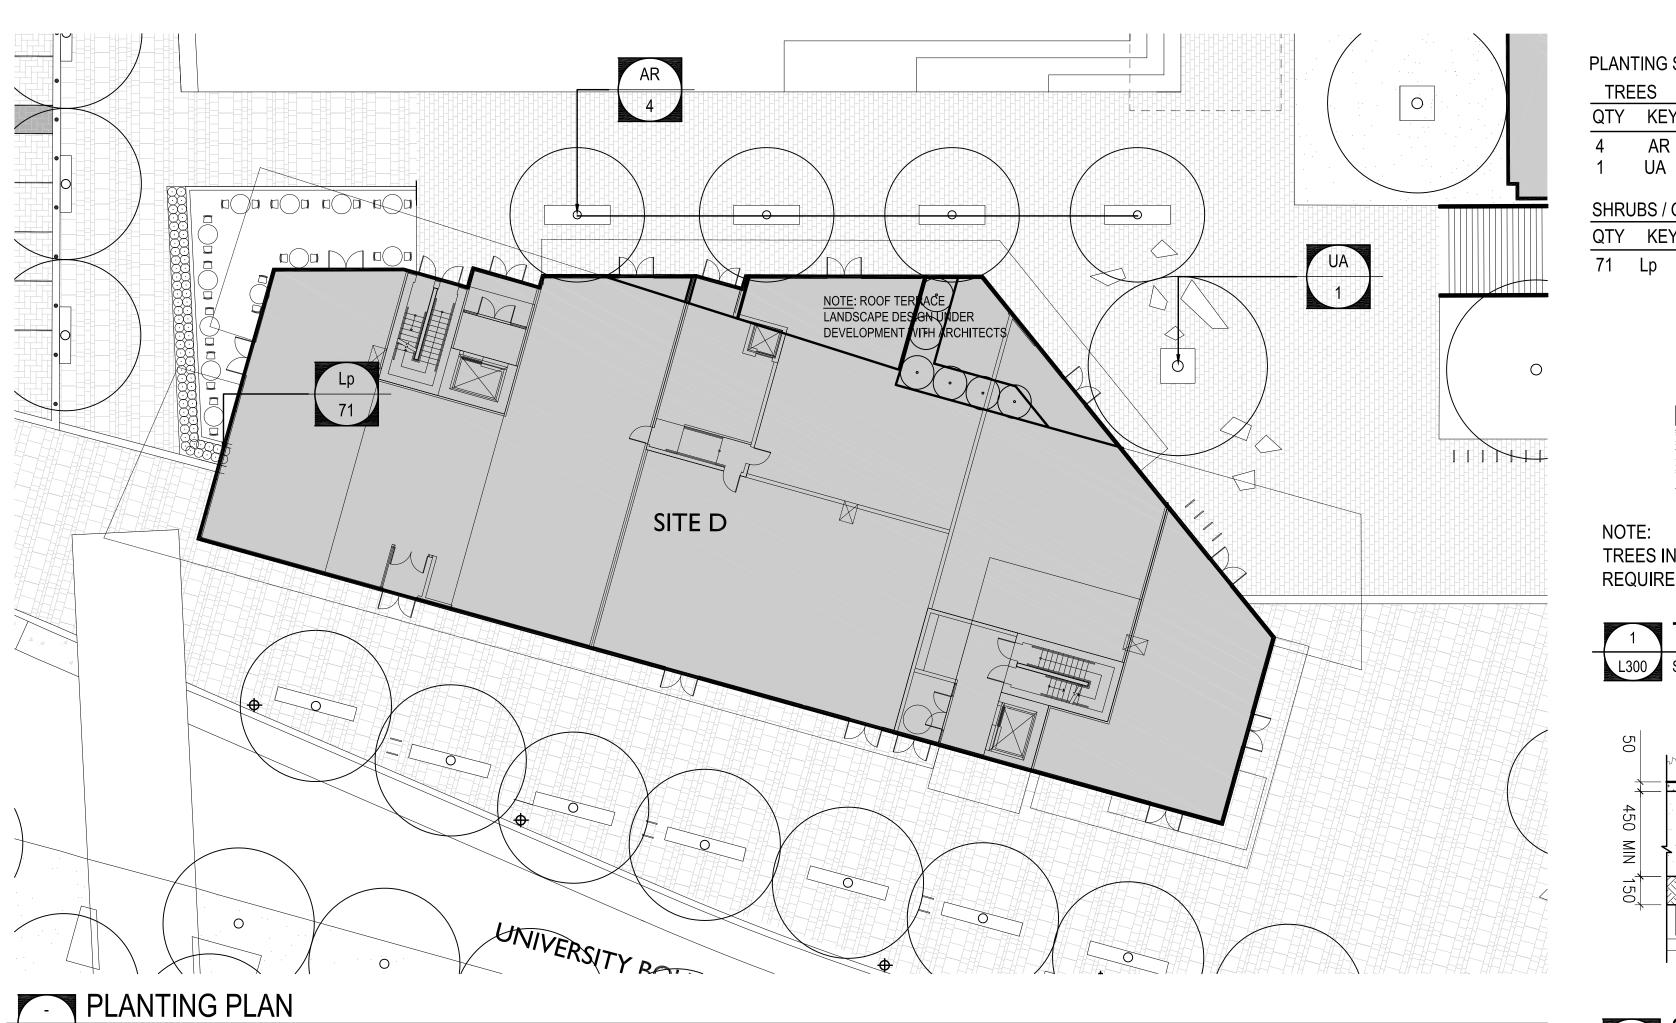

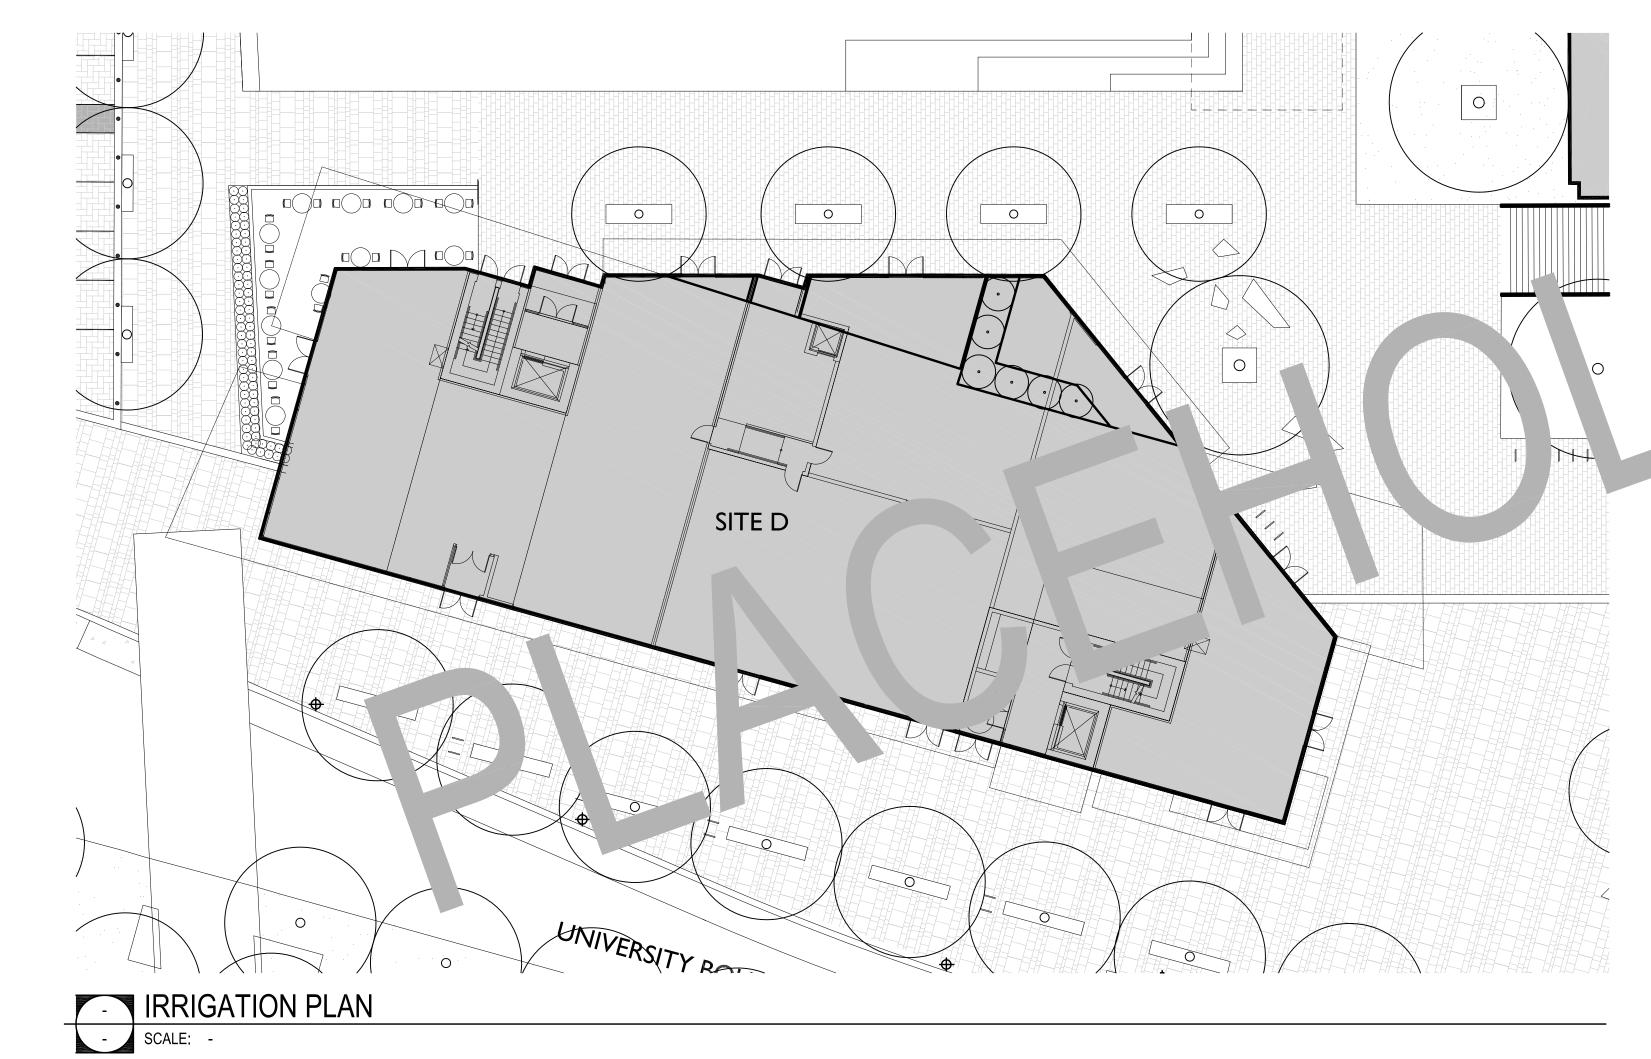


PLANTING SCHEDULE

TREES

QTY	KEY	BOTANICAL NAME	COMMON NAME	SIZE	NOTES
4	AR UA	Acer rubrum 'Red Rocket' Ulmus americana 'Bandon'	Red Rocket Maple Brandon Elm	8cm cal. 8cm hgt.	6' standard 6' standard
SHRU	IBS / GF	ROUNDCOVERS			
QTY	KEY	BOTANICAL NAME	COMMON NAME	SIZE	NOTES

Privet honeysuckle

#2 pot/600mmO.C. Full/matched

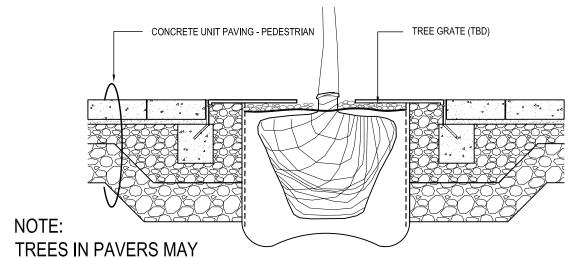



TREES IN PAVERS MAY REQUIRE STRUCTURAL SOIL

TREE GRATE

Lonicera pileata

L300 SCALE: NTS

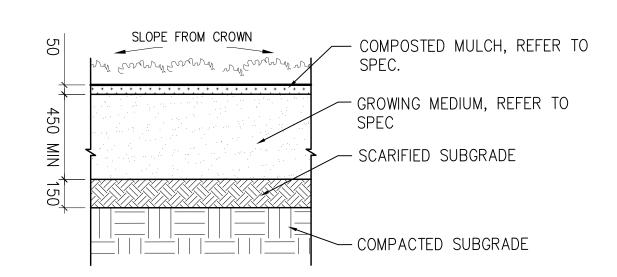

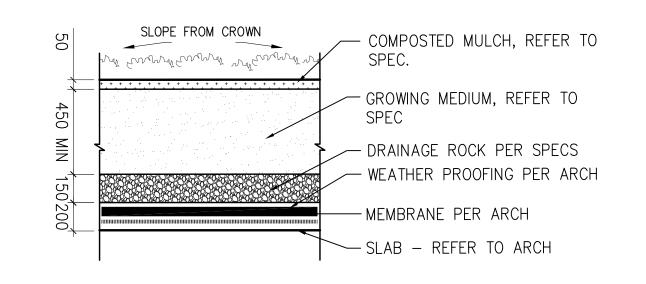



SHRUB PLANTING ON STRUCTURE

L400 SCALE: NTS

REVISIONS

NO. DATE REMARKS 2 7/27/2016 RE-ISSUE FOR DEVELOPMENT PERMIT

GBL ARCHITECTS
139 EAST 8TH AVENUE
VANCOUVER, CANADA V5T 1R8
T 604 736 1156 F 604 731 5279

COPYRIGHT RESERVED: THIS PLAN AND DESIGN ARE AND AT ALL TIMES REMAIN THE EXCLUSIVE PROPER GBL ARCHITECTS AND MAY NOT BE USED OR REPRODUCED WITHOUT THEIR WRITTEN CONSENT

GBLARCHITECTS.COM

NO. DESCRIPTION

IRRIGATION NOTES

IRRIGATION SCHEDULE

1. ALL LANDSCAPE AREAS TO RECEIVE HIGH EFFICIENCY IRROGATION PER UBS STANDARDS AND TECHNICAL GUIDELINES




UNIVERSITY BOULEVARD, UBC


MARKET RENTAL DEVELOPMENT

Planting Plan

DATE 6/1/2016 JUNE 2016 DRAWN BY NST CHECKED BY SCALE 1:200METRIC OR AS NOTED 1617 JOB NUMBER PFS STUDIO #16007

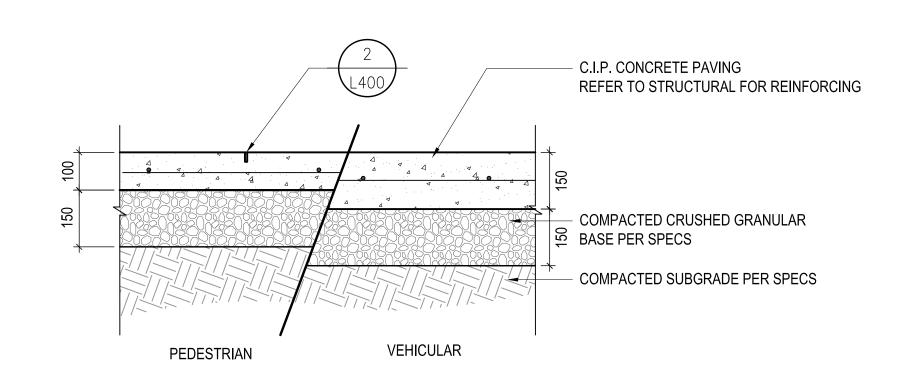


TYPICAL CIP CONCRETE PAVING

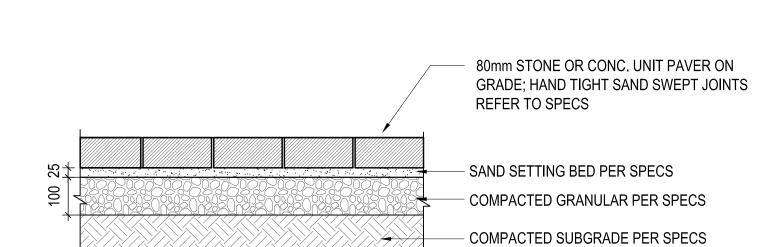


REFER TO LAYOUT PLAN - PAVING FOR LOCATIONS OF STONE PAVERS AND COLOUR

4 PAVING TYPE 2


L400 SCALE: 1:10

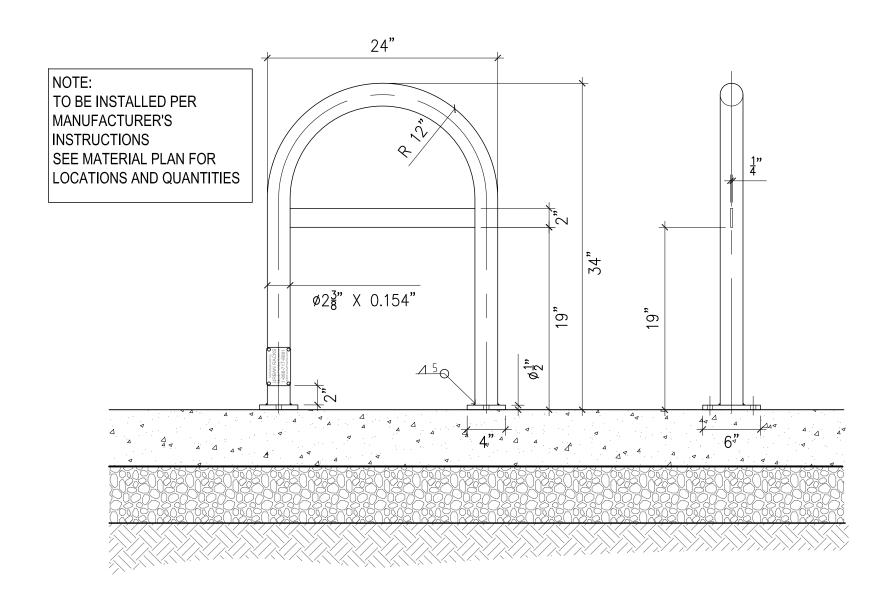




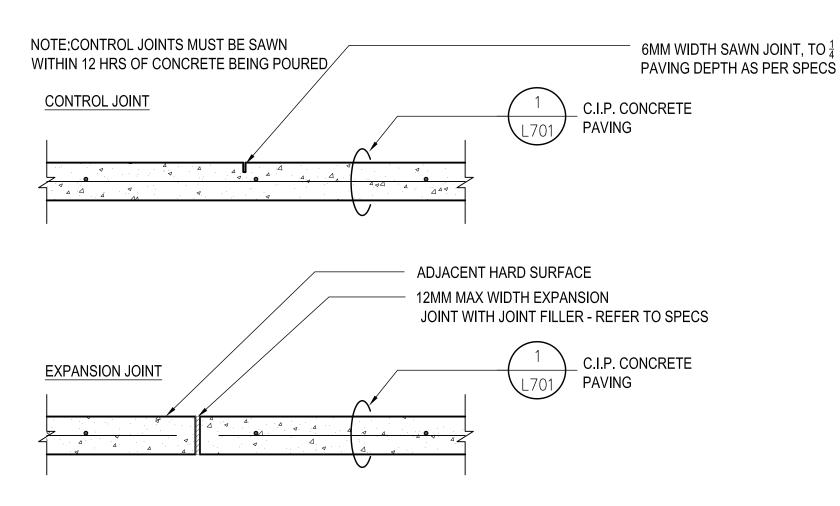


TYPICAL CIP CONCRETE PAVING JOINTS 1400 SCALE: 1:10

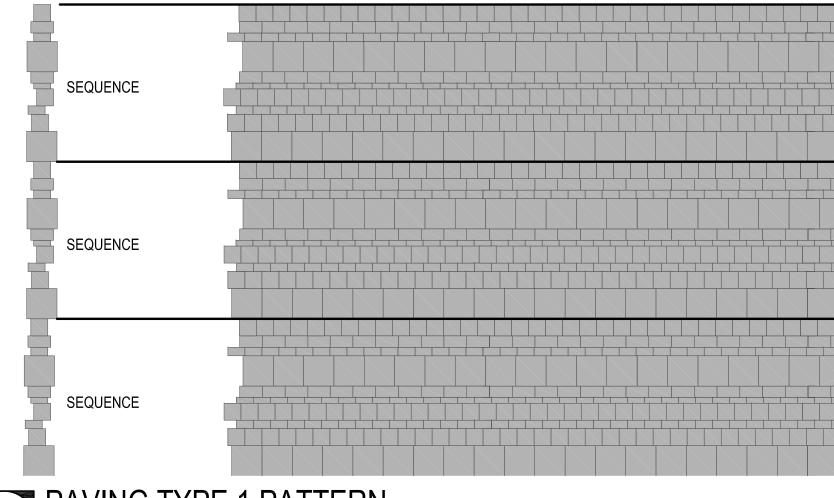


5 PAVING TYPE 1 PATTERN
L400 SCALE: 1:50

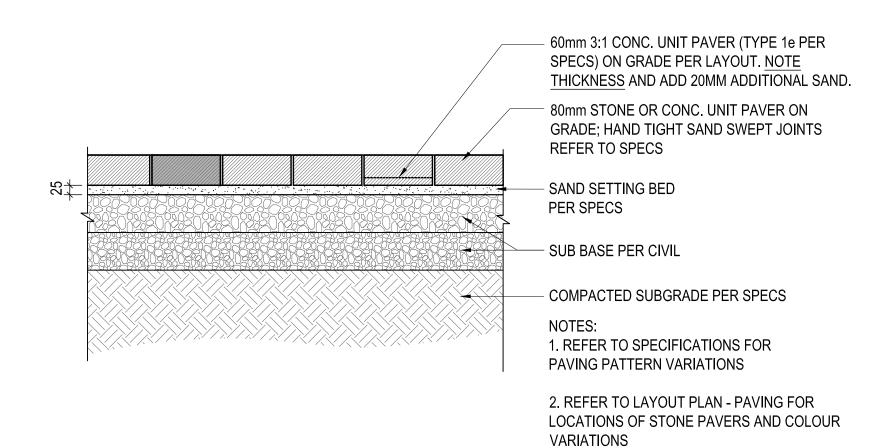

TYPE 1 - UNIVERSITY BOULEVARD STANDARD PAVING L400 SCALE: 1:10

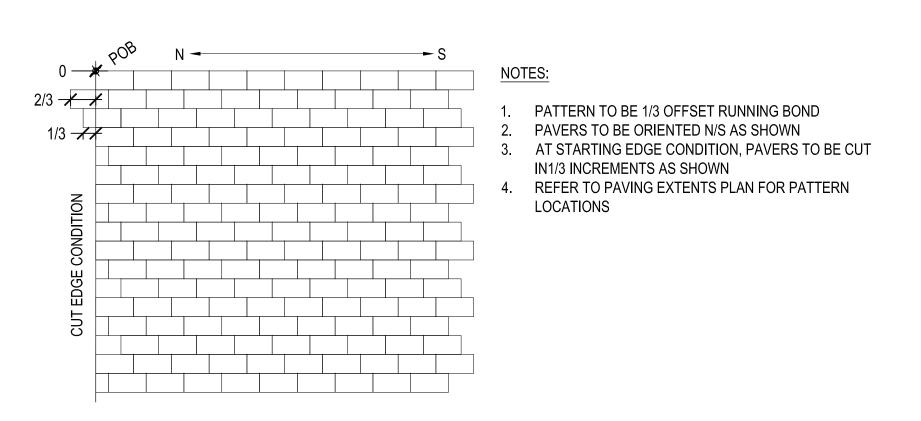



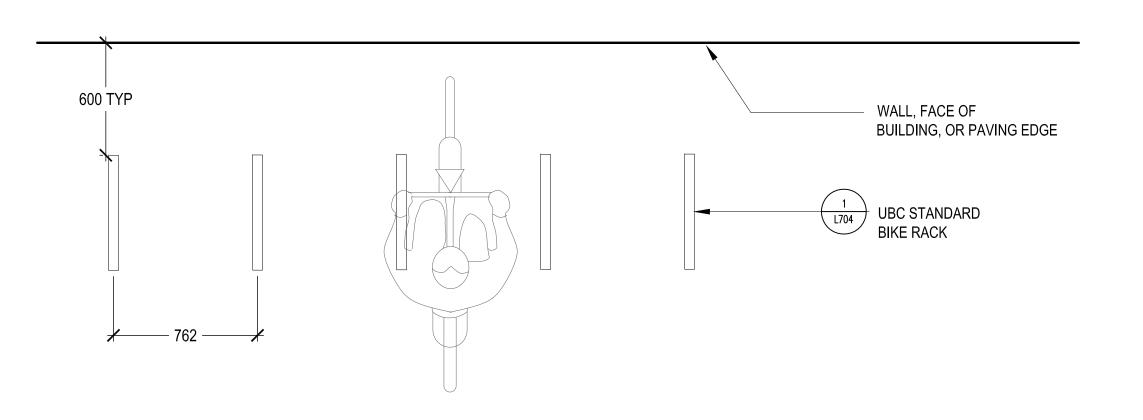





GBL ARCHITECTS
139 EAST 8TH AVENUE
VANCOUVER, CANADA V5T 1R8
T 604 736 1156 F 604 731 5279
GBLARCHITECTS.COM

COPYRIGHT RESERVED: THIS PLAN AND DESIGN ARE AND AT ALL TIMES REMAIN THE EXCLUSIVE PROPERTY OF GBL ARCHITECTS AND MAY NOT BE USED OR REPRODUCED WITHOUT THEIR WRITTEN CONSENT

LANDSCAPE ARCHITECTS:

PLANNING • URBAN DESIGN • LANDSCAPE ARCHITECTURE

Www.nfs.bc.ca

OTES

NO. DESCRIPTION

REVISIONS

O. DATE REMARKS

1 6/1/2016 ISSUE FOR DEVELOPMENT PERMIT
2 7/27/2016 RE-ISSUE FOR DEVELOPMENT PERMIT

SITE D UNIVERSITY BOULEVARD, UBC

MARKET RENTAL DEVELOPMENT

JUNE 2016

TYPICAL DETAILS

DATE 6/1/2016
DRAWN BY NST
CHECKED BY
SCALE 1: 200METRIC
OR AS NOTED

JOB NUMBER 1617 PFS STUDIO #16007