# **UBC Counselling Services Temporary Facility Issued for Development Permit Drawing List Consultant List**



## Background

The current quantity of UBC Student Services health and counselling spaces available on campus is inadequate to meet the demand for services. Additional space is required to reach students most in need and connect them to the appropriate health care professional. A future Integrated Health Services (IHS) centre that will address this need is to be constructed as part of a UBC development project in the near future; however, in the interim, short term secondary support space is required to meet the demand. The objective of this project is to create a temporary solution that can be quickly brought online, and help address this immediate need.

### Description

The project is proposed as a new single storey modular temporary counselling services centre located adjacent to the south entry to the Brock Hall West Building, located on East Mall on the UBC Vancouver campus. Immediately next to student counselling services currently provided within Brock Hall, the proposed modular building will allow counsellors and services to be consolidated into close proximity, facilitating better service and more immediate attention for students.

As the modular counselling facility is to act as a secondary support space to the primary services provided in Brock Hall, the infrastructural requirements are limited. For example, all deliveries and storage for the new temporary building are to be provided via the existing Brock Hall infrastructure, as are all loading and refuse collection services.

The proposed new temporary modular building is 479.4 sqm (5,160 sq.ft) in size, and is expected to remain in place for three to five years, after which it may be relocated to an alternate site and re-purposed. No additional information as to potential future uses has been determined or provided.

### Design and Identity

The project brief is defined by the need to rapidly design and construct a modular counselling facility that meets the design and programmatic area requirements, while is also relocatable and capable of re-purposing for future alternative uses.

The scale of the building is driven by the modular manufacturing process, and is a single storey composition of multiple component modules, connected on site. The identity of the building is respective of the sensitive nature of the programme in that it presents a restrained, staid facade set against the active contextual background.

Although a temporary building, the material palette supports a campus cohesiveness through simple architectural, landscape and paving materials, in keeping with the UBC Campus Plan design strategies. The materials are robust and durable, with a mix of warm dark and light grey cementitious panel cladding, accented by warm, durable Accoya wood perimeter window surrounds that provide both solar shading and visual privacy benefits.

# Sustainability and Energy

A sustainable approach is fundamental to this project as it revolves around resource efficiency, reuse, and land use benefits. Further, in alignment with the UBC Green Building Action Plan, the sustainability objectives of this project aim to reduce Thermal Energy Demand Intensity (TEDI) and Energy Use Intensity (EUI) to meet UBC targets.

Ryder Architecture	DP0.01	Cover Sheet
003-1290 Homer St.	DP0.02	Context Plan
Vancouver BC	DP0.03	Site Plan
V6B 275	DP0.04	Site Photos
604-260-7400	DP0.05	Fire Access Plan
Warren Schmidt - Architect AIBC	DP0.06	Shadow Studies
	DP1.01	Floor Plan
Metric Modular - Builder	DP1.02	Roof Plan
1825 Tower Road,	DP2.01	Sections
Agassiz BC	DP2.02	Sections
VÕM 1A2	DP3.01	Elevations
604-796-2257	DP3.02	Exterior Finishes
Glen DeCoste - Project Manager	DP3.03	Exterior Views
Omega Associates Engineering – Structural	L1	Landscape Plan
18525 53 Ave, #217	L2	Landscape Details
Surrey, BC		
V3S 7A4	E101	Lighting Plan
604-372-4800		0 0
Doug Clough - Structural Engineer	18-5038C-01	Utility Key Plan
	18-5038C-02	, ,
Aplin & Martin - Civil		Grading Pan (forth
1818-1177 West Hastings St		0 (
Vanaaliyar PC	0612an 10	Sito Survov

Vancouver BC V6E 2K3 604-678-9434 Roy Skeet - Civil Engineer

**ASN Technical Services - Electrical** 12618 62 Ave Surrey, BC V3X 1V5

604-724-0701 Shivjeet Sidhu - Electrical Engineer

ITEC Systems Design - Mechanical 20092 93a Ave Langley, BC V1M 3Y4 604-882-9500 Harold Forsyth - Mechanical Engineer

Johnson Controls - Sprinklers 1485 Lindsey Place Delta, BC

V3M 6V1 604-527-2848 James Mulligan

Aqua Coast Engineering – Building Envelope Unit 201 – 5155 Ladner Trunk Road

Delta, BC V4K 1W4 604-946-9910 Erin Maclellan

SW Landscape Architect

919 Melbourne Avenue North Vancouver, BC V7R 1N8 778-834-8959 Steve Wong

# **Project Statistics**

Gross Building Area (Exterior Footprint) Programmed Areas Circulation Areas : Net Structure :

Site Area (extents as indicated on site plan): 770.9sqm (8298.2sqft) Note: Site area/boundary determined by proponent based on reduced impact to existing infrastructure and vegetation.

Site Coverage:

FSR:

Building Height (modular building height): (base)

## Setbacks:

North (from site boundary) North (face of Brock Hall West) East (from site boundary) East (face of Brock Hall East) South (facing The Bosque) West (from site boundary)

Parking: Not applicable Loading:

Not applicable Exclusions:



DRC Comment

16/05/2019 17/06/2019

ape Plan ape Details

lev Plan & Sediment Control Plan Pan (forthcoming under separate cover)

479.4sqm (5,160sqft) 443.6sqm (3964sqft) 75.3sam (811saft) 35.7sqm (385sqft)

62.2%

0.62

3.35m (11') 1.5m (5'0)max. 0.1m (0'4")min.

0.0m (0'0") 4.69m (15'4") 0.0m (0'0") 16.11m (52'10") Not applicable 7.52m (24'8")

No loading required, existing Brock Hall loading to be utilized

Metric Modular A Triple M Company Ryder

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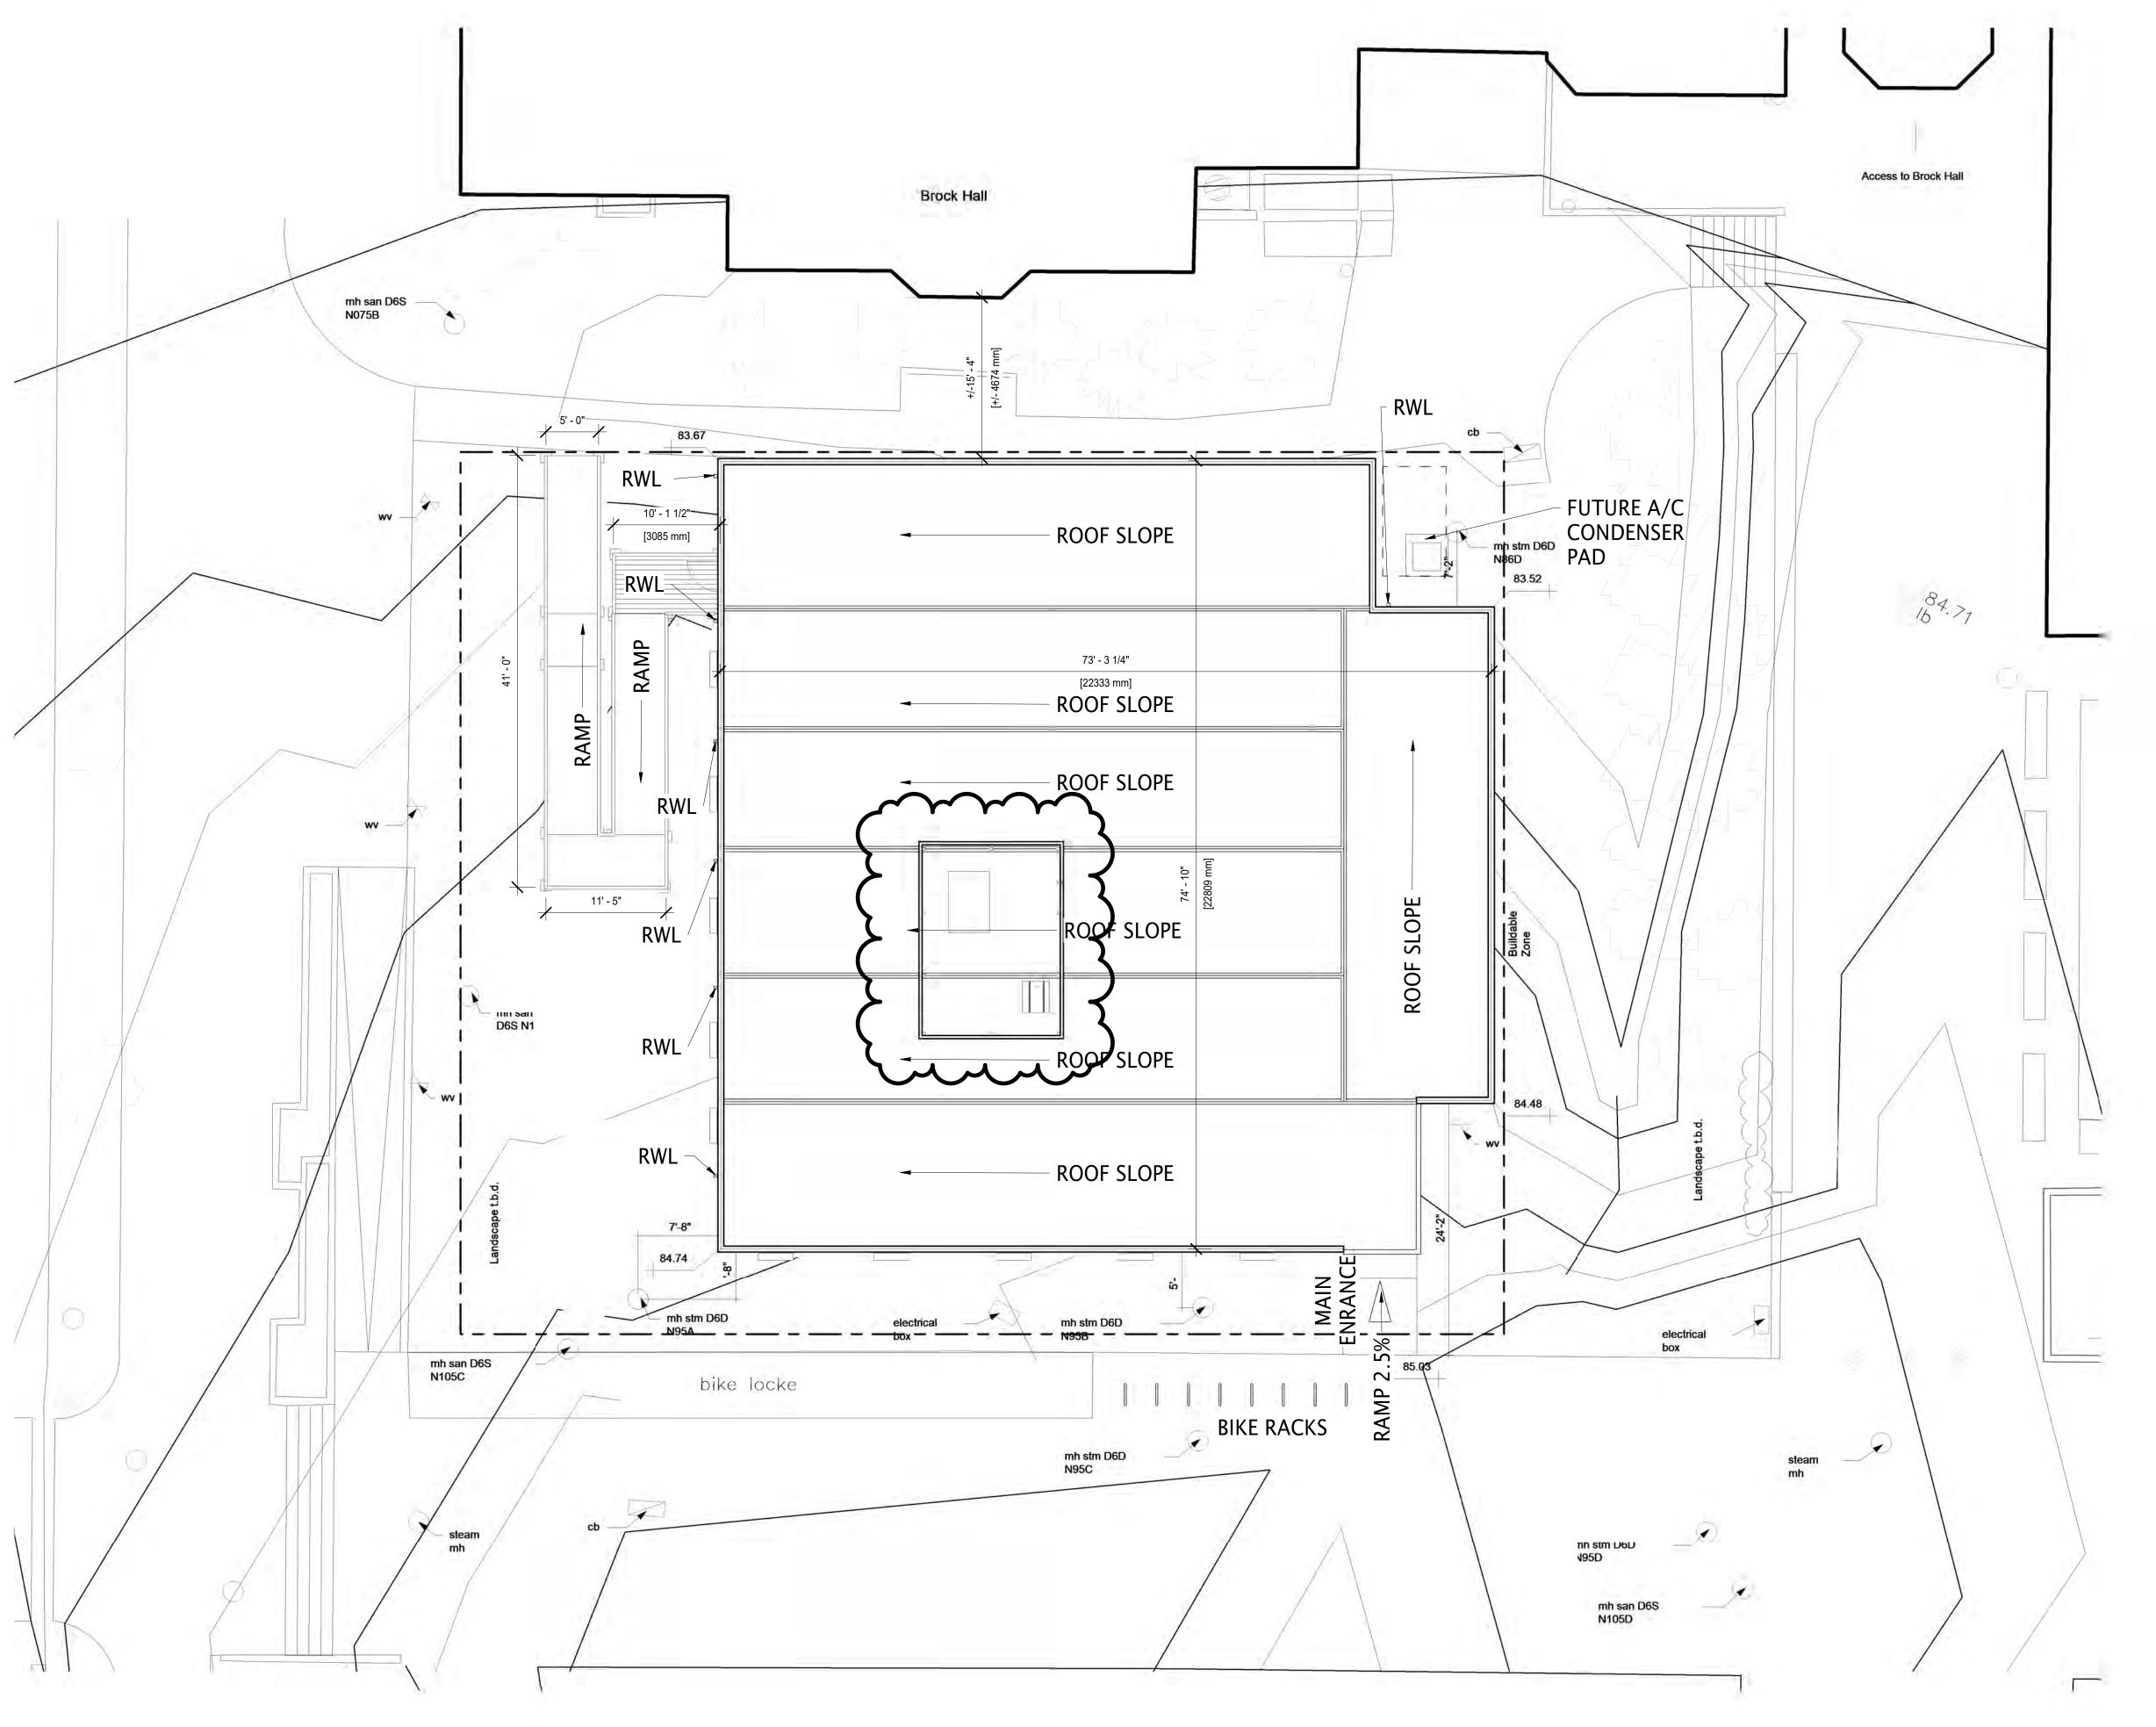
www.ryderarchitecture.ca info@ryderarchitecture.ca

Infrastructure Development, Project Services **UBC** Counselling Services 930 East Mall, Vancouver, BC V6T 1Z1


Project ID.	Project No. <b>1837300-</b>	Scale @ 22x34 <b>12" = 1'-0"</b>
Author	Checker	
Drawn by	Checked by	Status

**Cover Sheet** 







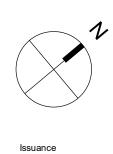

Revision 1

Date Date 1

Rev	Description	Date	
2	Final Loc'n, RT HRV	06 14 19	
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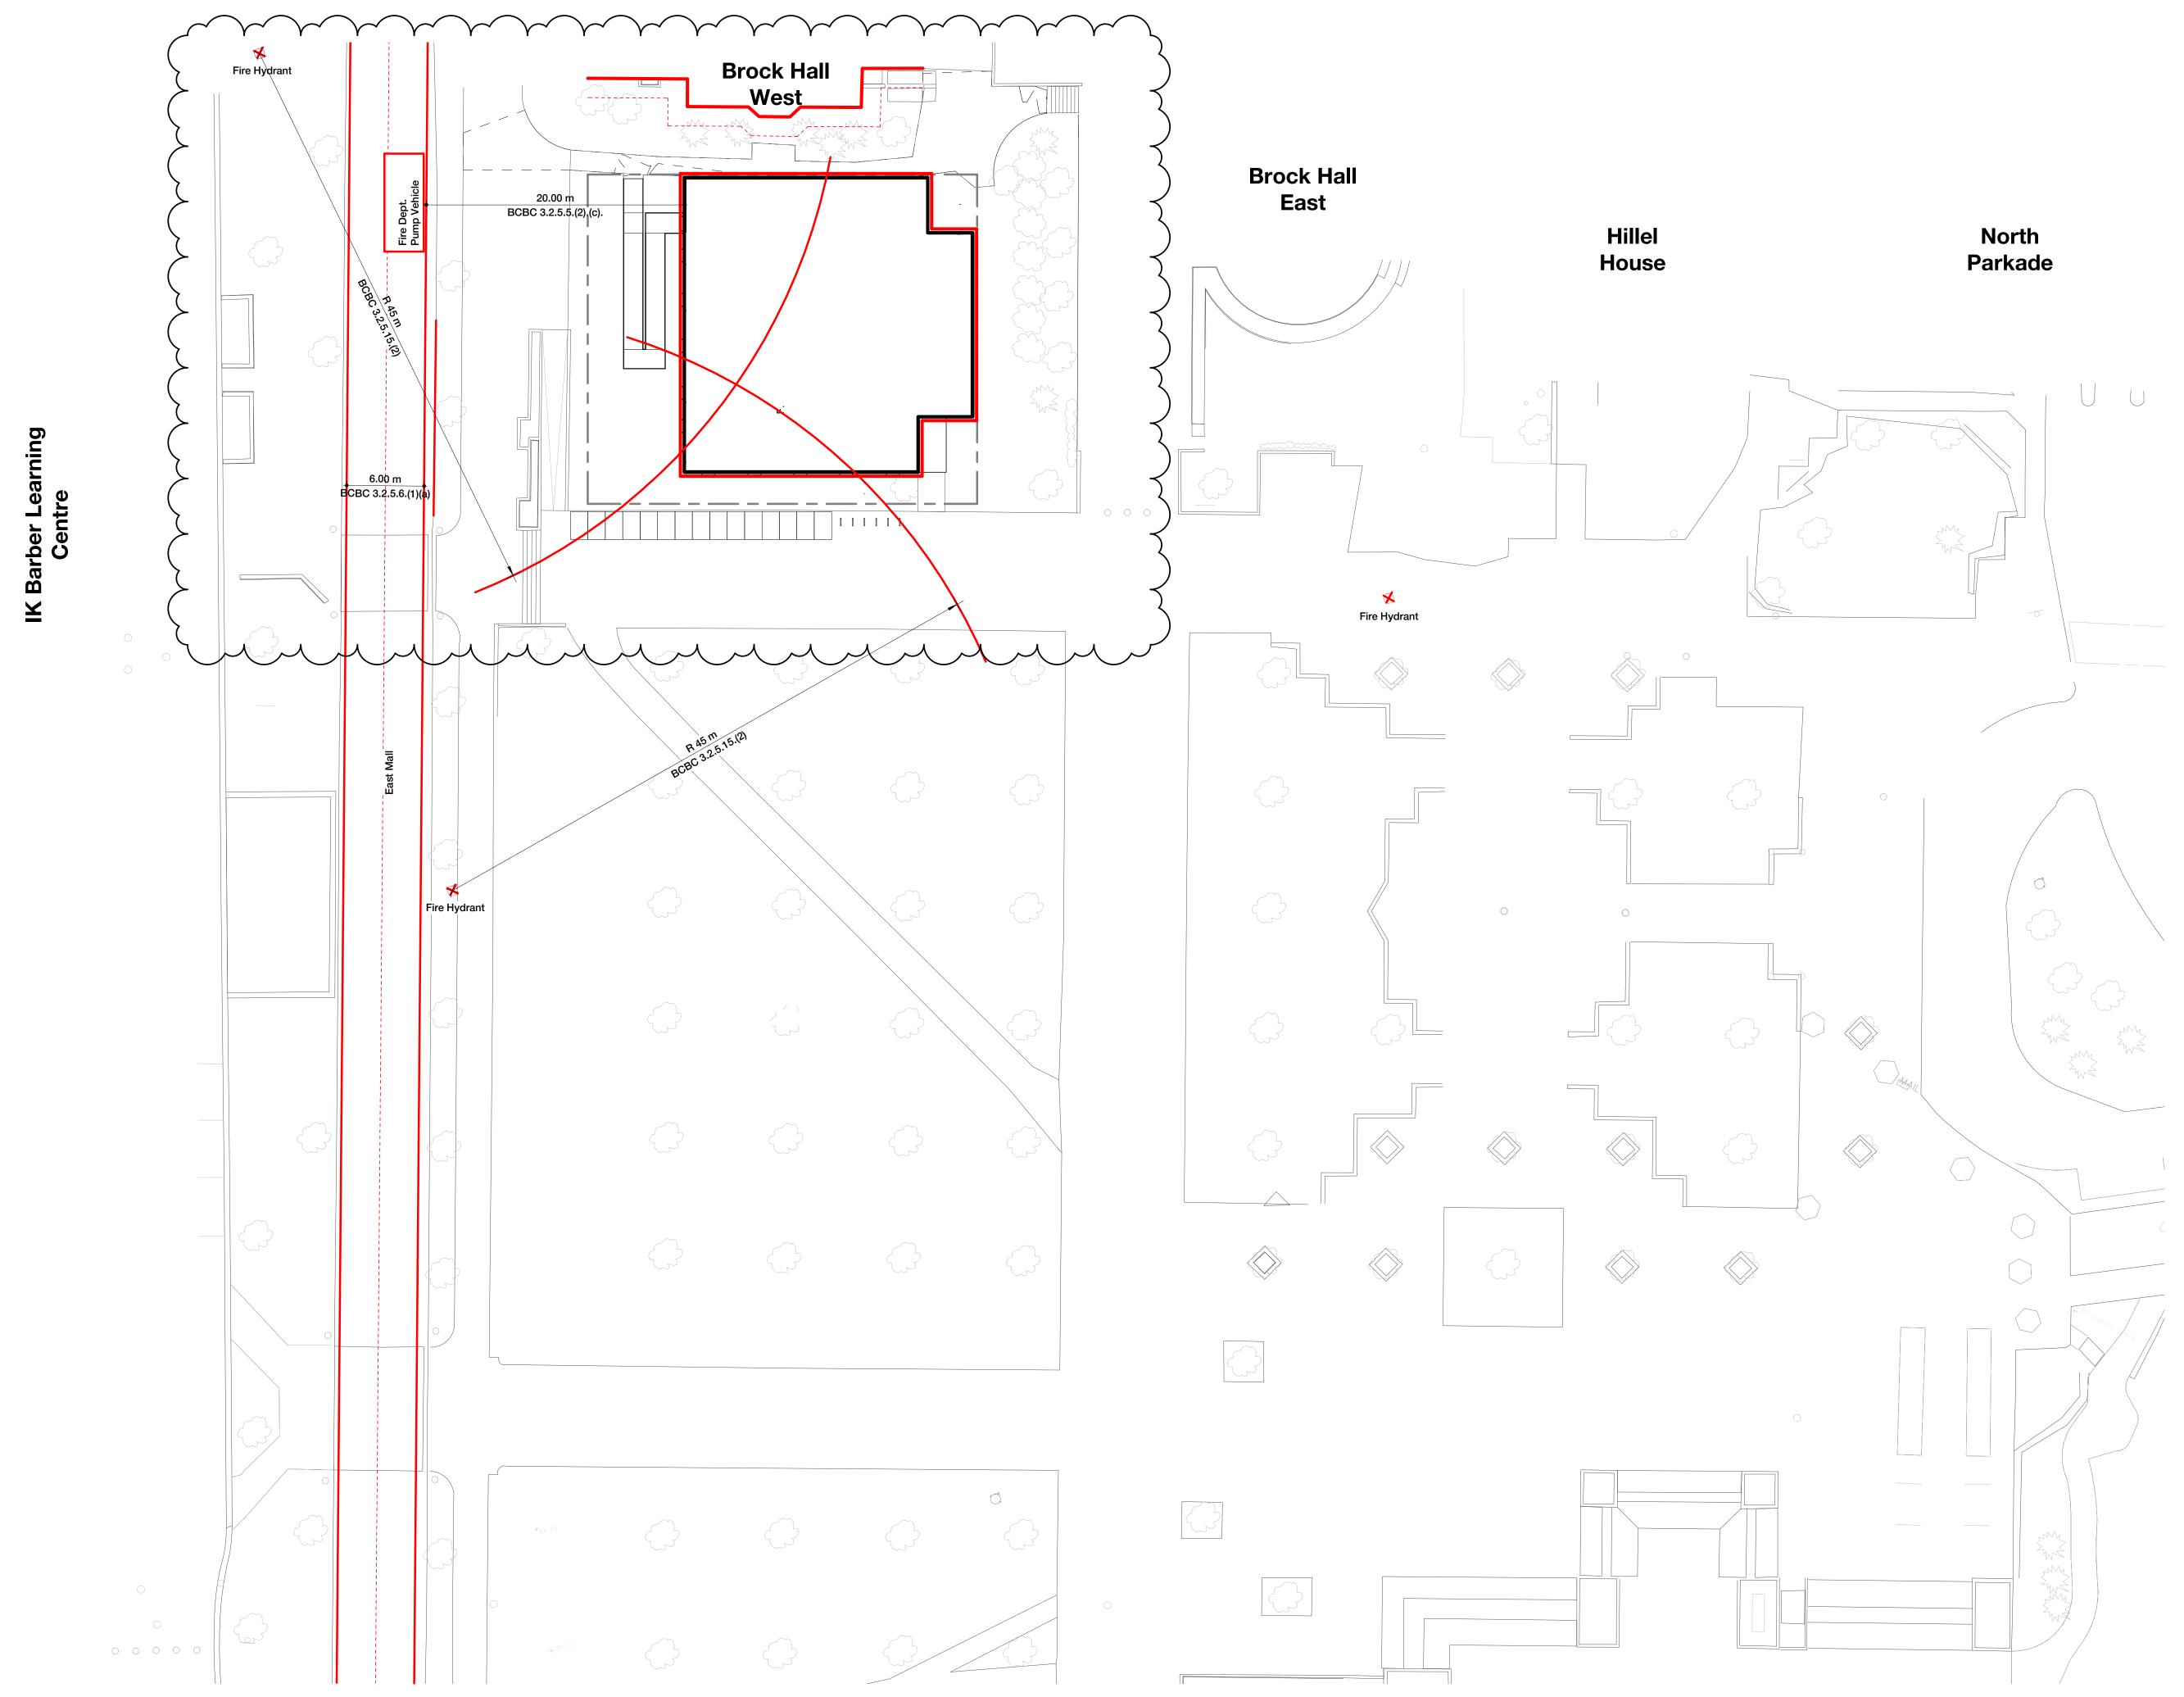
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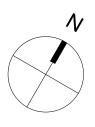
### Project Infrastructure Development, Project Services UBC Counselling Services 1930 East Mall

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Project ID.	Project No.	Scale @ 22x34
	1837300-	1/8" = 1'-0"

Drawing Site Plan







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Date 16/05/2019 17/06/2019





Date

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Rev Description


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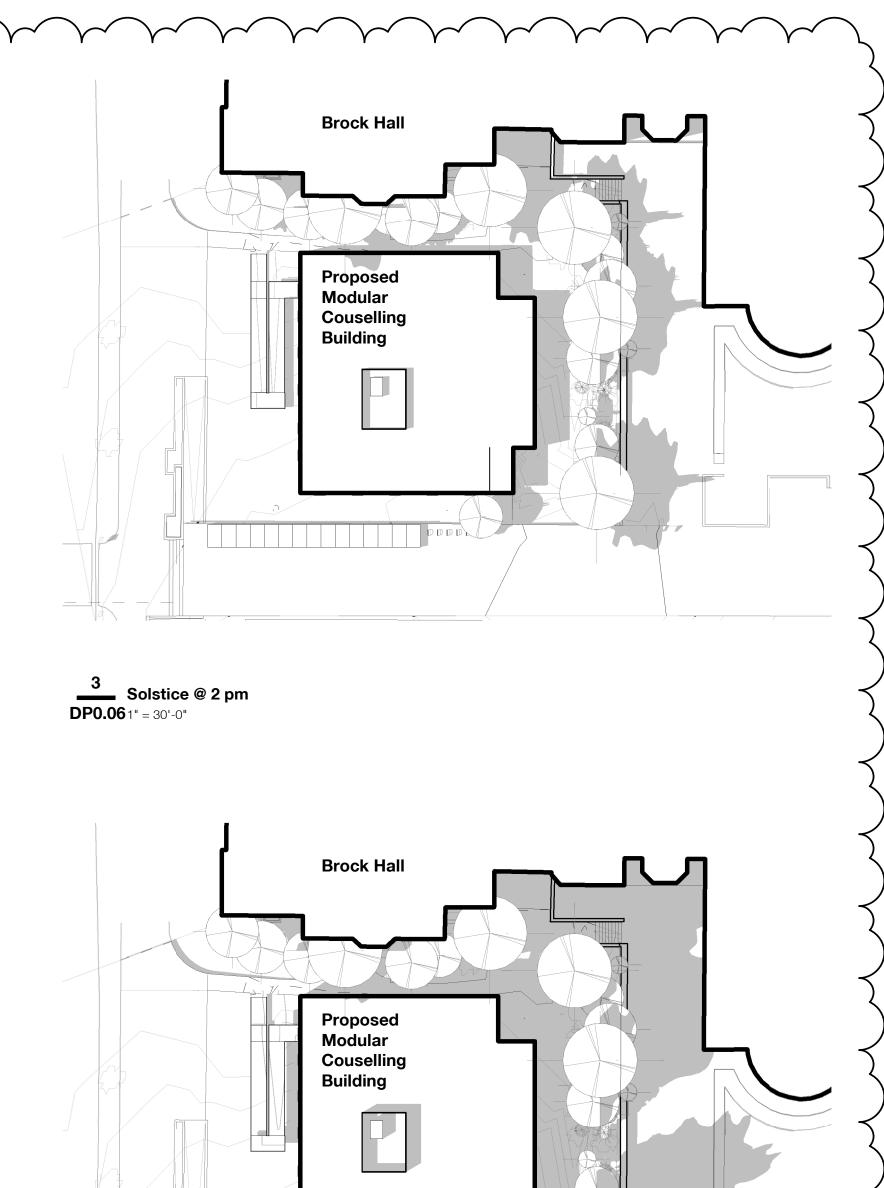
Project Infrastructure Development, Project Services UBC Counselling Services 1930 East Mall, Vancouver, BC V6T 1Z1

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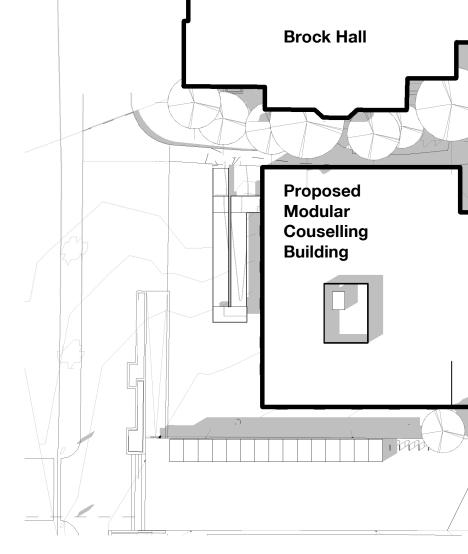
Fire Response Plan





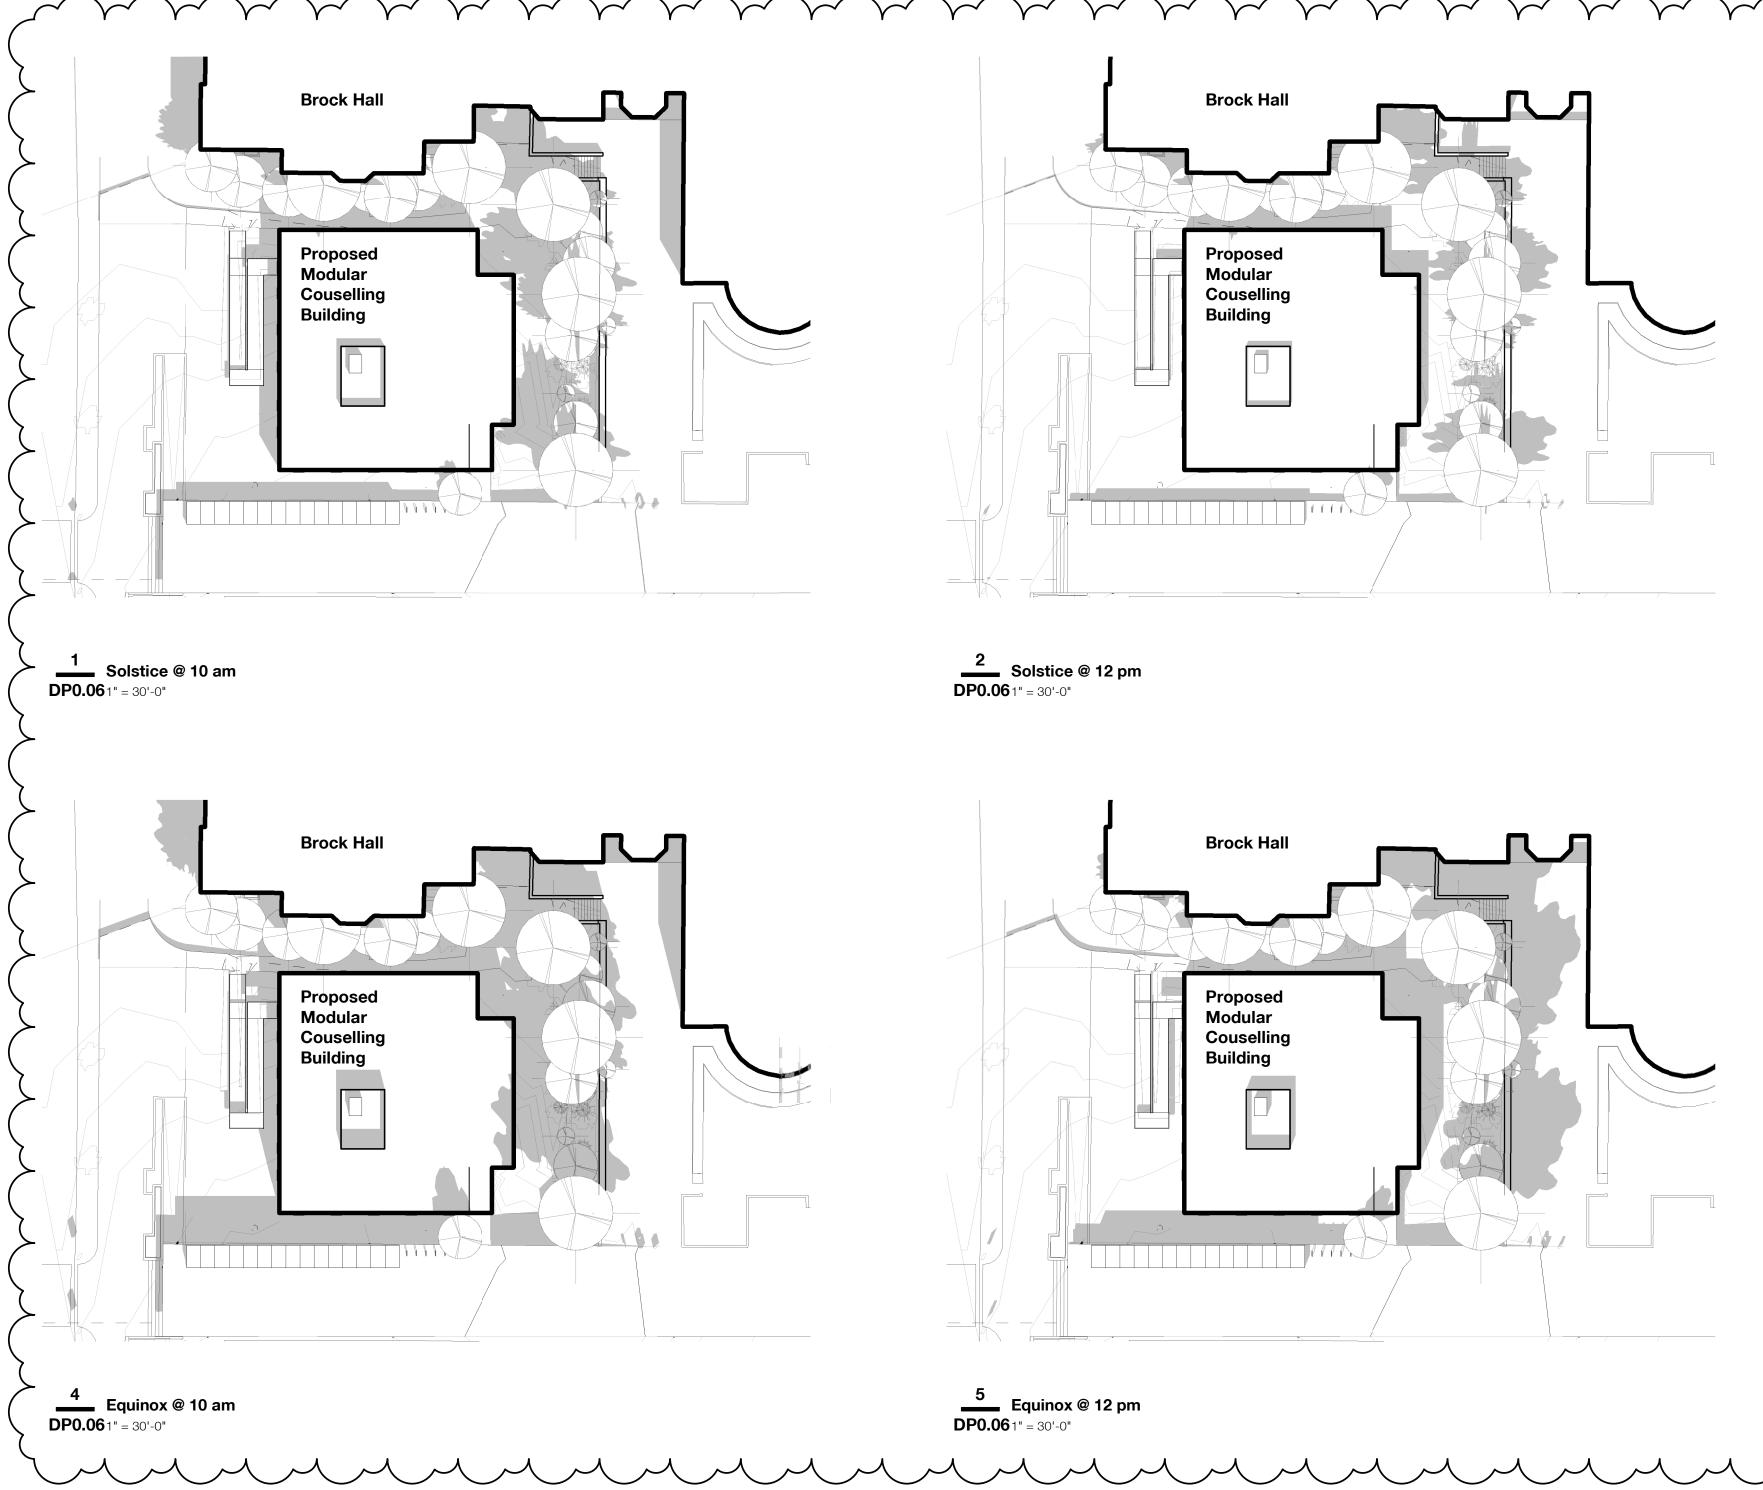


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**6** Equinox @ 2 pm DP0.061" = 30'-0"

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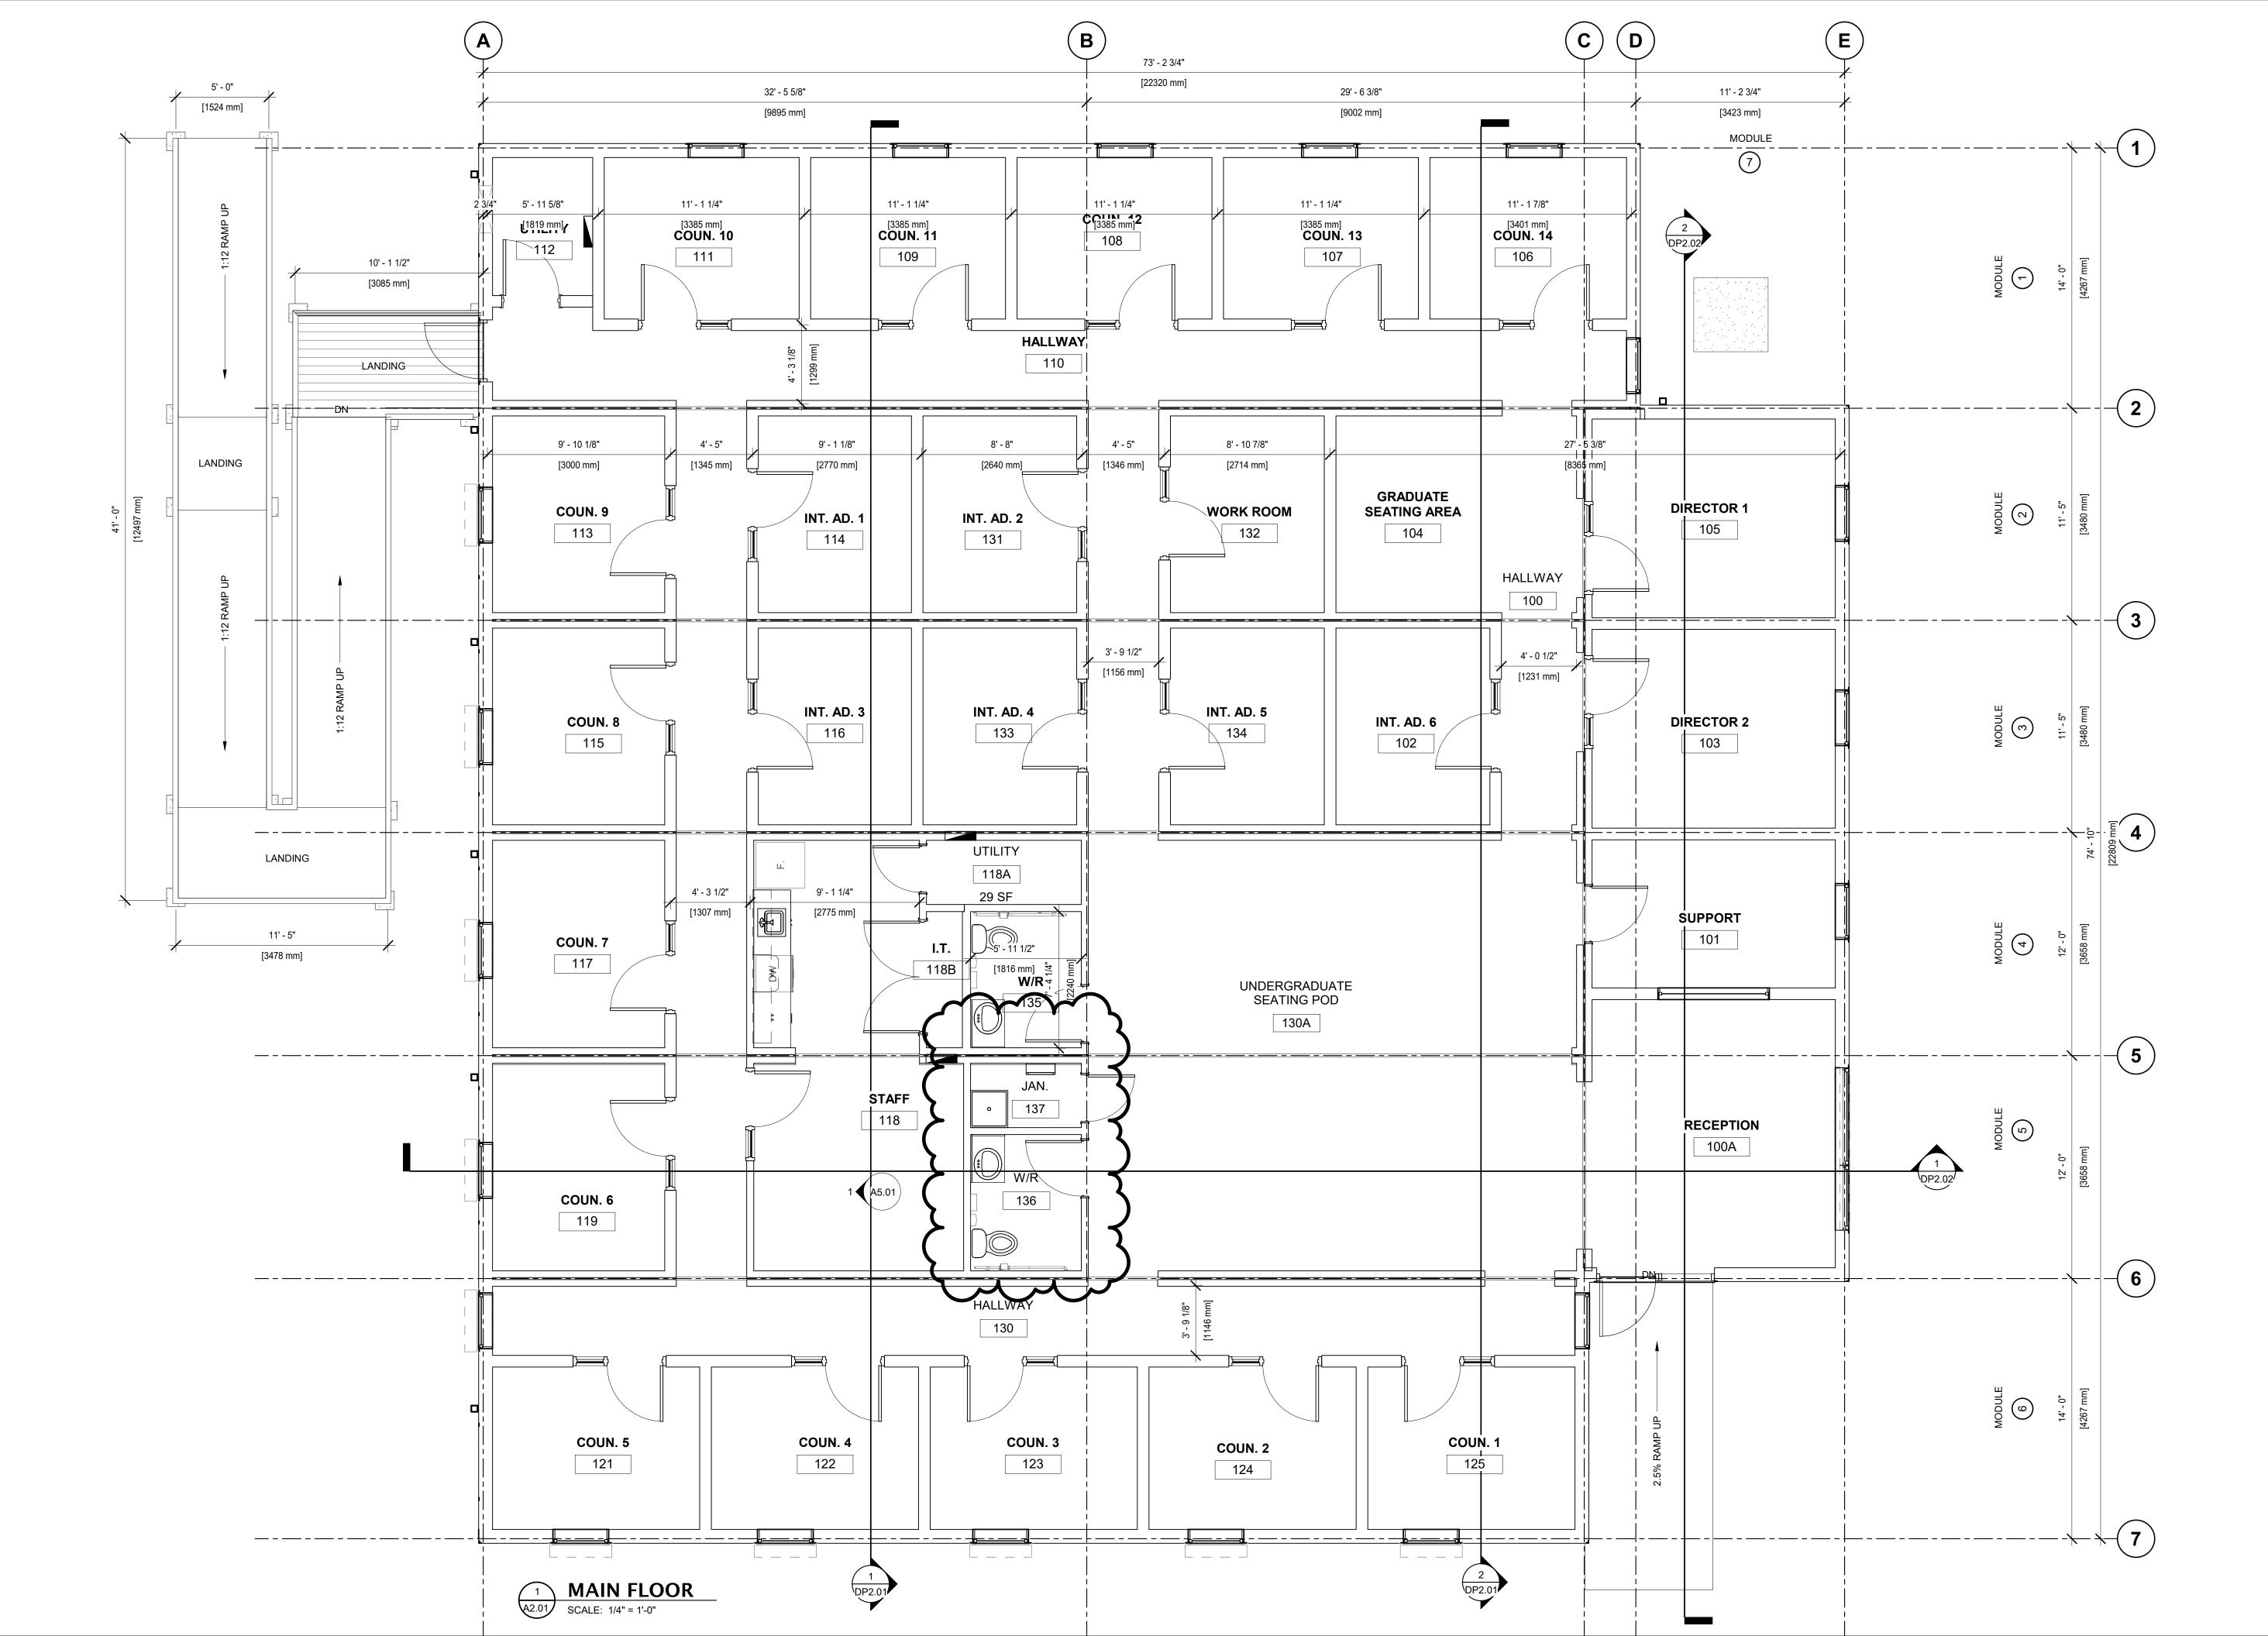
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Shadow Analysis

Drawing No.

Drawing

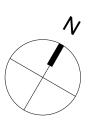




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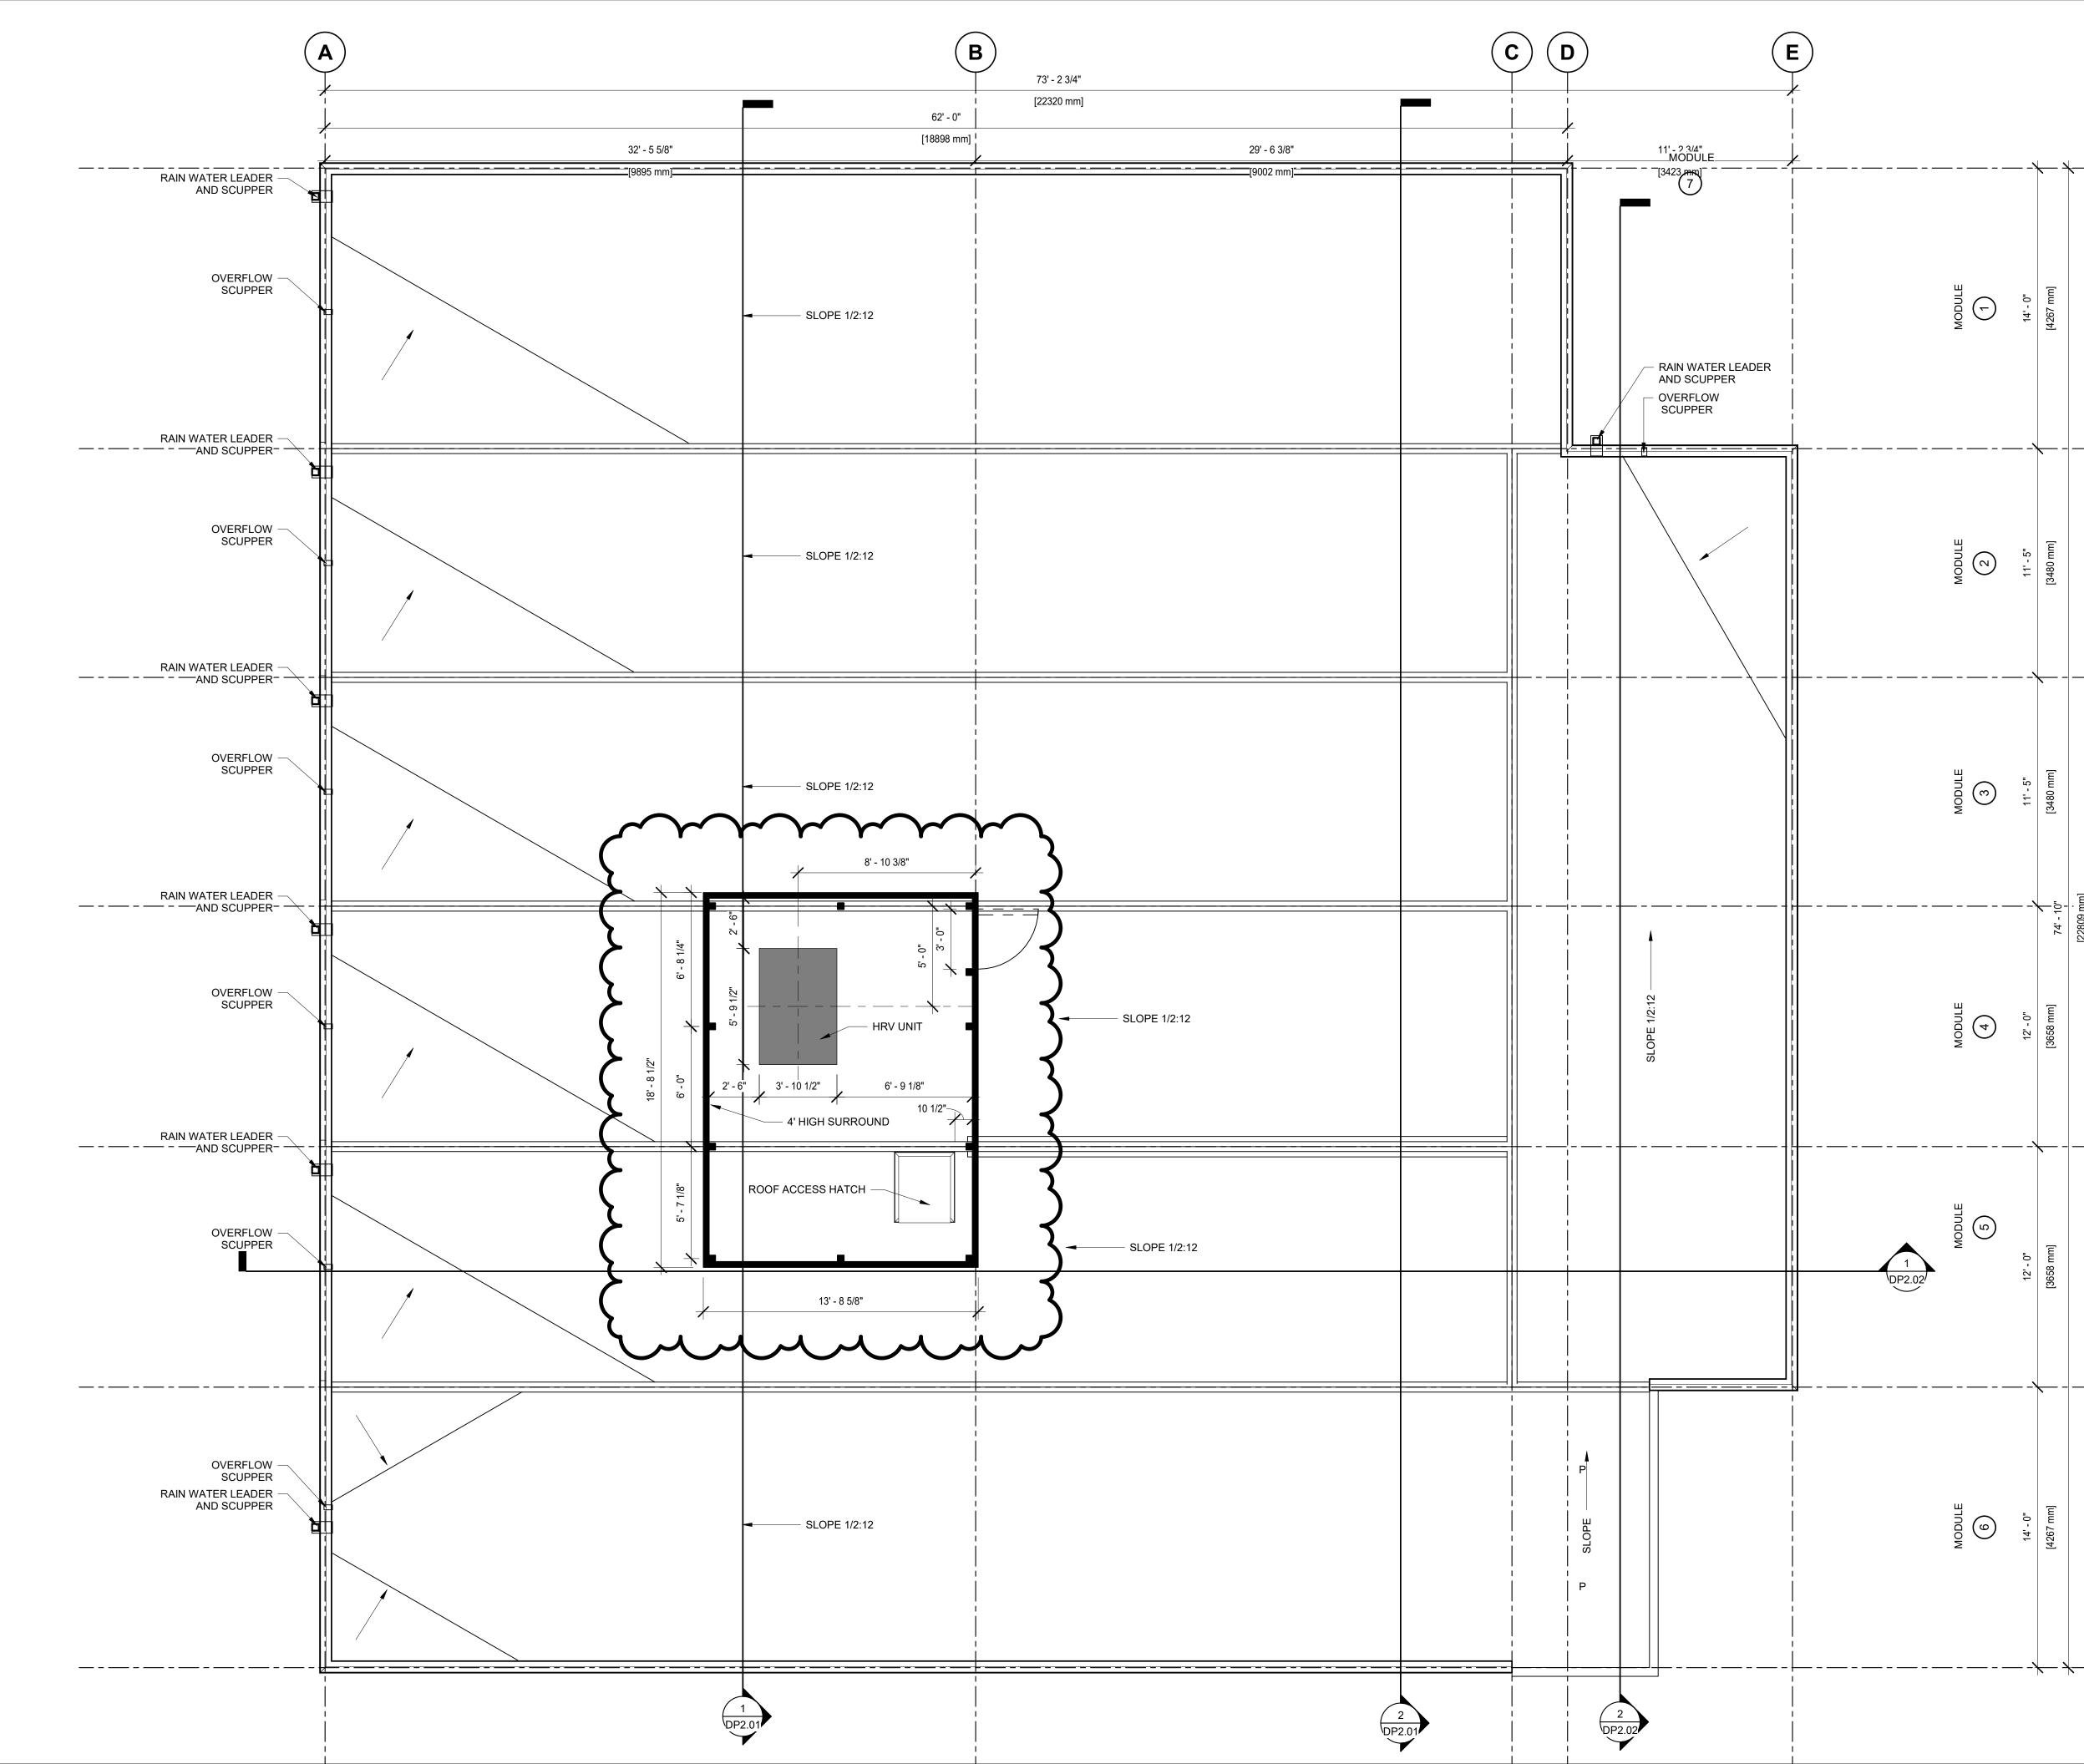
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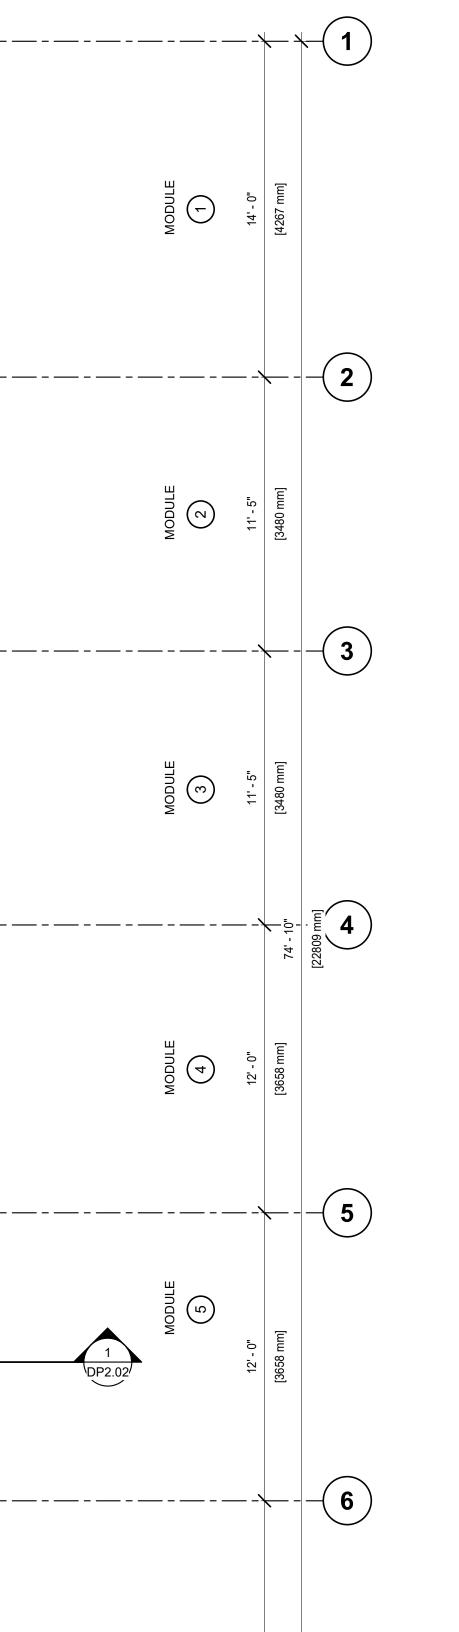
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DP1.01


<sup>Drawing</sup> Main Floor Plan



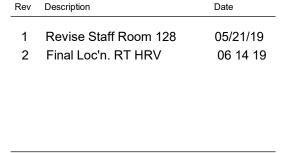

WODULE

14' - 0" !267 mm

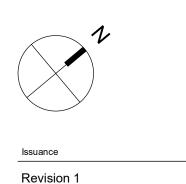

Date Date 1

Rev	Description	Date
1	Addit'n of RT HRV	05 29 19
2	Final Loc'n. RT HRV	06 14 19



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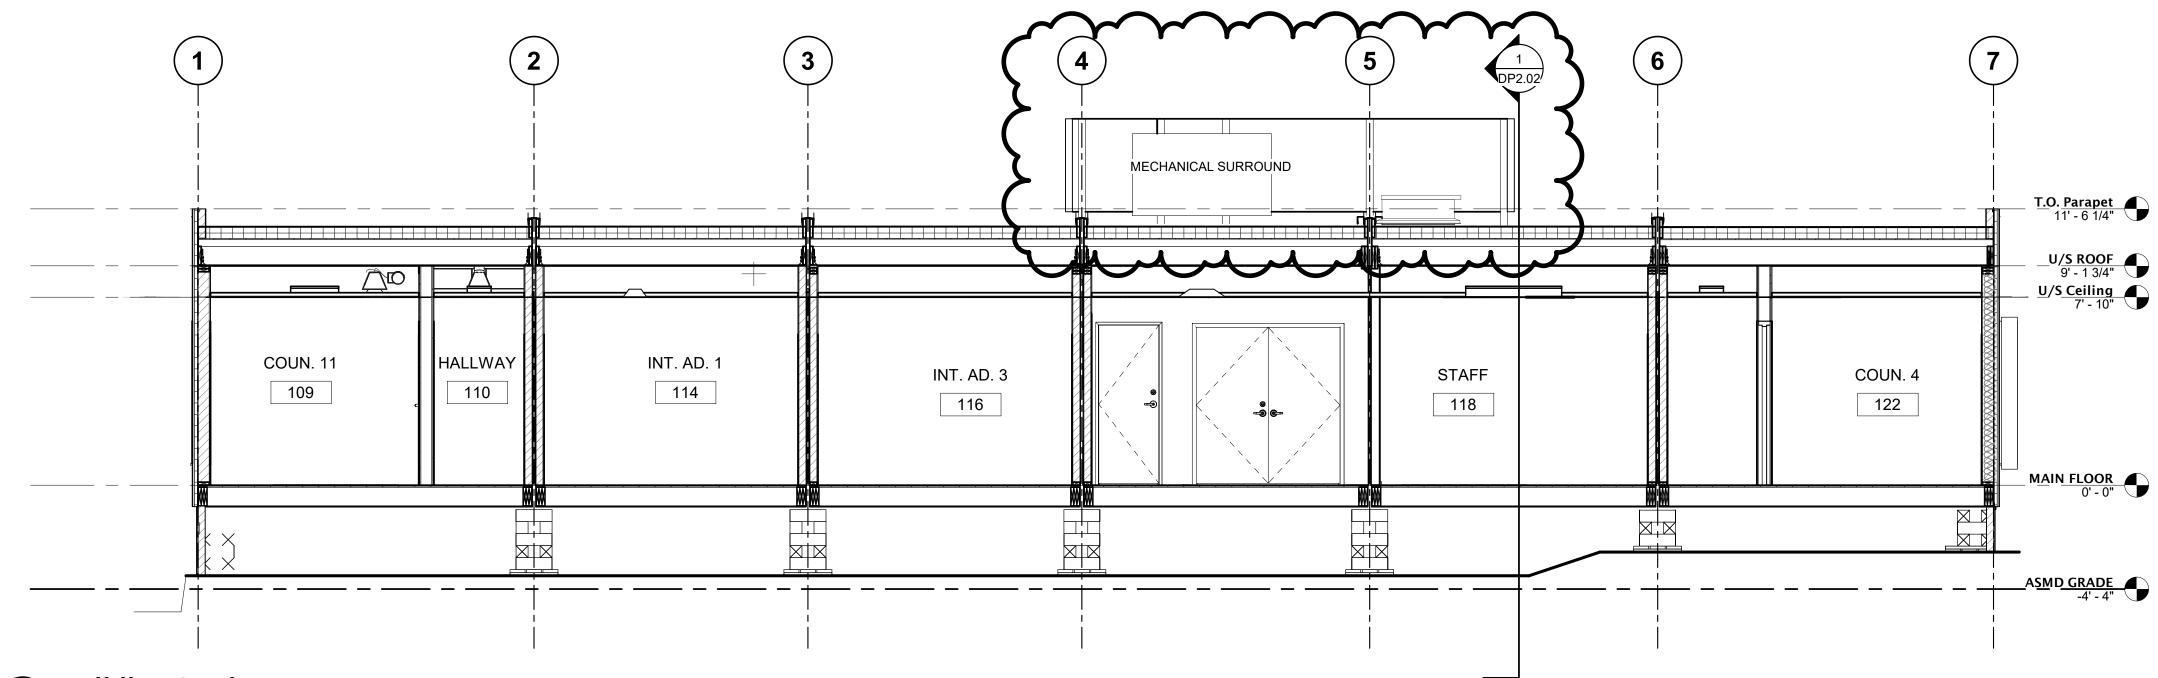
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DP1.02


Drawing Roof Plan





 1
 Building Section 1 DP

 DP1.01
 SCALE: 1/4" = 1'-0"

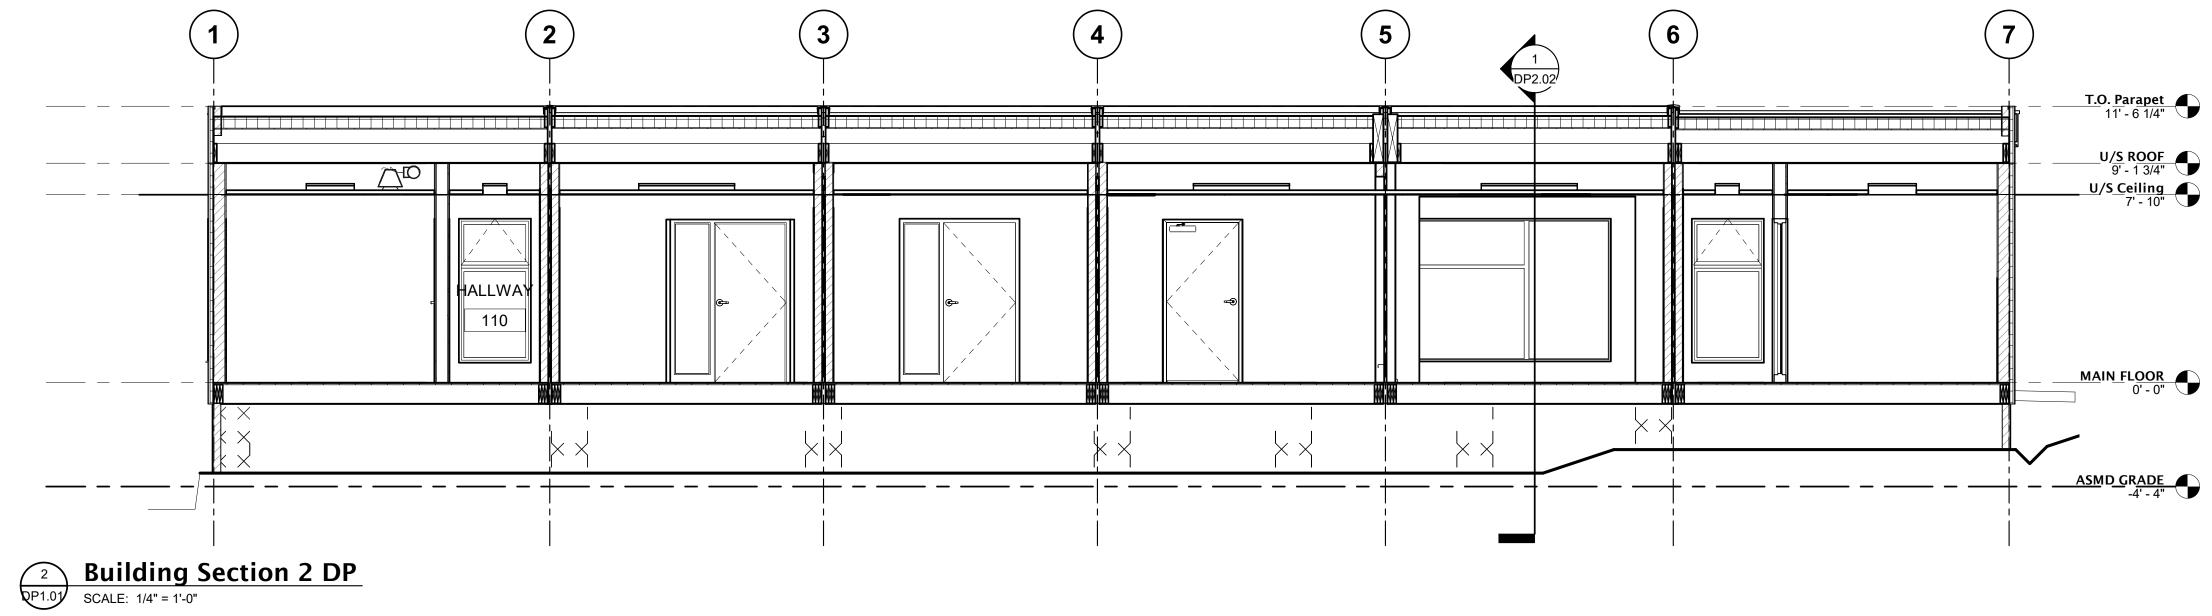

Issuance Revision 1 Date Date 1

Rev	Description	Date	
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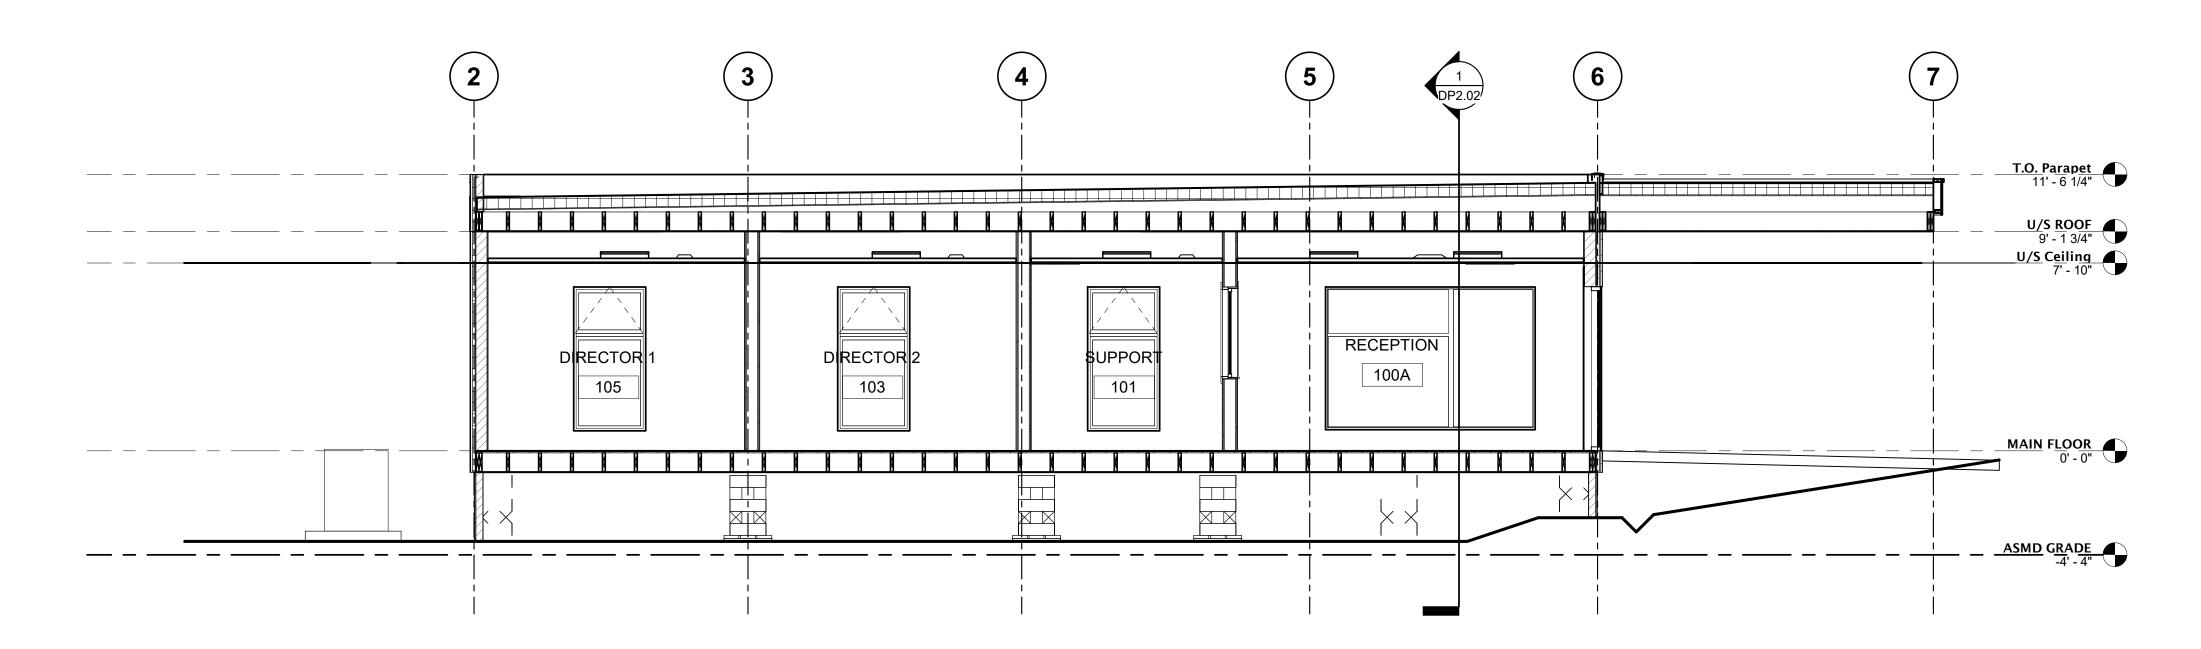
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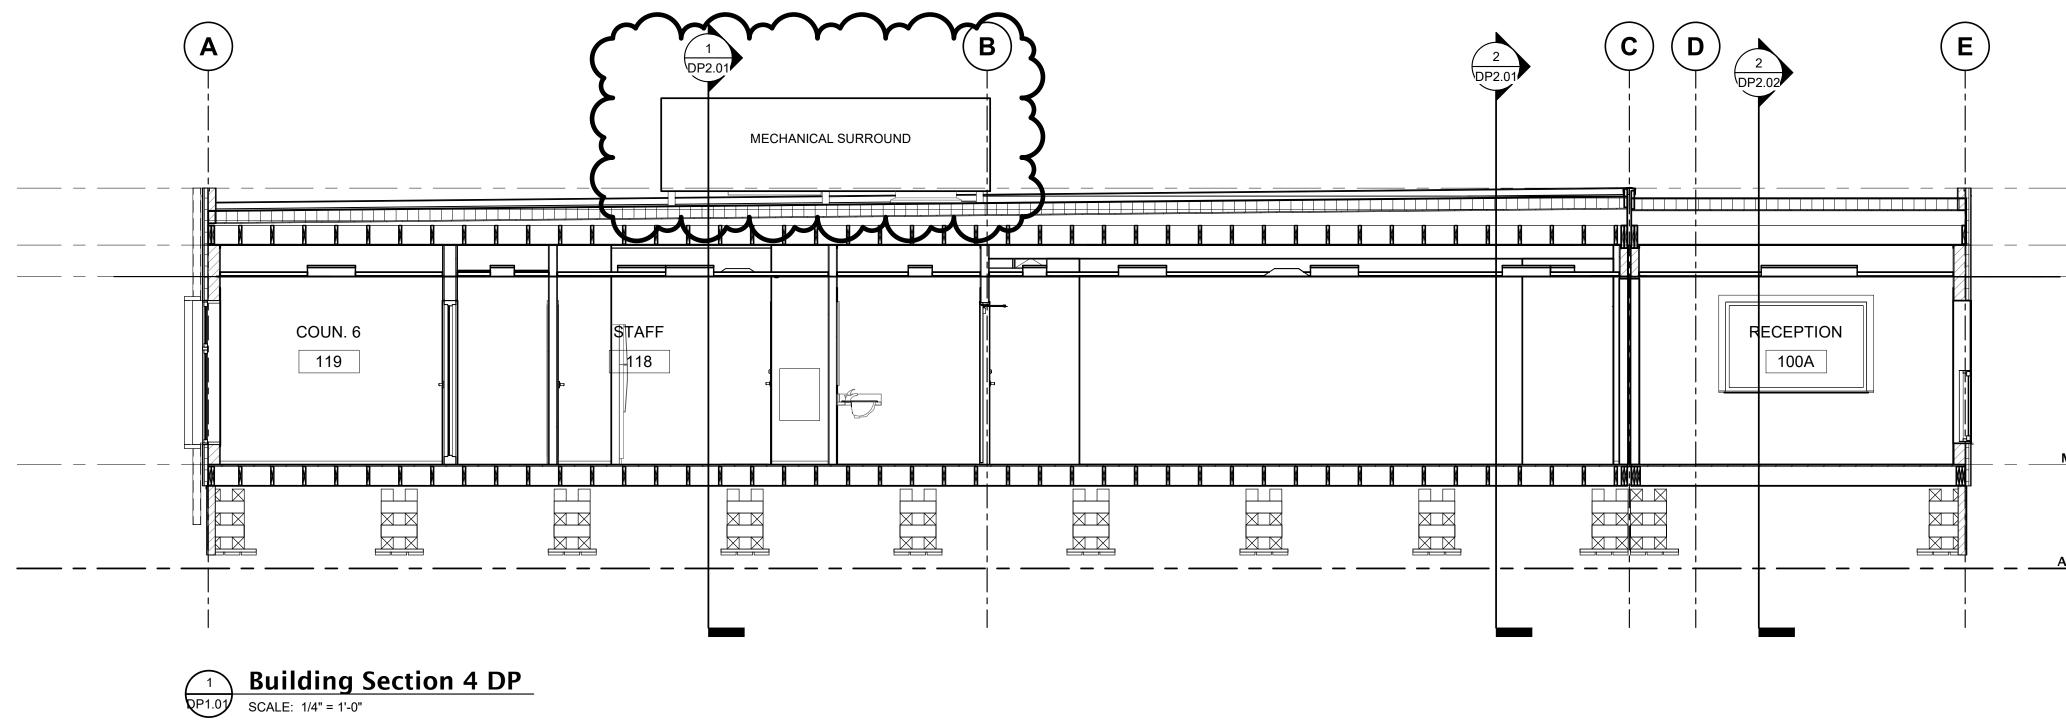
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Project ID.	Project No. 1837300-	Scale @ 22x34 1/4" = 1'-0"

Drawing
Building Sections






2 Building Section 3 DP PP1.01 SCALE: 1/4" = 1'-0"



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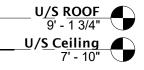
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Drawing Building Sections

Drawing No.

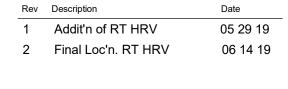


**T.O. Parapet** 11' - 6 1/4"



<u>MAIN</u> FLOOR 0' - 0"

ASMD\_GRADE -4' - 4"

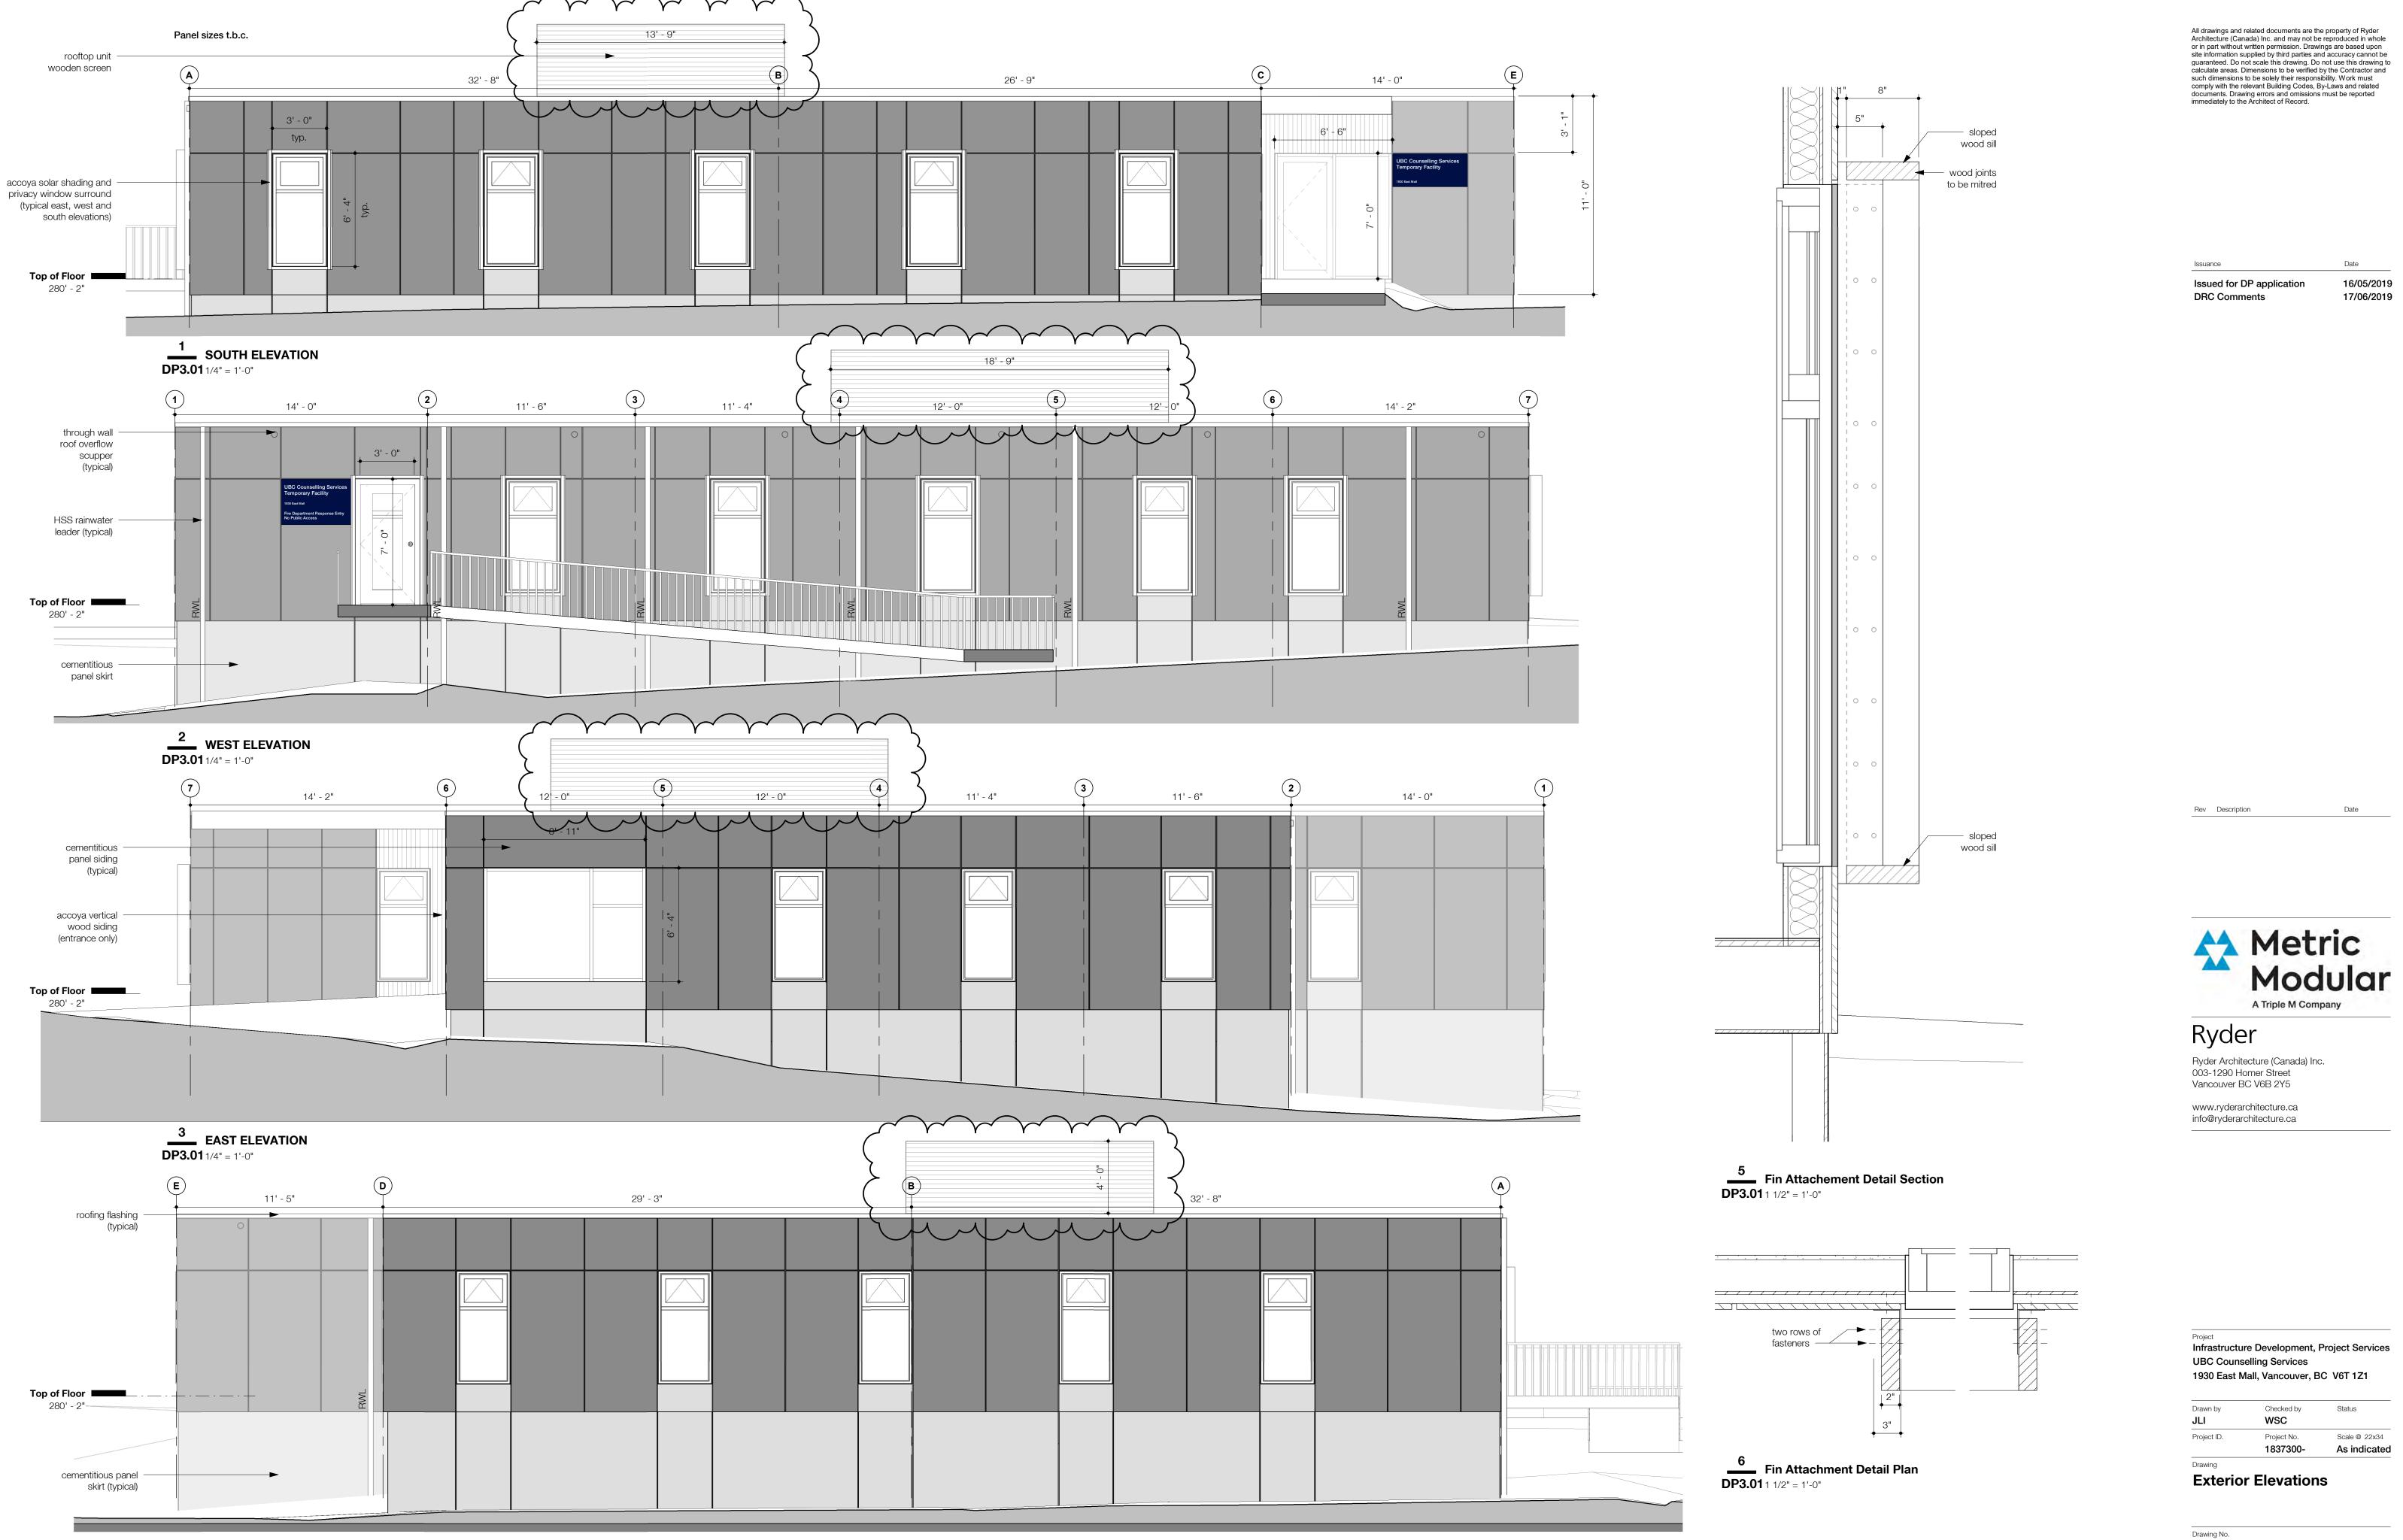



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Project ID.	Project No.	Scale @ 22x34
	1837300-	As indicated










**Exterior View - South West** 

Date Issuance Issued for DP application 16/05/2019 DRC Comments 17/06/2019

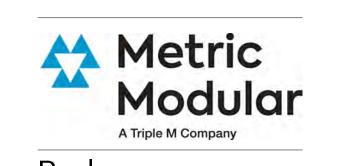

Date

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Drawing **Exterior Views** 

