

SITE DEMOLITION LEGEND

SITE AREA TO BE DEMOLISHED

SITE DEMOLITION NOTES

- 1. PLAN BASED ON SURVEY CONDUCTED BY MURRAY & ASSOCIATES, SURREY, BC AND SUPPLIED BY
- 2. ALL EXISTING HARDSCAPE AND SOFTSCAPE WITHIN PROJECT BOUNDARY TO BE DEMOLISHED. 3. REMOVE AND STOCKPILE ANY EXISTING SITE FURNISHINGS WITHIN HATCHED AREAS. COORDINATE
- STORAGE WITH UBC PLANT OPERATIONS. 4. REMOVE AND RETAIN ANY MEMORIAL OR HISTORIC LANDSCAPE ITEMS, PLAQUES, BENCHES, TREES, ETC.
- 5. LOCATION OF AT-GRADE SERVICES SHOWN ON DRAWINGS ARE INDICATIVE ONLY. CONTRACTOR TO VERIFY LOCATION AND PROTECT ALL SITE SERVICES WITHIN SCOPE OF WORK PRIOR TO COMMENCEMENT OF EXCAVATION. REFER TO CIVIL FOR SUB SURFACE UTILITY LOCATIONS.
- TO CIVIL FOR UTILITY DEMOLITION AND PROTECTION MEASURES.
- REFER TO CIVIL FOR EROSION CONTROL MEASURES.
- 8. CONTRACTOR TO MAKE GOOD ANY DAMAGE DONE DURING THE CONSTRUCTION PERIOD TO EXISTING FEATURES TO BE RETAINED.
- 9. ANY BLUE PHONES IN CONFLICT WITH PROPOSED DESIGN TO BE EVALUATED FOR REMOVAL AND RELOCATION BY CLIENT IN COORDINATION WITH TELECOM PROVIDER.

TREE PROTECTION LEGEND

TREE TO BE REMOVED

TREE TO BE REMOVED (OUTSIDE SCOPE - SEE NOTE #9)

TREE TO BE RELOCATED

EXISTING TREE TO REMAIN

TREE PROTECTION FENCE

TREE REMOVAL SCHEDULE

25. 420mm, MAPLE


1. 460mm, PINE	26. 430mm, MAPLE	52. 250mm, MAPLE*
2. 460mm, PINE	27. 310mm, MAPLE	53. 210mm, MAPLE*
3. 840mm. COTTONWOOD	28. 330mm. MAPLE	54. 230mm, MAPLE
4. 810mm, COTTONWOOD	29. 460mm, MAPLE	55. 260mm, MAPLE
5. 310mm. MAPLE	30. 390mm, MAPLE	56. 280mm, MAPLE
5A. 390mm. MAPLE	31. 310mm. PINE	37. Z4UMM, MAPLE
6. 280mm. MAPLE	32. 190mm. DECIDUOUS	58. 300mm, MAPLE
7. 330mm. MAPLE	32. 190mm, DECIDUOUS 33. 220mm, PINE	59. 330mm, MAPLE
8. 270mm. MAPLE	34. 170mm. DECIDUOUS	60. 200mm, MAPLE
9 260mm MAPLE	34. 170mm, DECIDUOUS 35. 180mm, PINE 36. 210mm, PINE	61. 260mm, MAPLE
10 200mm MAPLE	36. 210mm. PINE	62. 320mm, MAPLE
11. 220mm. MAPLE	37. 210mm, MAPLE	63. 300mm, MAPLE
12 230mm MAPLE	38. 210mm, PINE	64. 110mm, BIRCH
13 210mm MAPLE	39. 460mm, PLATINUS	65. 130mm, BIRCH
14 240mm MAPLE	40. 320mm, BEECH	66. 170mm, BIRCH
	41. 230mm, OAK	
16 240mm MAPLE	42. 240mm, BEECH	68. 590mm. ALDER
17. 180mm, MAPLE		69. 200mm. DECIDUOUS
18. 190mm, MAPLE		70. 2/100-140mm,DECIDUOUS
19. 180mm, DECIDUOUS		71. 3/70-100mm, DECIDUOUS
20. 180mm, DECIDUOUS	46. 290mm, BEECH	,
21. 180mm, DECIDUOUS	47. 330mm, BEECH	72. 4/90-120mm, DECIDUOUS
· · · · · · · · · · · · · · · · · · ·		
	48. 280mm, MAPLE*	
	49. 240mm, MAPLE*	
24. 430mm, MAPLE	50. 220mm, MAPLE*	

TREE PROTECTION NOTES (TREES TO BE PROTECTED OR RELOCATED TBD IN COORDINATION WITH CLIENT)

51. 260mm, MAPLE*

- 1. ARBORIST REPORT PROVIDED BY DIAMOND HEAD CONSULTING LTD, FEBRUARY 3, 2016, 342 WEST 8TH AVENUE, VANCOUVER, BC V5Y 3X2 604-733-4886
- 2. NO STORAGE OF BUILDING /CONSTRUCTION MATERIALS WITHIN PROTECTED AREAS OR AGAINST
- 3. ANY PRUNING OF BRANCHES OR ROOTS MUST BE DONE BY THE PROJECT ARBORIST.
- 4. CONTRACTOR TO UNDERTAKE TREE PROTECTION MEASURES TO UNIVERSITY OF BRITISH COLUMBIA
- 5. HAND EXCAVATE ONLY WITHIN DRIPLINE OF TREES TO BE RETAINED. SEVER ROOTS CLEANLY. CONTACT PROJECT ARBORIST FOR APPROVAL PRIOR TO SEVERING ROOTS IN EXCESS OF 100mm
- 6. TREE PROTECTION FENCE IS NOT TO BE LIFTED OR REMOVED AT ANY TIME FOR VEHICULAR ACCESS. VEHICLES AND HEAVY EQUIPMENT CAN CAUSE SOIL COMPACTION IN THE ROOT ZONE
- DEPLETING THE AIR SPACE THAT IS ESSENTIAL TO THE TREE'S HEALTH.

 LOCATION OF TREE PROTECTION FENCING AND LIMIT OF ACCESS FENCING TO BE VERIFIED WITH
- CONSULTANT AND PROJECT ARBORIST PRIOR TO INSTALLATION. 8. BASED ON CONTRACTOR'S STAGING AND ACCESS REQUIREMENTS, ADDITIONAL TREE PROTECTION
- FENCING MAY BE REQUIRED. 9. TREES IDENTIFIED TO BE RELOCATED (*) REQUIRE ASSESSMENT AND COORDINATION WITH THE PROJECT ARBORIST AND CAMPUS LANDSCAPE ARCHITECT. RELOCATION TO BE DETERMINED BY

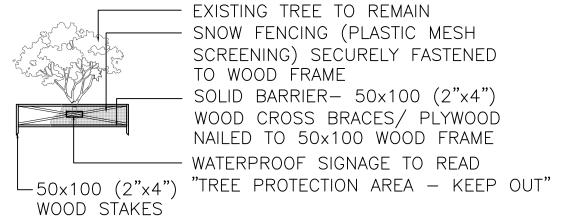

SCREENING) SECURELY FASTENED TO WOOD FRAME SOLID BARRIER- 50x100 (2"x4") WOOD CROSS BRACES/ PLYWOOD NAILED TO 50×100 WOOD FRAME

CAMPUS LANDSCAPE ARCHITECT.

-50x100 (2"x4") MIN. WOOD FRAME PER PLAN EXISTING TREE TO REMAIN

TREE PROTECTION FENCE AS APPLICABLE - SCALE: N.T.S.

DIALOG

ISSUED FOR:

2016-02-05 ISSUE FOR BID-INTERIM 2016-02-12 ISSUE FOR BID ADDENDUM R1 2016-04-20 ISSUE FOR CONSTRUCTION

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WRITTEN APPROVAL FROM THE CONSULTANT ARE SUBJECT TO CORRECTION AT THE CONTRACTOR'S EXPENSE.

UBC GAGE SOUTH

TREE MAINTENANCE AND SURFACE DEMOLITION PLAN

CHECKED: RD

L001

Memo

SLP REV. 1 to SLP REV. 2

Date: April 25, 2016 **UBC Gage South** Re:

Drawing Changes:

C4A - Utilities, Overall Site Servicing

- Water Connection and Hydrant Location Adjusted
- 2) Oil/TSS Removal Manhole Revised
- 3) Hydrant Removed

C4B - Utilities, Site Servicing

- 1) Water Connection and Hydrant Location Adjusted
- 2) Revised Hydro Conduit Adjusted per UBC and AES Comments

C4C – Utilities, Site Servicing

- Future Services and Notation Greyed Out
- Revised Hydro Conduit Adjusted per UBC and AES Comments
 Oil/TSS Removal Manhole Revised
- 3)
- Hydrant Removed

C4E – Utilities, Notes and Details

1) Revised OIL/TSS Removal Manhole Detail added

C27B - Utilities, Plan/Profile Phase 1 Storm Sewer

1) Oil/TSS Removal Manhole Revised (Plan/Profile)

C27E - Utilities, Plan/Profile Phase 1 Water

- Water Connection and Hydrant Location Adjusted
- 2) Water Service Building Entry Detail Added

H1 – Electrical Site Servicing Plan

1) Hydro Conduit, kiosks, and Chambers Updated to UBC and AES Comments

Regards,

Brian Carnahan

GAGE SOUTH EXCHANGE PHASE 1 - UNDERGROUND WORKS


VANCOUVER, BC



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DRAWING LIST
    - UTILITIES: EXISTING CONDITIONS

    ABANDON AND DEMOLITION PLAN

C4A - UTILITIES : OVERALL SITE SERVICING PLAN
     - CROSS SECTIONS : STUDENT UNION BLVD.
C9 - PAVING GEOMETRY: WESBROOK MALL
C10 - PAVING GEOMETRY: WESBROOK MALL
C11 - PAVING GRADING : WESBROOK MALL
C12 - PAVING GRADING : WESBROOK MALL
C13 - CROSS SECTIONS : WESBROOK MALL
C14 - CROSS SECTIONS : WESBROOK MALL
C15 - CROSS SECTIONS : WESBROOK MALL
C16 - PAVING GEOMETRY: INTERIM BUS LOOP - STAGE 1
C17 - PAVING GEOMETRY: INTERIM BUS LOOP - STAGE 2
C18 - PAVING GRADING: INTERIM BUS LOOP - STAGE 1
C19 - PAVING GRADING: INTERIM BUS LOOP - STAGE 2
C20 - CROSS SECTIONS : INTERIM BUS LOOP
C21 - CROSS SECTIONS : INTERIM BUS LOOP
C22 - PAVING GEOMETRY & GRADING : UNIVERSITY BLVD.
C23 - STRIPING & SIGNAGE: STUDENT UNION BLVD.
C24 - STRIPING & SIGNAGE : WESBROOK MALL
C25 - STRIPING & SIGNAGE: WESBROOK MALL
C26 - STRIPING & SIGNAGE: INTERIM BUS LOOP & UNIVERSITY BLVD.
C27A - UTILITIES : PLAN/PROFILE - STORM SEWER
C27B - UTILITIES : PLAN/PROFILE - STORM SEWER
C27C - UTILITIES : PLAN/PROFILE - STORM SEWER
C27D - UTILITIES : PLAN/PROFILE - SANITARY SEWER
C27E - UTILITIES : PLAN/PROFILE - WATER WORKS
H1 – ELECTRICAL SITE SERVICING PLAN
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1 / 2016-03-30 / SLP SUBMISSION 2 / 2016-04-26 / SLP - PHASE 1_UNDERGROUND
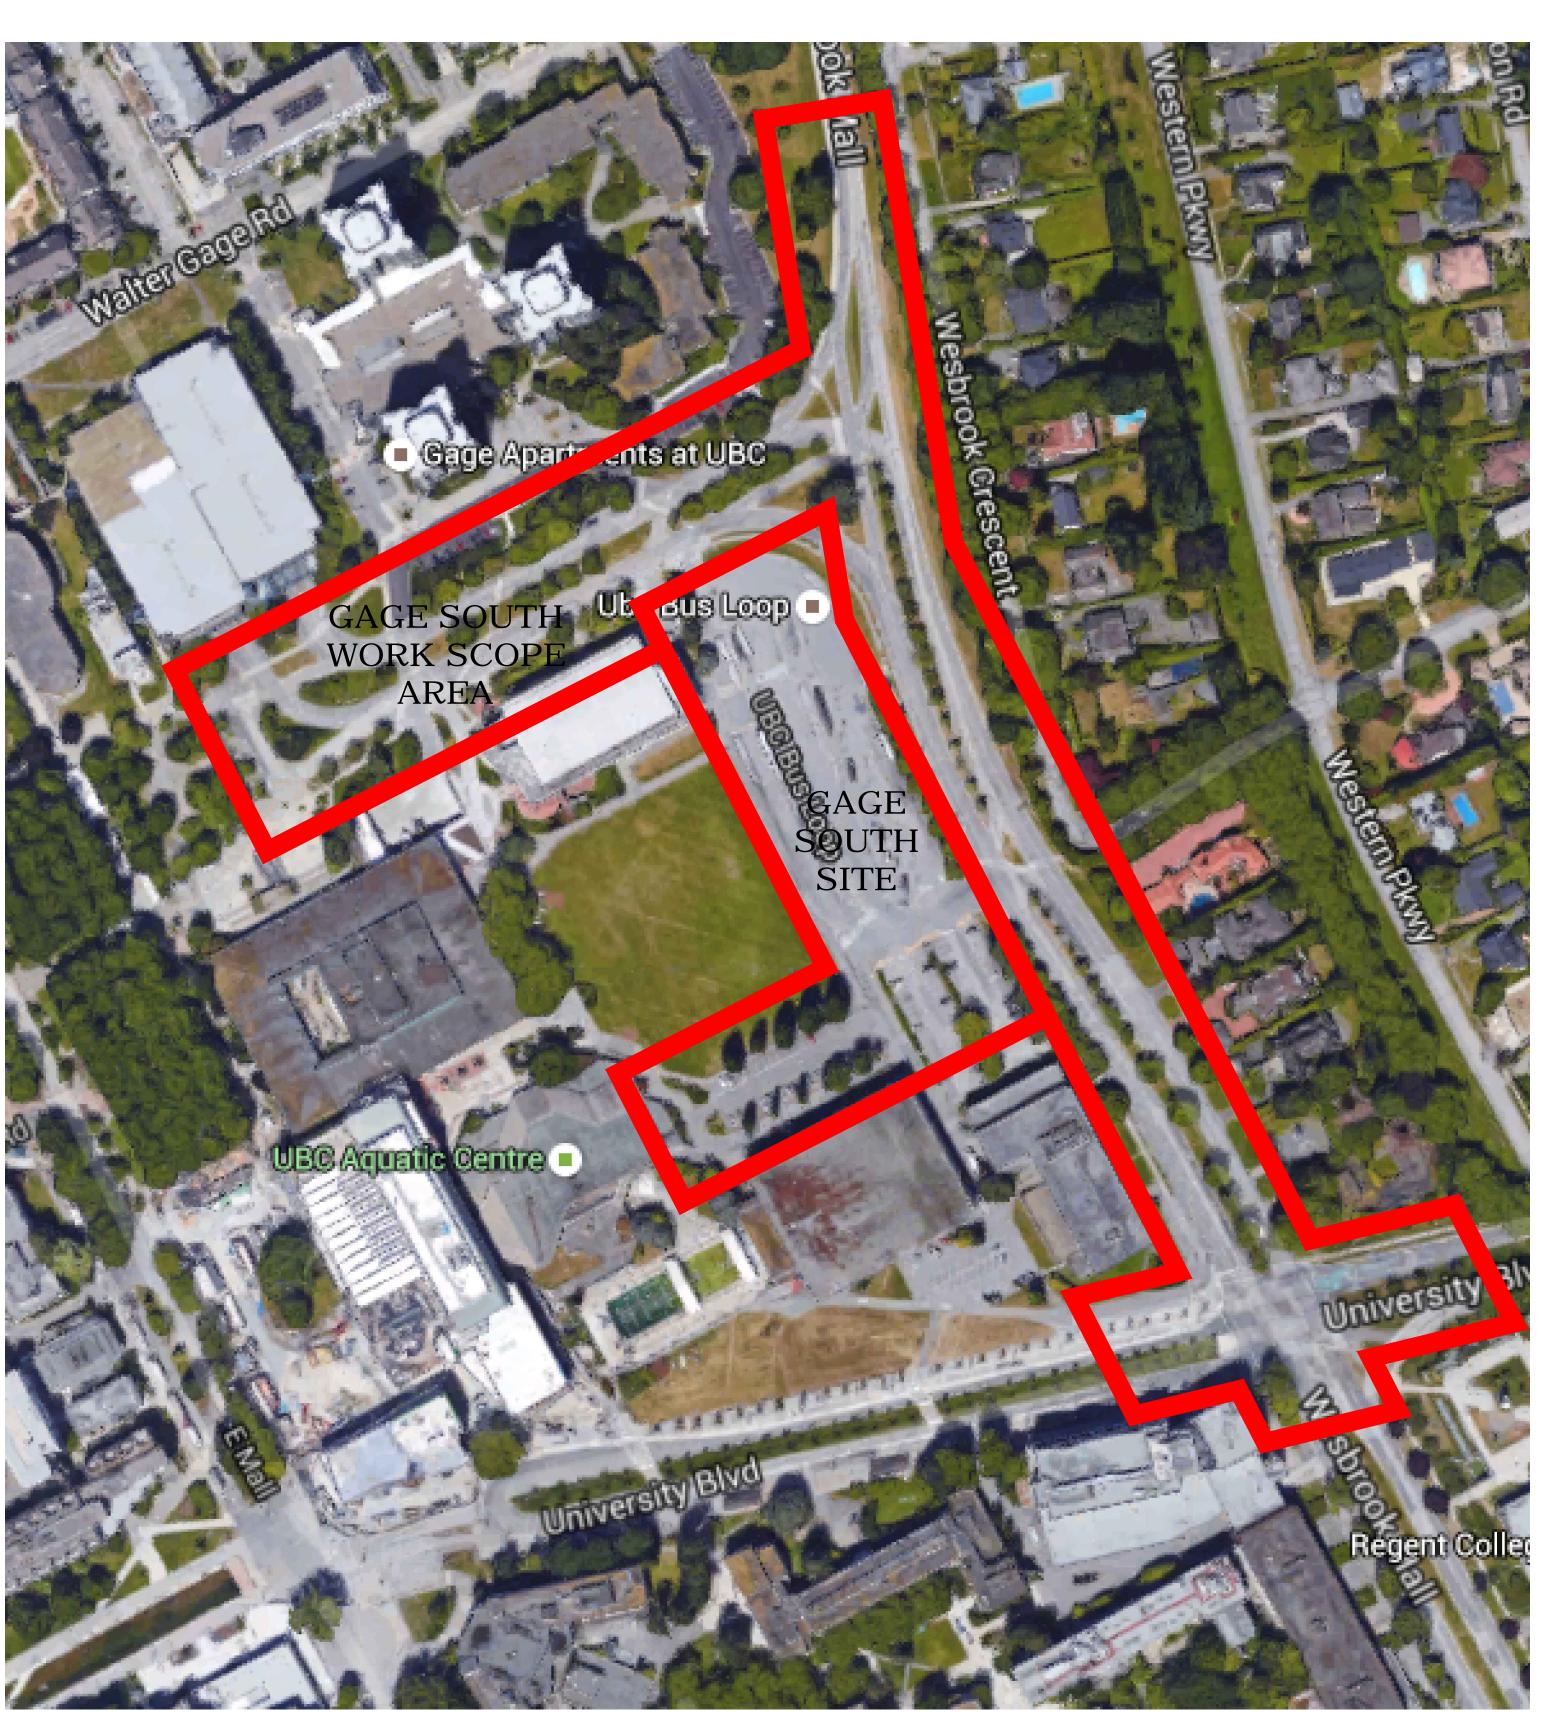
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GRAPHIC SCALE


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UBC Gage South

PHASE 1 **UNDERGROUND WORKS**

Civil Design **GAGE SOUTH COVER SHEET**

CHECKED: CN



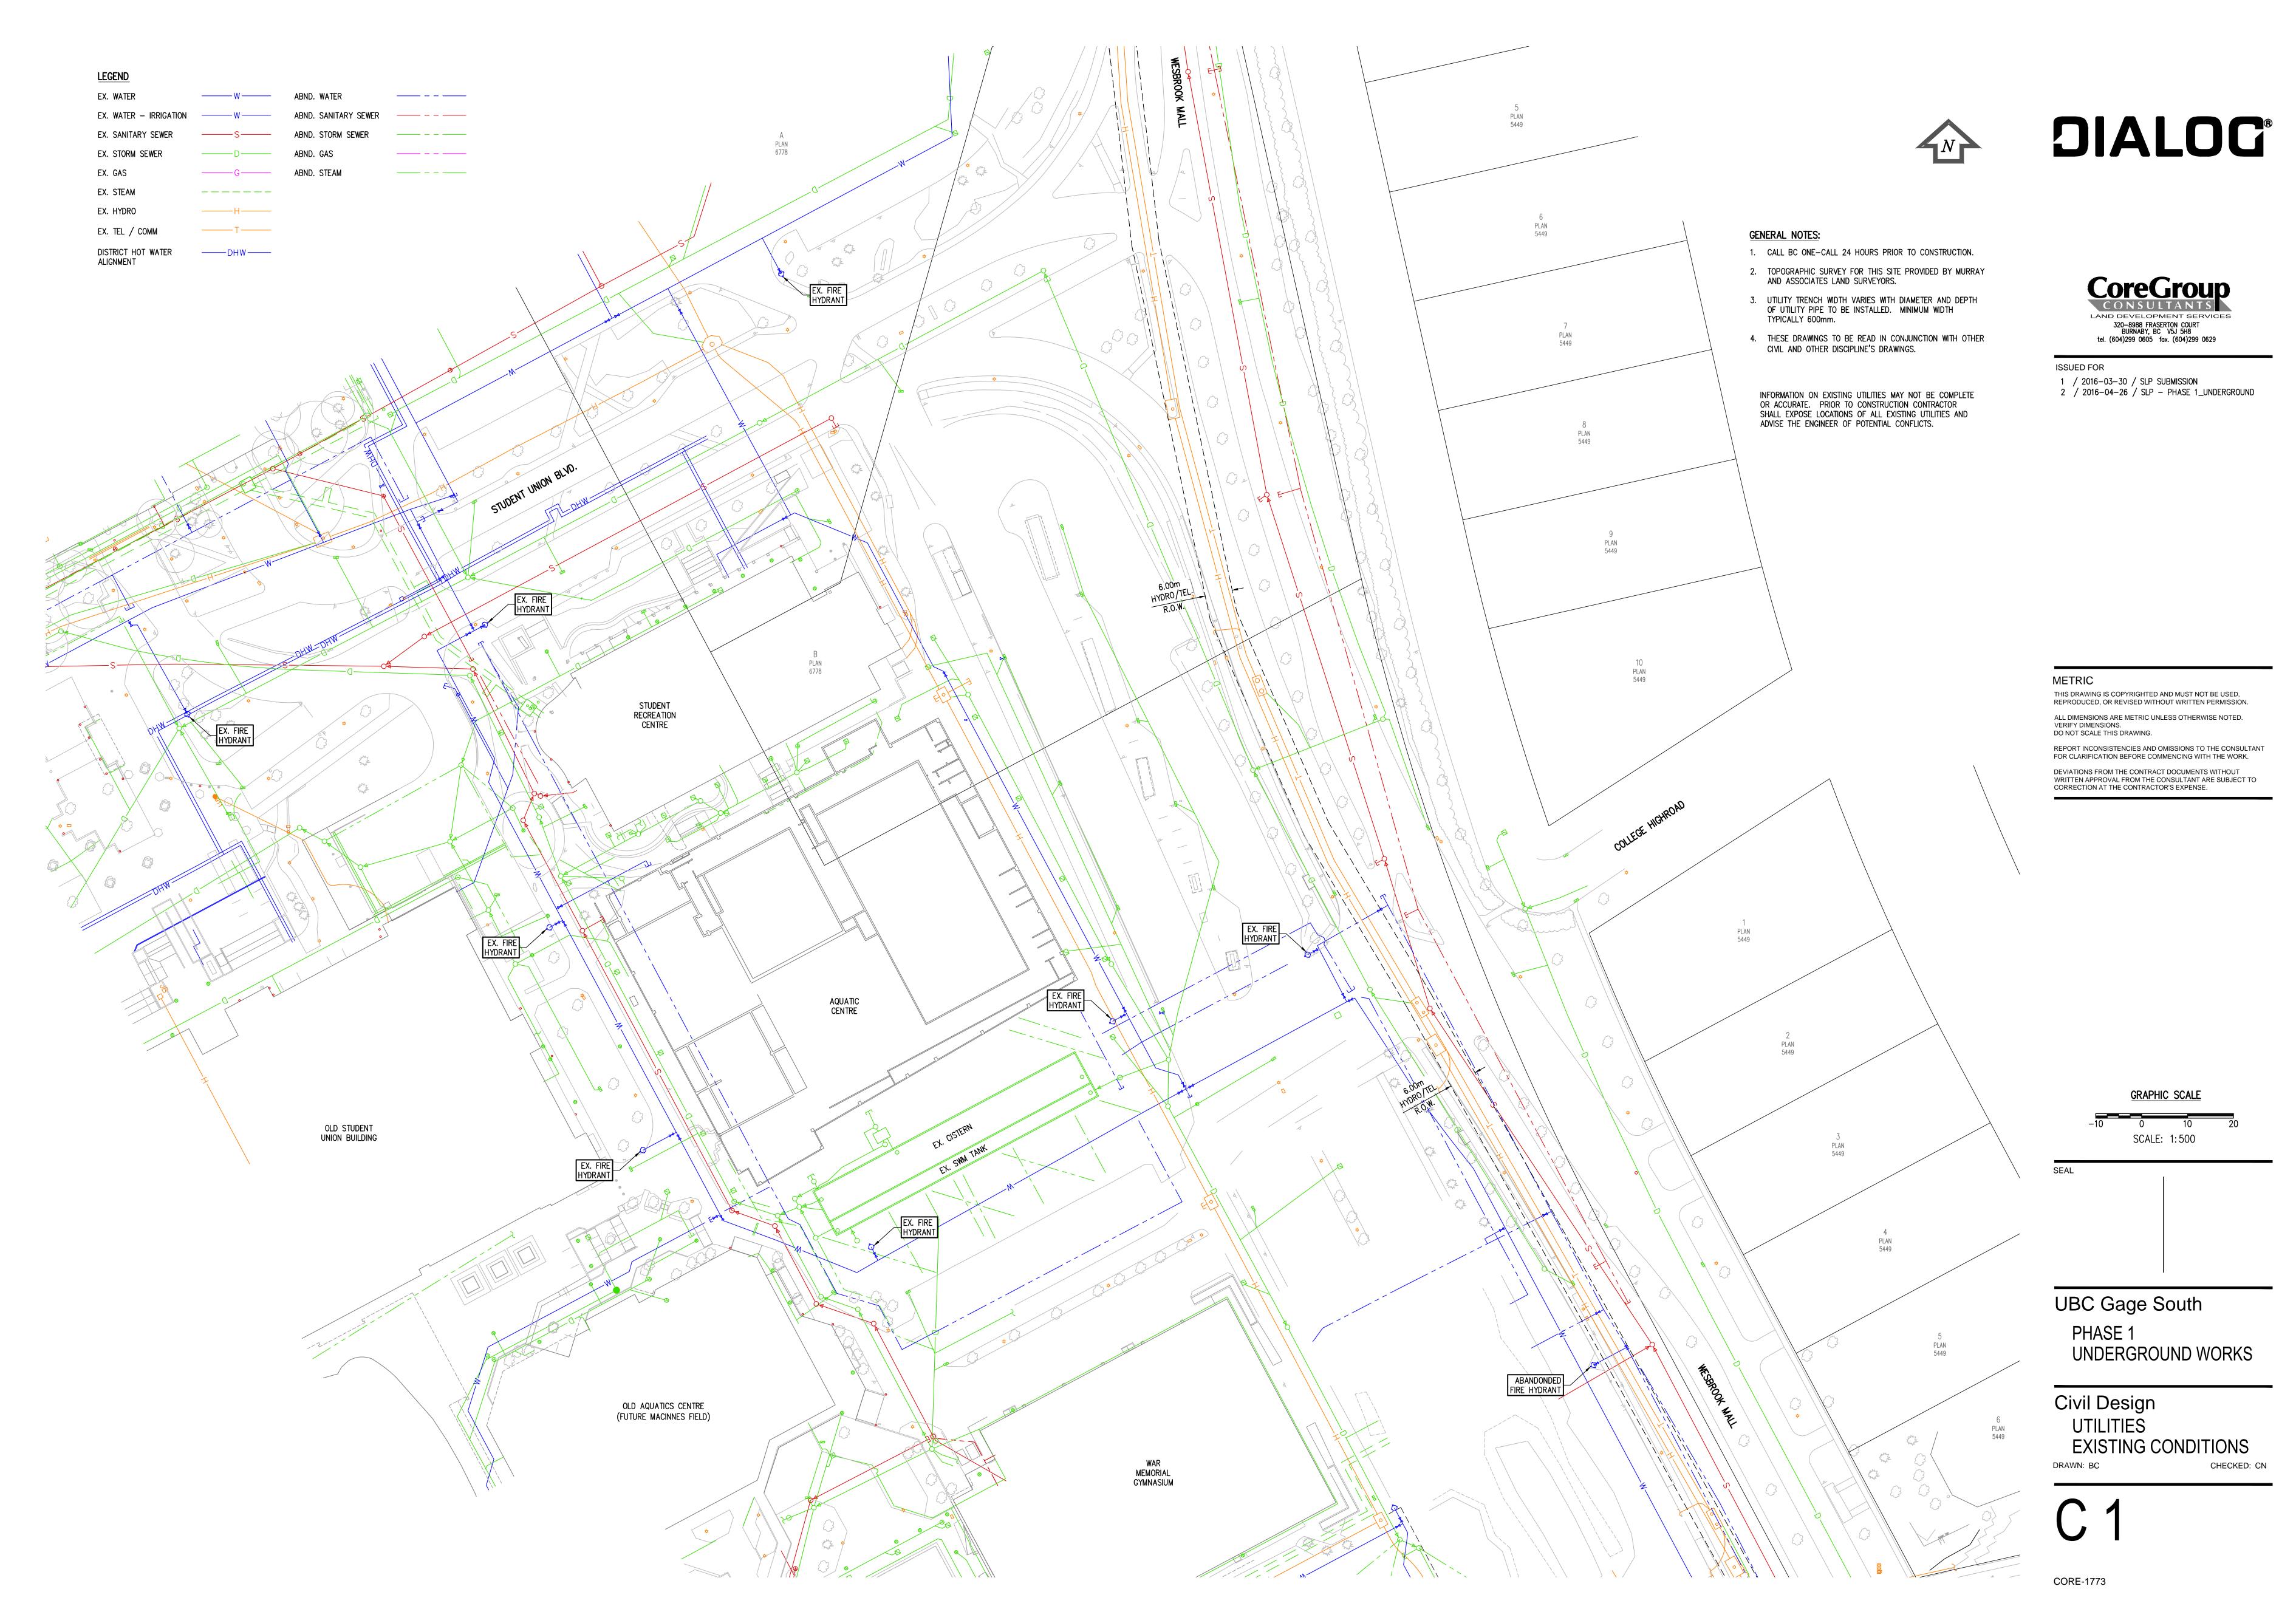



LAND DEVELOPMENT SERVICES 320-8988 FRASERTON COURT BURNABY, BC V5J 5H8 tel. (604)299 0605 fax. (604)299 0629

1 / 2016-03-30 / SLP SUBMISSION 2 / 2016-04-26 / SLP - PHASE 1_UNDERGROUND

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GRAPHIC SCALE SCALE: 1:500

UBC Gage South

PHASE 1 UNDERGROUND WORKS


Civil Design ABANDON AND **DEMOLITION PLAN**

DRAWN: BC


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TESTING:


- 1. ALL TESTING TO BE PERFORMED BY A CSA OR CCIL (CANADIAN CERTIFIED TESTING LABORATORIES) CERTIFIED LABORATORY.
- 2. FREQUENCY OF DENSITY TESTS FOR EXCAVATING, TRENCHING AND BACKFILLING SHALL BE ONE TEST PER 50 LINEAL METRES OR TRENCH PER METRE OF DEPTH. MATERIAL TO BE COMPACTED IN 300mm LIFTS.
- 3. FREQUENCY OF DENSITY TESTS FOR ROADWAY EXCAVATION, EMBANKMENT (SUB-GRADE FILL) AND COMPACTION SHALL BE ONE TEST PER 250m2 PER 300mm LIFT.
- 4. FREQUENCY OF DENSITY TESTS FOR GRANULAR BASE AND SUB-BASE SHALL BE ONE TEST PER 30 LINEAL METRES OF LANE WIDTH STAGGERED EACH SIDE OF CENTRELINE PER 150mm LIFT OR OF SPECIFIED THICKNESS.
- 5. FREQUENCY OF DENSITY TESTS FOR SIDEWALK BASE SHALL BE ONE TEST PER 30 LINEAL METRES WITHIN SIDEWALK AND DRIVEWAY AREA.
- 6. FREQUENCY OF DENSITY TESTS FOR CURB BASE SHALL BE ONE TEST PER 100 LINEAL METRES.
- 7. FREQUENCY OF MARSHALL TESTS FOR HOT-MIX ASPHALT CONCRETE PAVING SHALL BE ONE TEST PER 500 TONNES OF MIX PLACED OR ONE TEST FOR EACH TYPE OF ASPHALT MIX, MINIMUM ONE PER DAY.
- 8. FOR PAVING, CORE LOCATIONS WILL BE SELECTED FOR EACH PASS OF THE PAVING MACHINE AS FOLLOWS:
- 8.1. ACROSS THE WIDTH, CORE LOCATIONS WILL BE SELECTED RANDOMLY FROM ONE-SIXTH INCREMENTS.
- 8.2. ALONG THE LENGTH, CORE LOCATIONS WILL HAVE A RANDOMLY SELECTED START
- WITH CORES AT A SPACING OF APPROXIMATELY, BUT NOT TO EXCEED 30 METRES. 8.3. FOR OTHER PAVING OPERATIONS, A MINIMUM OF ONE CORE FOR EVERY 250 SQUARE METRES OF ASPHALT MIX PLACED.
- 9. FREQUENCY OF PLASTIC CONCRETE TESTS FOR SIDEWALK SHALL BE ONE TEST PER 150 LINEAL METRES OR A MINIMUM OF ONE PER DAY.
- 10. FREQUENCY OF PLASTIC CONCRETE TESTS FOR CURB AND GUTTER SHALL BE ONE TEST PER 300 LINEAR METRES OF A MINIMUM OF ONE PER DAY.
- 11. PRESSURE AND BACTERIOLOGICAL TESTING TO BE DONE BY CONTRACTOR PRIOR TO TIE-IN AND ACCEPTANCE BY UBC UTILITIES. ASSUMED TEST PRESSURE OF 1380 kPa (200 psi). THE CONTRACTOR SHALL TEST ALL WATERMAINS: PRESSURE TEST TO B.C. BUILDING CODE (2012) AND SHALL CHLORINATE AND FLUSH TO MINISTRY OF HEALTH AND AWWA STANDARDS. ALL TESTING IS TO BE WITNESSED BY THE ENGINEER AND THE UBC INSPECTOR. TESTING TO BE APPROVED BY UBC PRIOR TO TIE-IN TO MUNICIPAL WATER SYSTEM. ALL STORM AND SANITARY SYSTEMS TO BE TESTED PER SECTION 3.6 OF THE B.C. PLUMBING CODE. THE ENGINEER IS TO BE NOTIFIED 48 HOURS PRIOR TO
- 12. STORM SEWERS SHALL BE VIDEO INSPECTED PER MMCD SPECIFICATIONS SECTION 02731.
- 13. SANITARY SEWERS SHALL BE PRESSURE TESTED AND VIDEO INSPECTED PER MMCD SPECIFICATIONS.
- 14. EXISTING SANITARY AND STORM SERVICE STUBS ARE TO BE CCTV INSPECTED AFTER SHORING. SUBMIT THE CCTV INSPECTION REPORTS AND VIDEOS TO UTILITIES TO ENSURE NO CONSTRUCTION DAMAGE ON EXISTING SERVICE STUBS.
- 15. ALL TESTING TO BE DONE AND APPROVED BEFORE BACKFILLING PIPE.

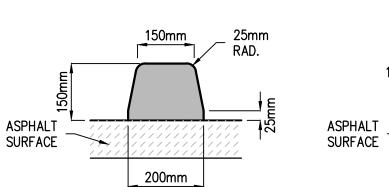

TEMP. 150mm ASPHALT CURB

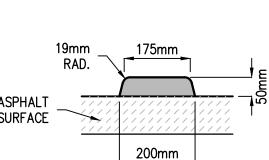

TEMP. 50mm ASPHALT CURB

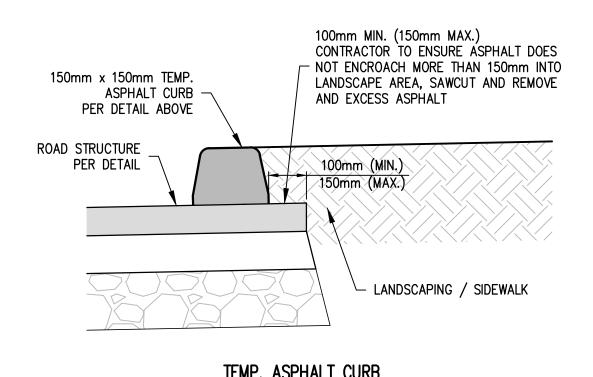


GENERAL NOTES:


- 1. CALL BC ONE-CALL 24 HOURS PRIOR TO CONSTRUCTION.
- 2. TOPOGRAPHIC SURVEY FOR THIS SITE PROVIDED BY MURRAY AND ASSOCIATES LAND SURVEYORS.
- 3. UTILITY TRENCH WIDTH VARIES WITH DIAMETER AND DEPTH OF UTILITY PIPE TO BE INSTALLED. MINIMUM WIDTH TYPICALLY 600mm OR AS PER MMCD STD. DET. G4.
- 4. THESE DRAWINGS TO BE READ IN CONJUNCTION WITH OTHER CIVIL AND OTHER DISCIPLINE'S DRAWINGS.
- 5. ALL EX. VALVES AND MANHOLES TO BE ADJUSTED TO SUIT NEW GRADES. ADJUSTED EX. WATER VALVES TO BE REPLACED WITH SQUARE ROBAR VALVE BOXES SUPPLIED BY DOBNEY OR APPROVED EQUIVALENT, VALVE # TO BE MARKED WITH GREASE PEN.
- 6. COORDINATE ALL EXCAVATIONS CLOSE TO BUILDIING WITH SHORING PLANS BY GEOTECH.
- 7. ALL EXISTING UTILITIES TO BE ABANDONED ARE TO BE CAPPED AT BOTH ENDS UNLESS REMOVED ENTIRELY.

STORM & SANITARY SEWER NOTES:

TO MMCD CLAUSE 2.3, SECTION 02226.

- 1. ALL WORKS TO BE CARRIED OUT IN ACCORDANCE WITH CURRENT UBC AND MMCD SPECIFICATIONS.
- 2. PIPE BEDDING SHALL BE GRANULAR PIPE BEDDING AND SURROUND
- MATERIAL CONFORMING TO MMCD CLAUSE 2.7, SECTION 02226. 3. PIPE BACKFILL SHALL BE 100mm PIT RUN GRAVEL MATERIAL CONFORMING
- 4. ALL PIPES UP TO AND INCLUDING 525mmø PVC PIPE TO UBC SPECIFICATIONS AS FOLLOWS (UNLESS OTHERWISE NOTED) - 150mmø & SMALLER SDR28 200mmø TO 525mmø SDR35 TO ASTM 03034 SPECS.
- 5. ALL PIPES SHALL HAVE CLOSED JOINTS
- 6. PIPE TO BE INSTALLED PER MANUFACTURER'S RECOMMENDATIONS FOR PIPE DEPTH AND SLOPE PER SOIL CONDITIONS.
- 7. ALL SANITARY AND STORM SEWER MANHOLES TO BE 1050mmø WITH MARKINGS PER UBC REQUIREMENTS UNLESS OTHERWISE NOTED.
- 8. ALL CATCH BASIN LEADS SHALL HAVE A MINIMUM OF 1.0% GRADE.
- 9. ALL STORM MANHOLES TO BE BENCHED UNLESS NOTED OTHERWISE.
- 10. CONTRACTOR TO CONFIRM ANY FOUNDATION STABILIZATION REQUIREMENTS OF EXISTING STRUCTURES IN TRENCHING AREA WITH GEOTECHNICAL
- 11. EXISTING SANITARY AND STORM SERVICE STUBS ARE TO BE CCTV INSPECTED AFTER SHORING. SUBMIT THE CCTV INSPECTION REPORTS AND VIDEOS TO UTILITIES TO ENSURE NO CONSTRUCTION DAMAGE ON EXISTING SERVICE STUBS.

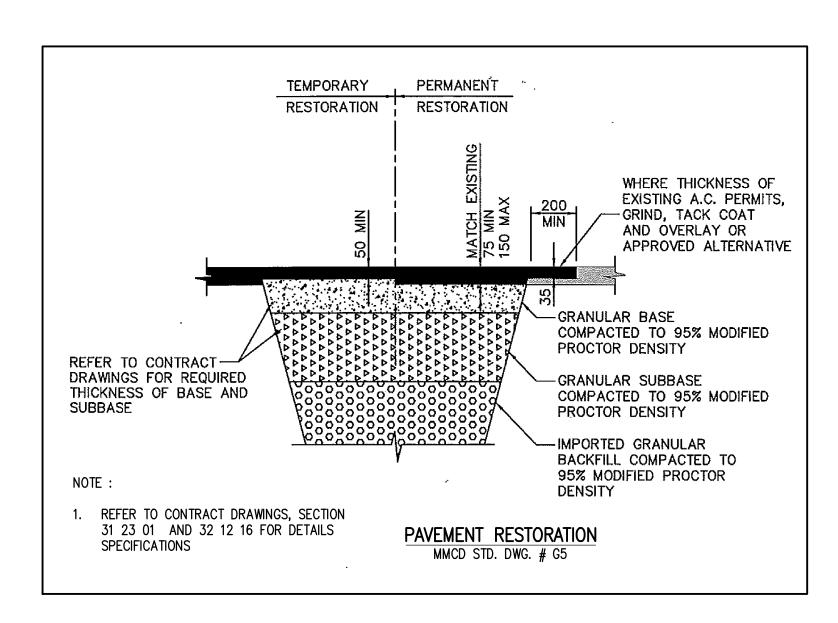

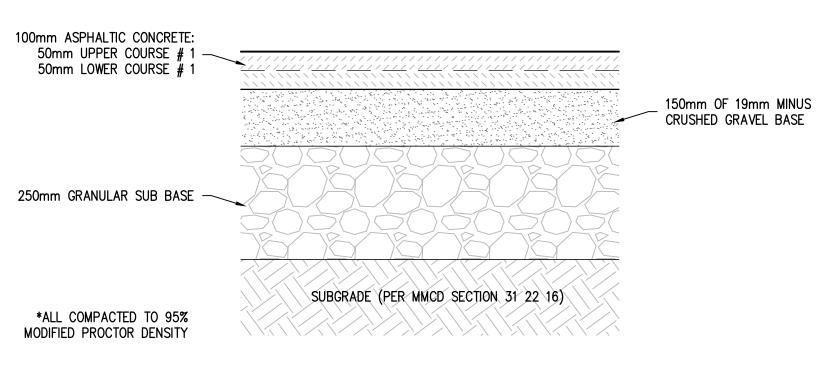

ASPHALT PAVEMENT SPECS. STUDENT UNION BLVD. & WESBROOK MALL SPEC.

ROADWORKS NOTES:

- 1. ALL WORKS TO BE CARRIED OUT IN ACCORDANCE WITH MMCD AND UBC SPECIFICATIONS.
- GEOTECHNICAL ENGINEER TO APPROVE ALL SUBGRADES PRIOR TO PLACING BASE MATERIALS.
- 3. ALL SUBGRADES AND BASE MATERIALS SHALL BE COMPACTED TO 95% MPD. ALL MATERIALS IN ACCORDANCE WITH MMCD STANDARDS.
- 4. COMPACTION TESTING, ASPHALT TESTING AND CONCRETE TESTING BY CONTRACTOR.
- 5. ALL PAVEMENT MARKINGS TO BE INCLUDED IN CONTRACT.
- 6. ALL CONCRETE PAVEMENT AND CONCRETE REINFORCEMENT TO BE IN ACCORDANCE WITH MMCD SECTION 03 20 01, 03 30 20, 32 13 13, AND 03 30 53.
- CONCRETE MIX TO BE TO SECTION 03 30 53: PORTLAND CEMENT: TYPE 10 EXPOSURE CLASS: C-2 SLUMP: 80mm AIR ENTRAINMENT : 5% - 8% MAX. AGGREGATE SIZE: 20mm MIN. 28 DAY COMPRESSIVE STRENGTH: 32 MPa MAX. WATER/CEMENT RATIO: 0.45

WATER NOTES:

1. ALL WORKS TO BE CARRIED OUT IN ACCORDANCE WITH MMCD AND UBC SPECIFICATIONS.

- 2. WATERMAIN TO HAVE MIN. 1.0m COVER.
- 3. PIPE BEDDING SHALL BE GRANULAR PIPE BEDDING AND SURROUND MATERIAL CONFORMING TO MMCD CLAUSE 2.7, SECTION 02226.
- 4. PIPE BACKFILL SHALL BE 100mm PIT RUN GRAVEL MATERIAL CONFORMING TO MMCD CLAUSE 2.3, SECTION 02226.
- 5. ALL PIPE TO BE CLASS 50 DUCTILE IRON MANUFACTURED TO AWWA C151; CEMENT MORTAR LINED TO AWWA C104 AND COATED 1 MIL. THICK ASPHALT.
- 6. PRESSURE AND BACTERIOLOGICAL TESTING TO BE DONE BY CONTRACTOR PRIOR TO TIE-IN AND ACCEPTANCE BY UBC UTILITIES. ASSUMED TEST PRESSURE OF 1380 kPa (200 psi).
- WATER MAIN OR SERVICE PIPE WALLS TO HAVE WRAPPED JOINTS PER LOCAL & MUNICIPAL HEALTH STANDARDS IF CLOSER THAN 0.5m VERTICAL OR 3.0m HORIZONTAL TO SANITARY OR STORM MAIN PIPE
- B. VALVE, VALVE BOXES, COMPONENTS & HYDRANTS TO BE PER UBC TECHNICAL GUIDELINES SECTION 02660, CLAUSE 2.7 AND 2.8. CIRCULAR VALVE BOXES SHALL BE NELSON TYPE.
- 9. ALL WATER VALVE KNUCKLES TO BE RAISED TO 0.6m BELOW FINAL
- 10. ALL WATER MAIN JOINTS TO BE RESTRAINED.

GRADE.

- 11. ALL WATER MAIN FITTINGS TO BE INSTALLED WITH THRUST BLOCKS PER
- 12. ALL TESTING TO BE DONE AND APPROVED BEFORE BACKFILLING PIPE.
- 13. WHERE CONTROLLED DENSITY FILL (CDF) OR CONCRETE IS USED, 6 MIL POLY BARRIER TO BE PLACED BETWEEN CDF/CONCRETE AND WATER MAIN/FITTINGS.

CAPS PLUGS & TEES 90° ELBOWS 45° ELBOWS ANCHOR BLOCK CONV. FACTOR KN TO Kg = PRESSURE= 2068kPa Ab= SURFACE AREA OF BLOCK AGAINST NATIVE GROUND T= THRUST (KN) A- PIPE CROSS iectional area (m² CONC. VOL.=PA(SINO)101.97 T=2PA(SIN22.5'/2) T=2PA(SIN11.25'/2) Tx=PA(1-COSO) T=2PA(SIN45*/2) 140 6.4 70 3.2 28.0 300 14.3 150 7.2 80 25.3 270 520 | 1530 | 206.8 | 2160 | 111.9 | 1170 | 57.1 | 600 | 28.7 | 300 23.1 410 12.5 220 6.4 120 3.2 60 51.8 910 28.0 490 14.3 250 7.2 130 1140 91.9 1600 49.7 870 25.3 440 12.7 230 300 | 146.2 | 2550 | 206.8 | 3600 | 111.9 | 1950 | 57.1 | 1000 | 28.7 | 500 100 | 16.3 | 750 | 23.1 | 1060 | 12.5 | 580 | 6.4 | 300 | 3.2 | 150 CONCRETE THRUST BLOCKS FOR VERTICAL BENDS AND ANCHOR BLOCKS SHALL BE DESIGNED AND SEALED BY A PROFESSIONAL 150 36.6 1680 51.8 2370 28.0 1280 14.3 660 7.2 330 200 65.0 2970 91.9 4200 49.7 2280 25.3 1160 12.7 580 6. FOR SPECIFICATIONS OF LARGER Ø PIPES, OR OPERATING PRESSURES GREATER THAN 1380kPa, SEE ENGINEER. COMPACT 300 146.2 6690 206.8 9460 111.9 5120 57.1 2620 28.7 1320 100 16.3 1700 23.1 2410 12.5 1300 6.4 670 3.2 340 7. BLOCK HEIGHT SHOULD BE EQUAL TO OR LESS THAN ONE—HALF THE TOTAL DEPTH TO THE BOTTOM OF THE BLOCK, BUT NOT LESS 150 36.6 3810 51.8 5390 28.0 2920 14.3 1490 7.2 750 THAN THE PIPE DIAMETER. 200 65.0 6760 91.9 9560 49.7 5180 25.3 2640 12.7 1330 8. BLOCK HEIGHT SHOULD BE CHOSEN SUCH THAT THE CALCULATED BLOCK WIDTH VARIES BETWEEN ONE AND TWO TIMES THE HEIGHT. 300 | 146.2 | 15220 | 206.8 | 21520 | 111.9 | 11650 | 57.1 | 5950 | 28.7 | 2990 TYPICAL SIZING OF CONC. THRUST BLOCKS

DIALOG®

CoreGroup LAND DEVELOPMENT SERVICES 320-8988 FRASERTON COURT BURNABY, BC V5J 5H8

tel. (604)299 0605 fax. (604)299 0629

ISSUED FOR

1 / 2016-03-30 / SLP SUBMISSION 2 / 2016-04-26 / SLP - PHASE 1_UNDERGROUND

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GRAPHIC SCALE SCALE: 1:500

SEAL


UBC Gage South


PHASE 1 UNDERGROUND WORKS


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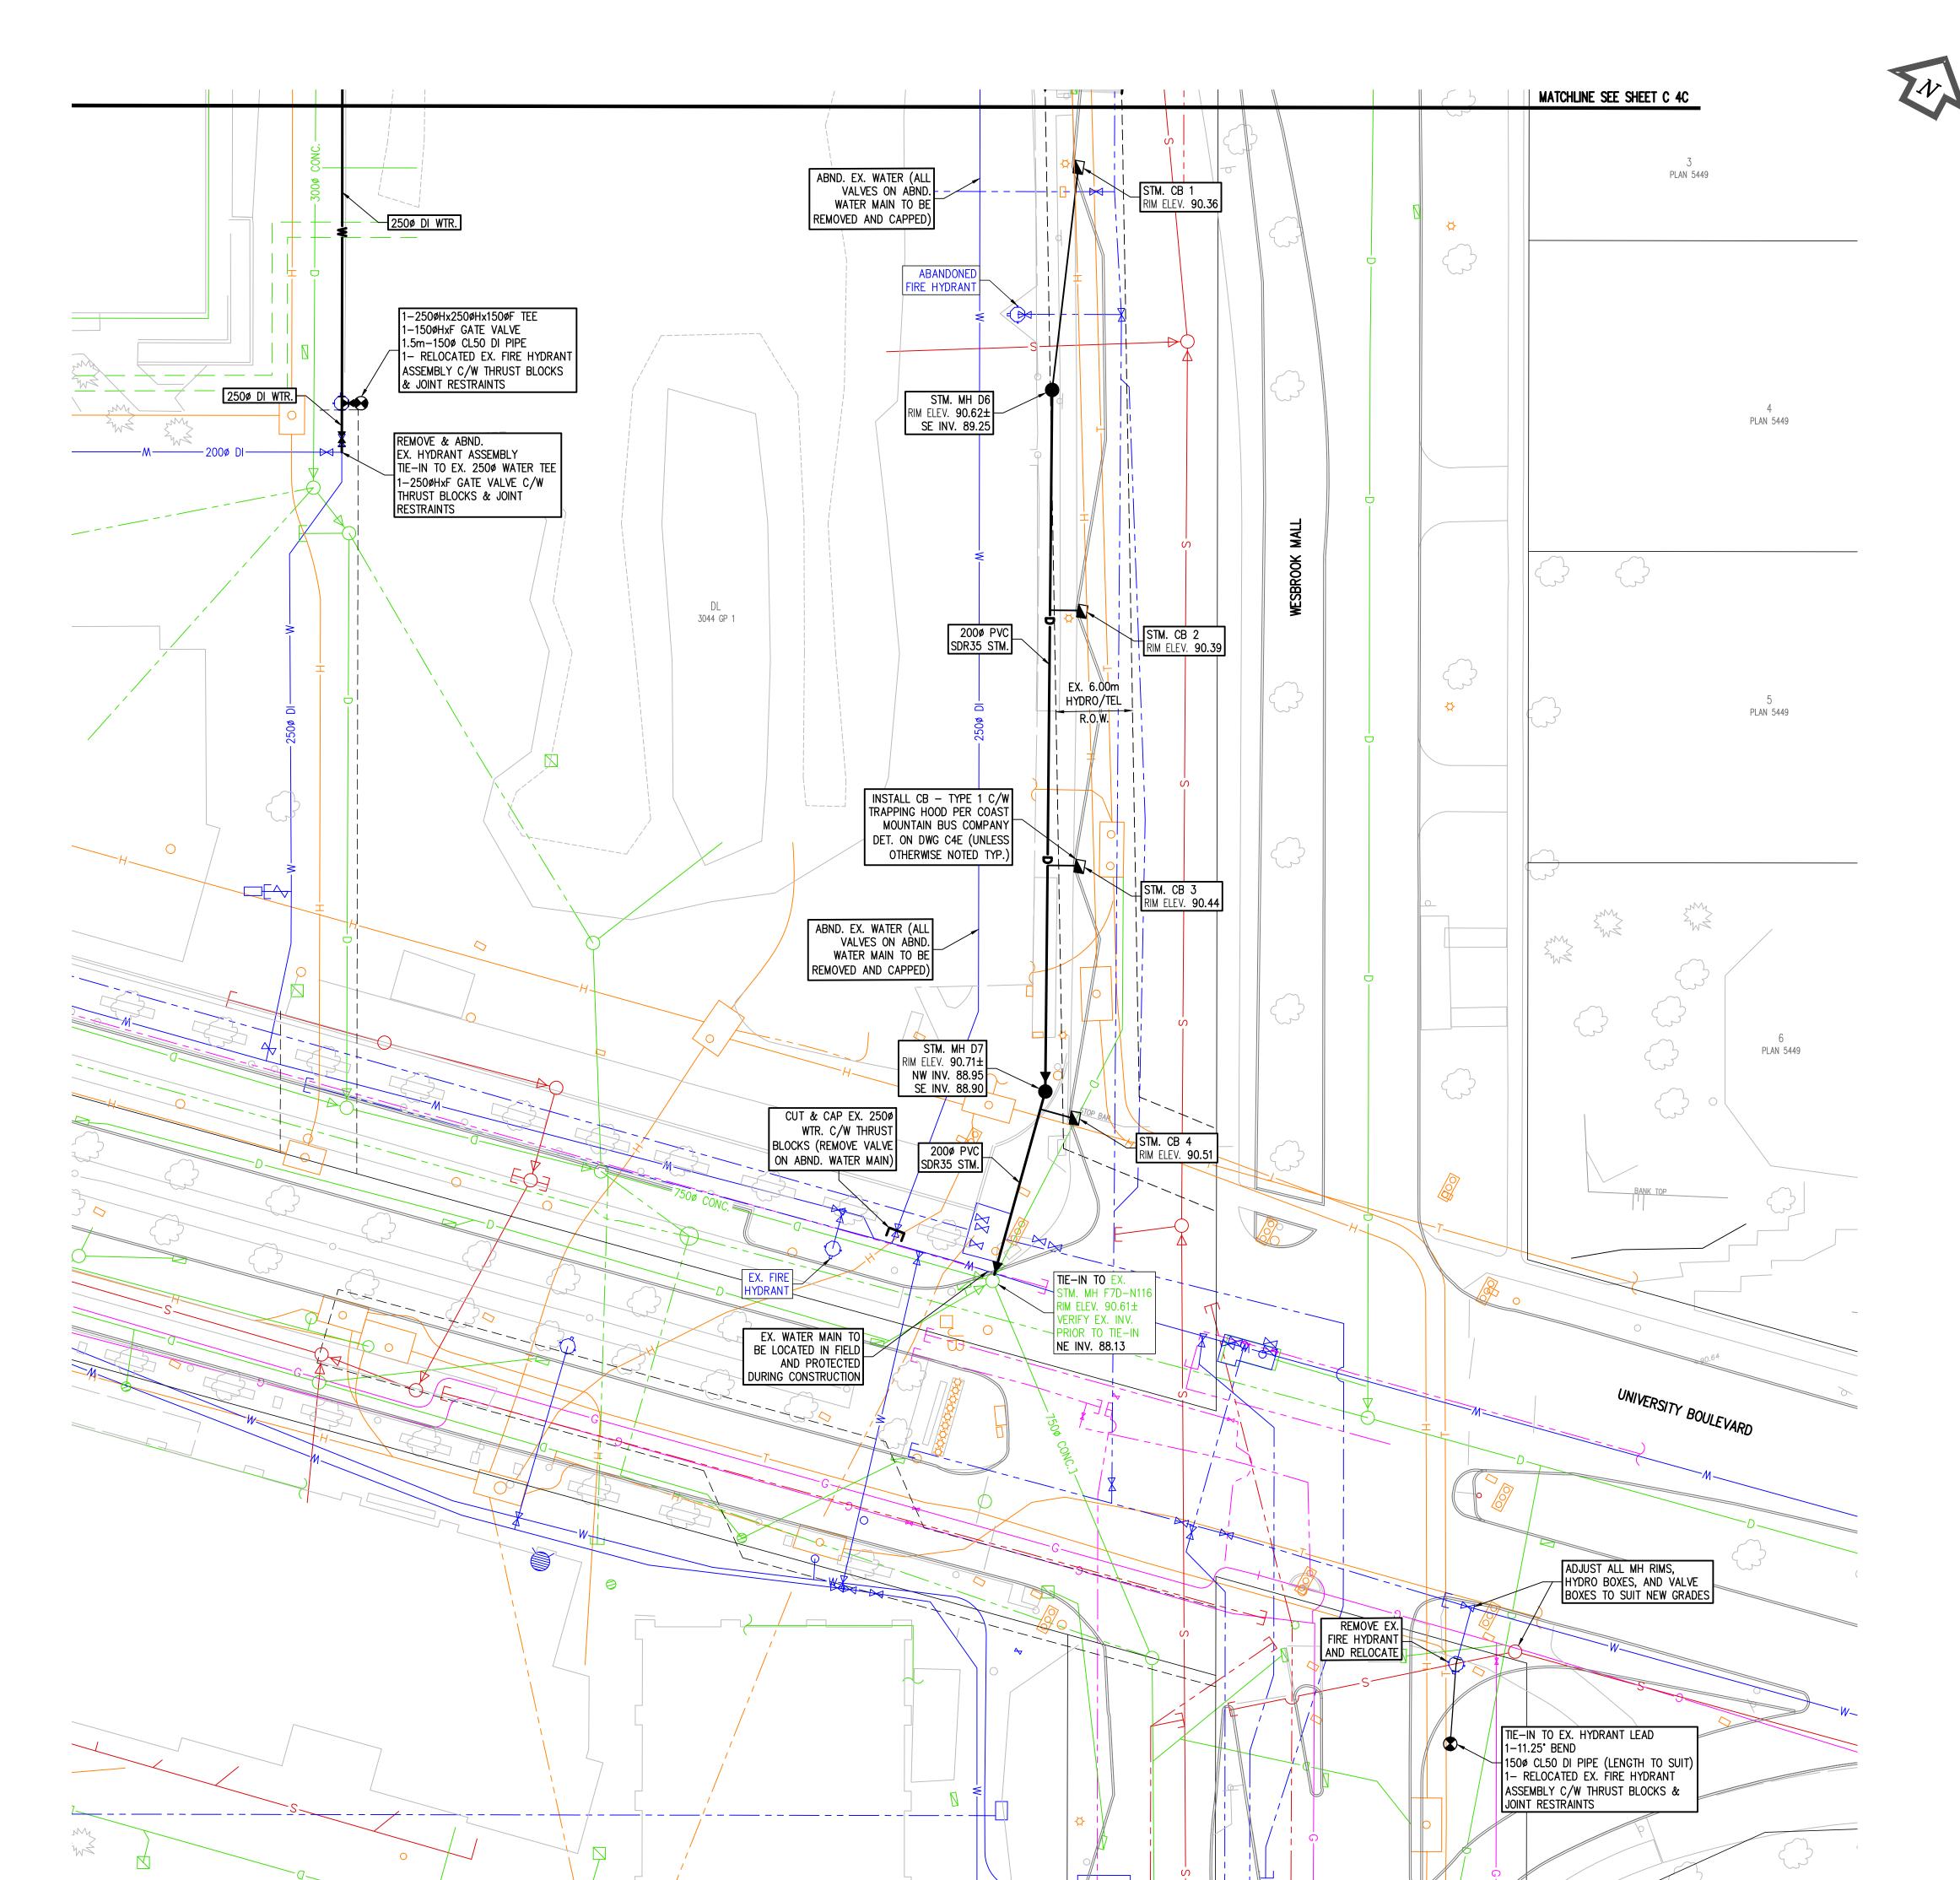
Civil Design **NOTES & DETAILS**

DRAWN: BC



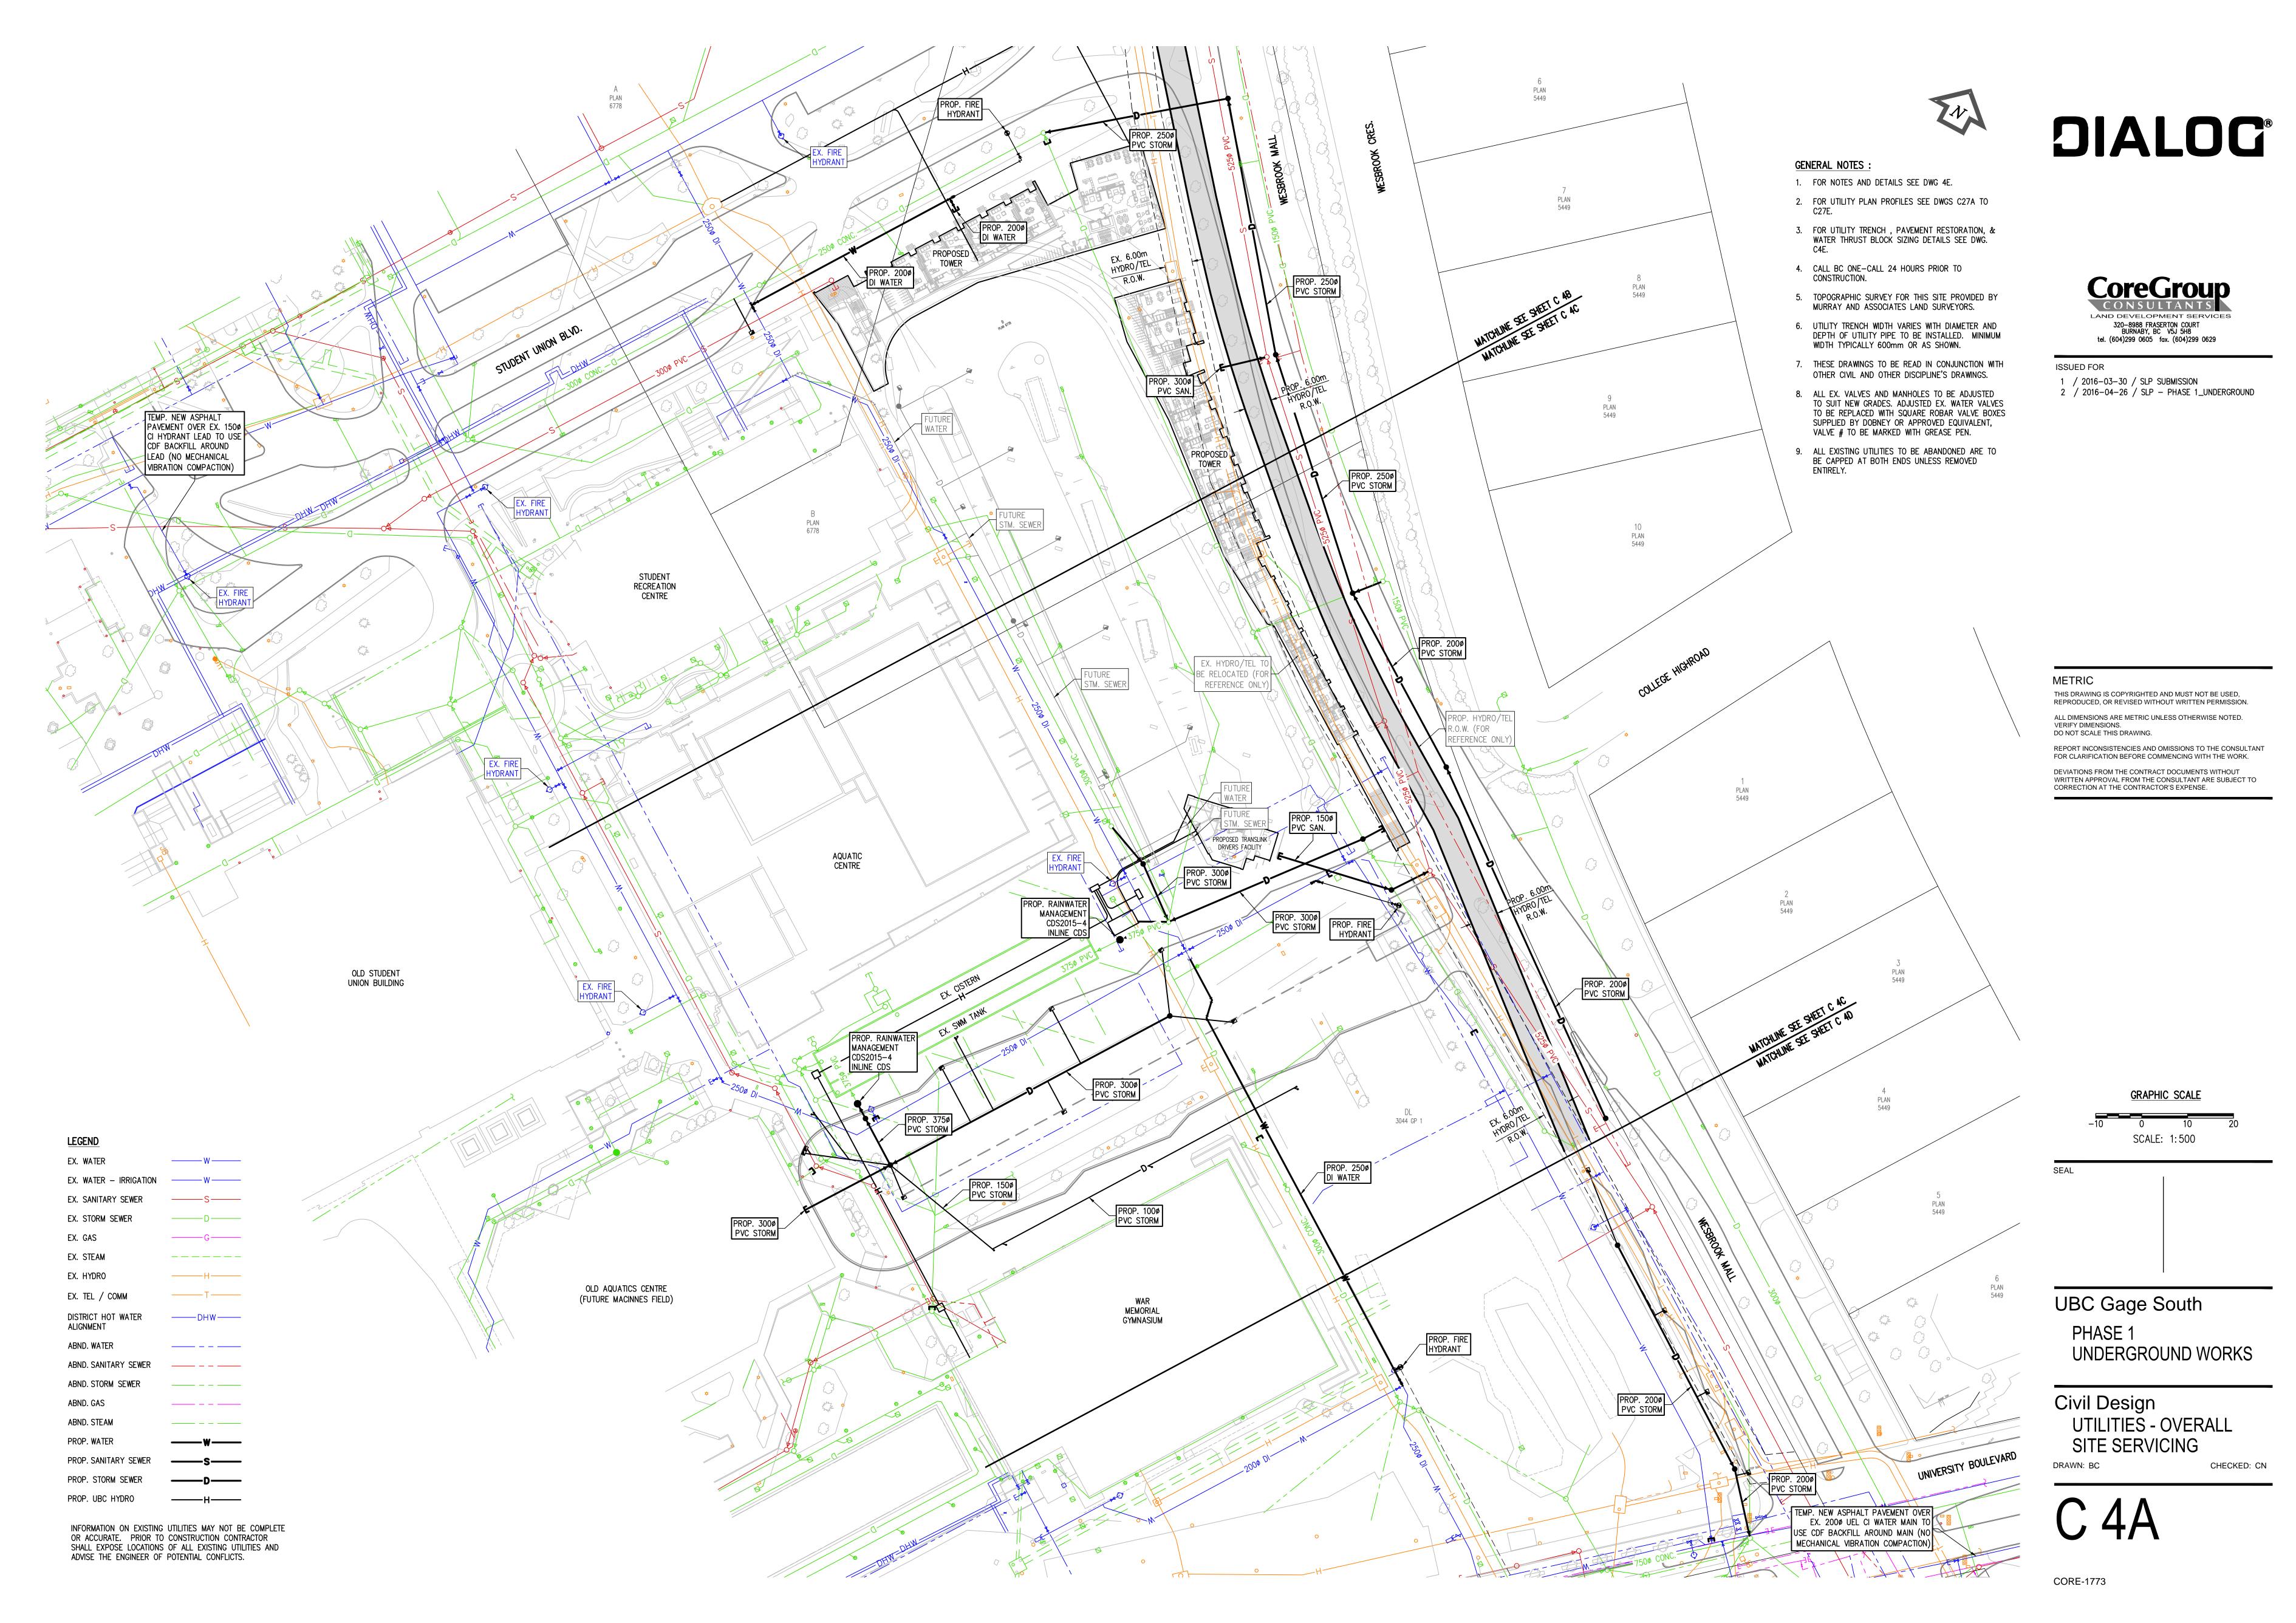

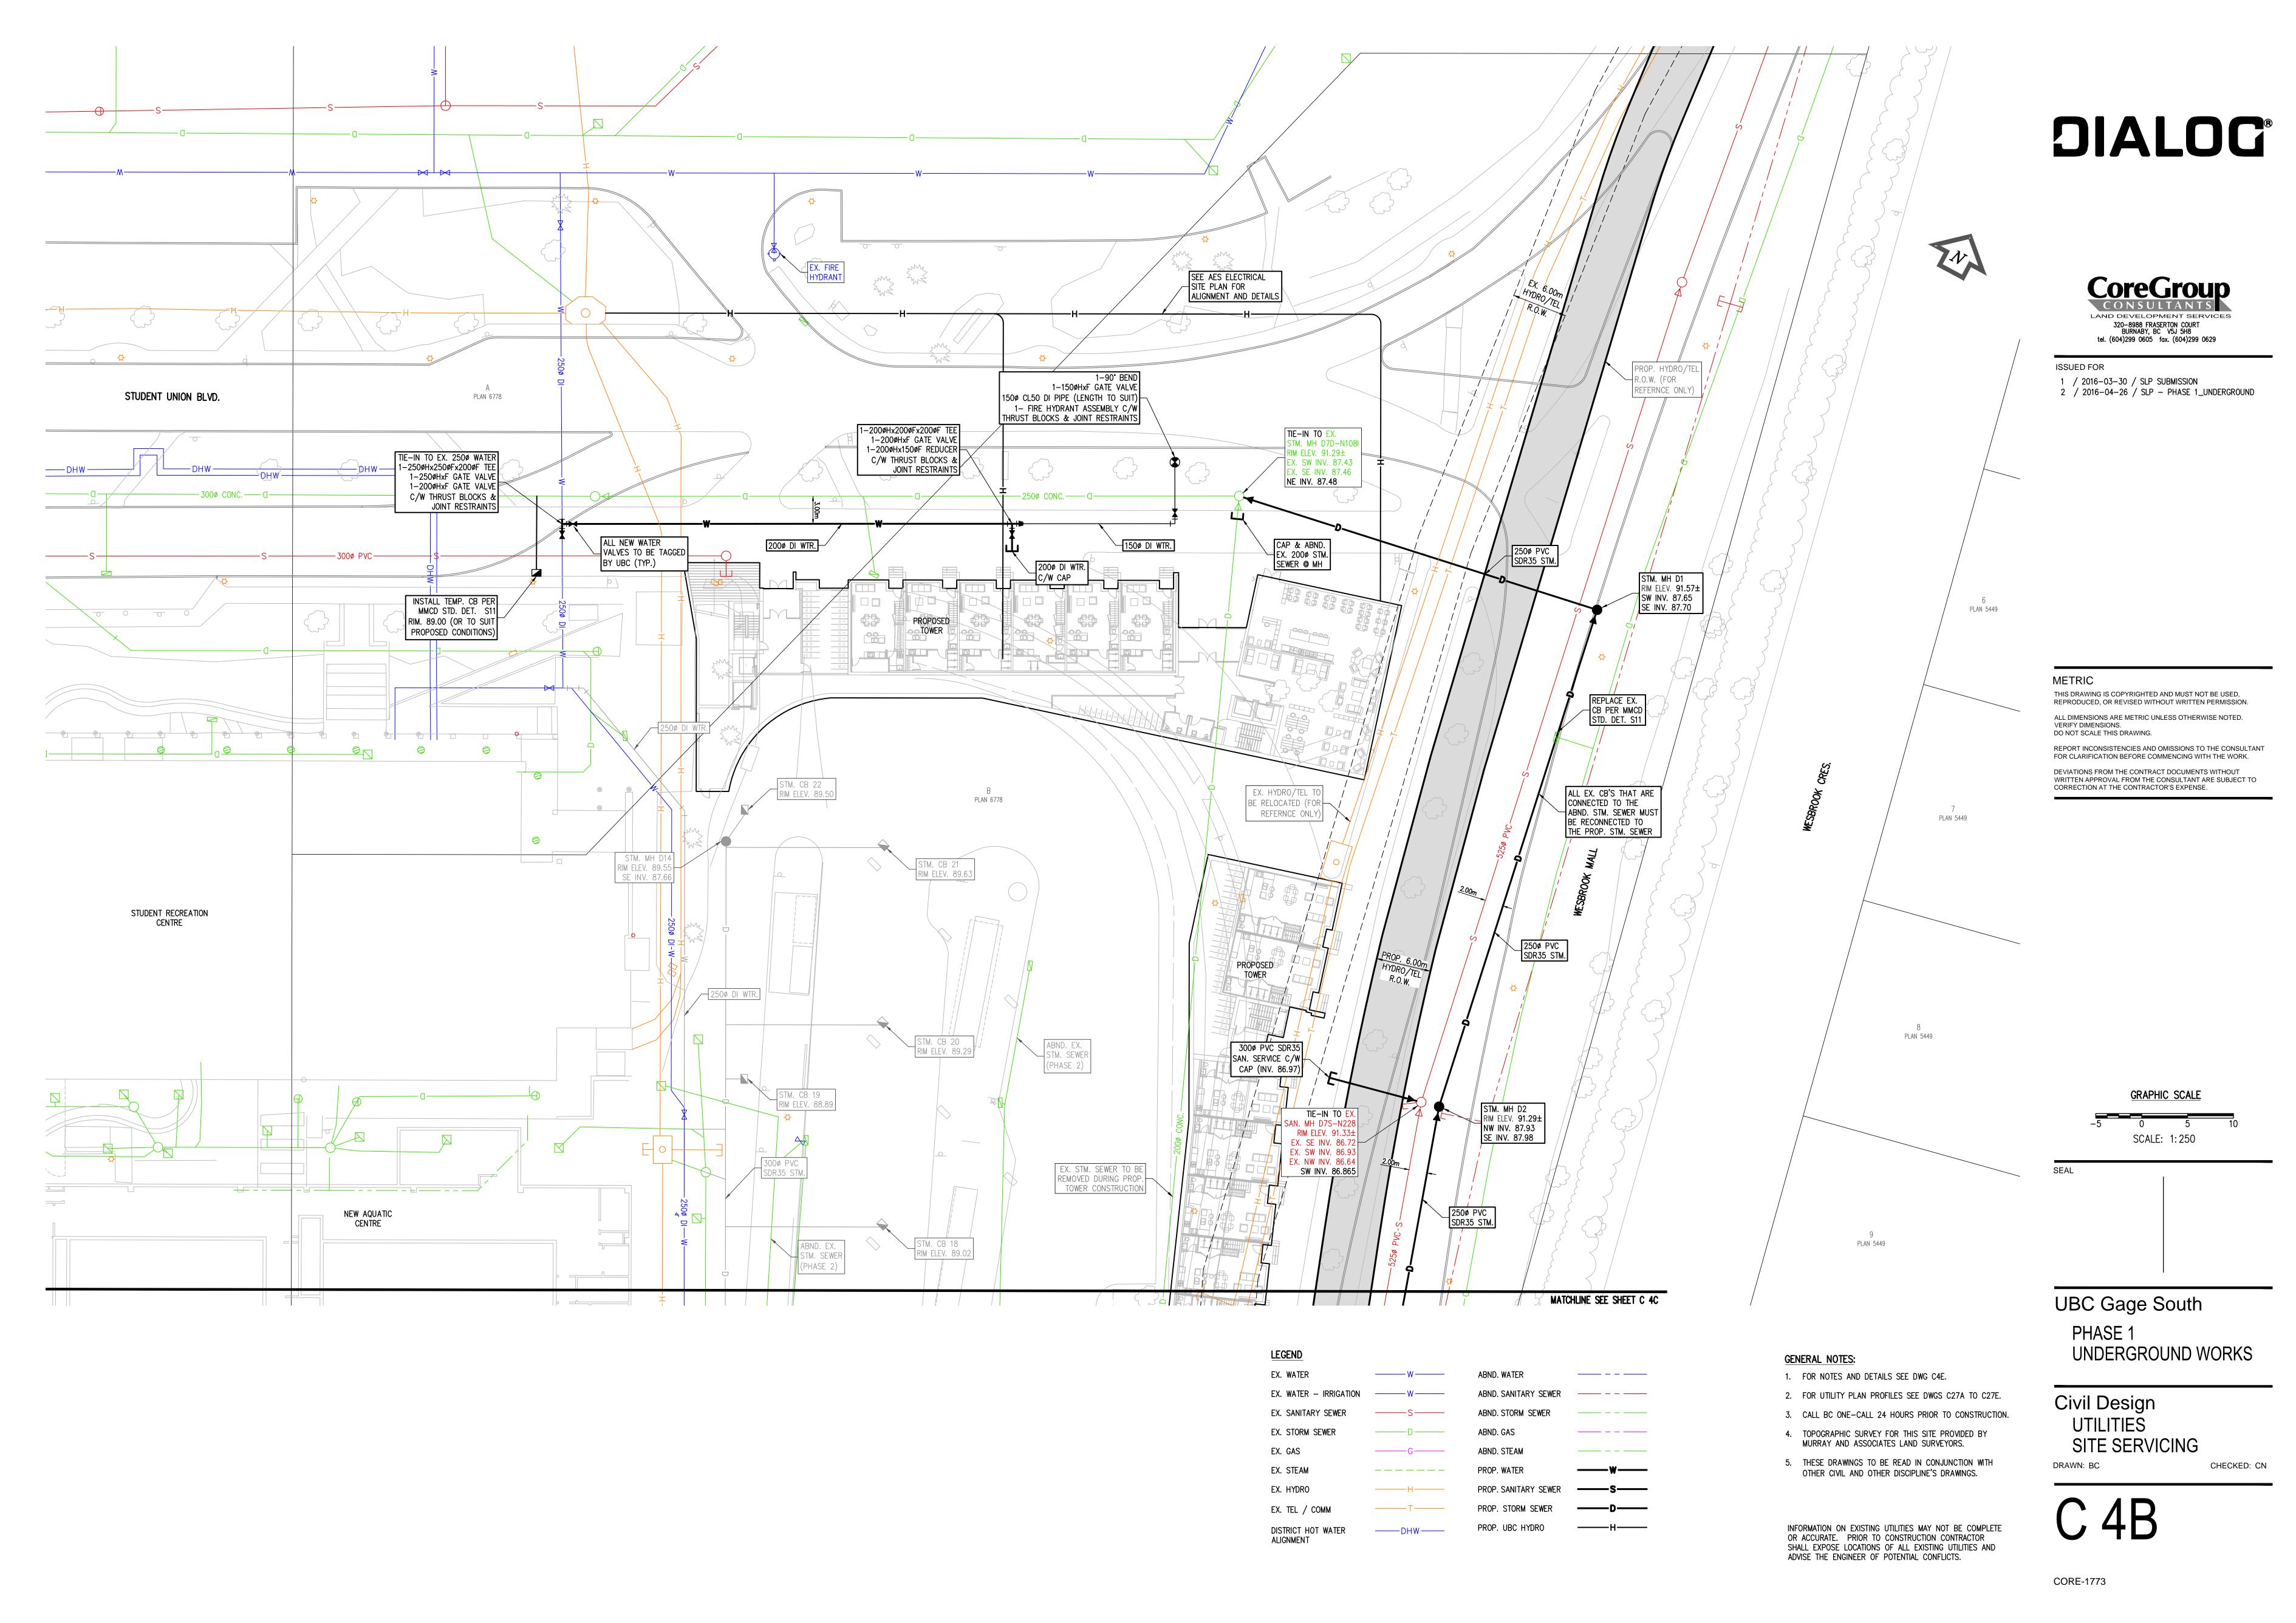

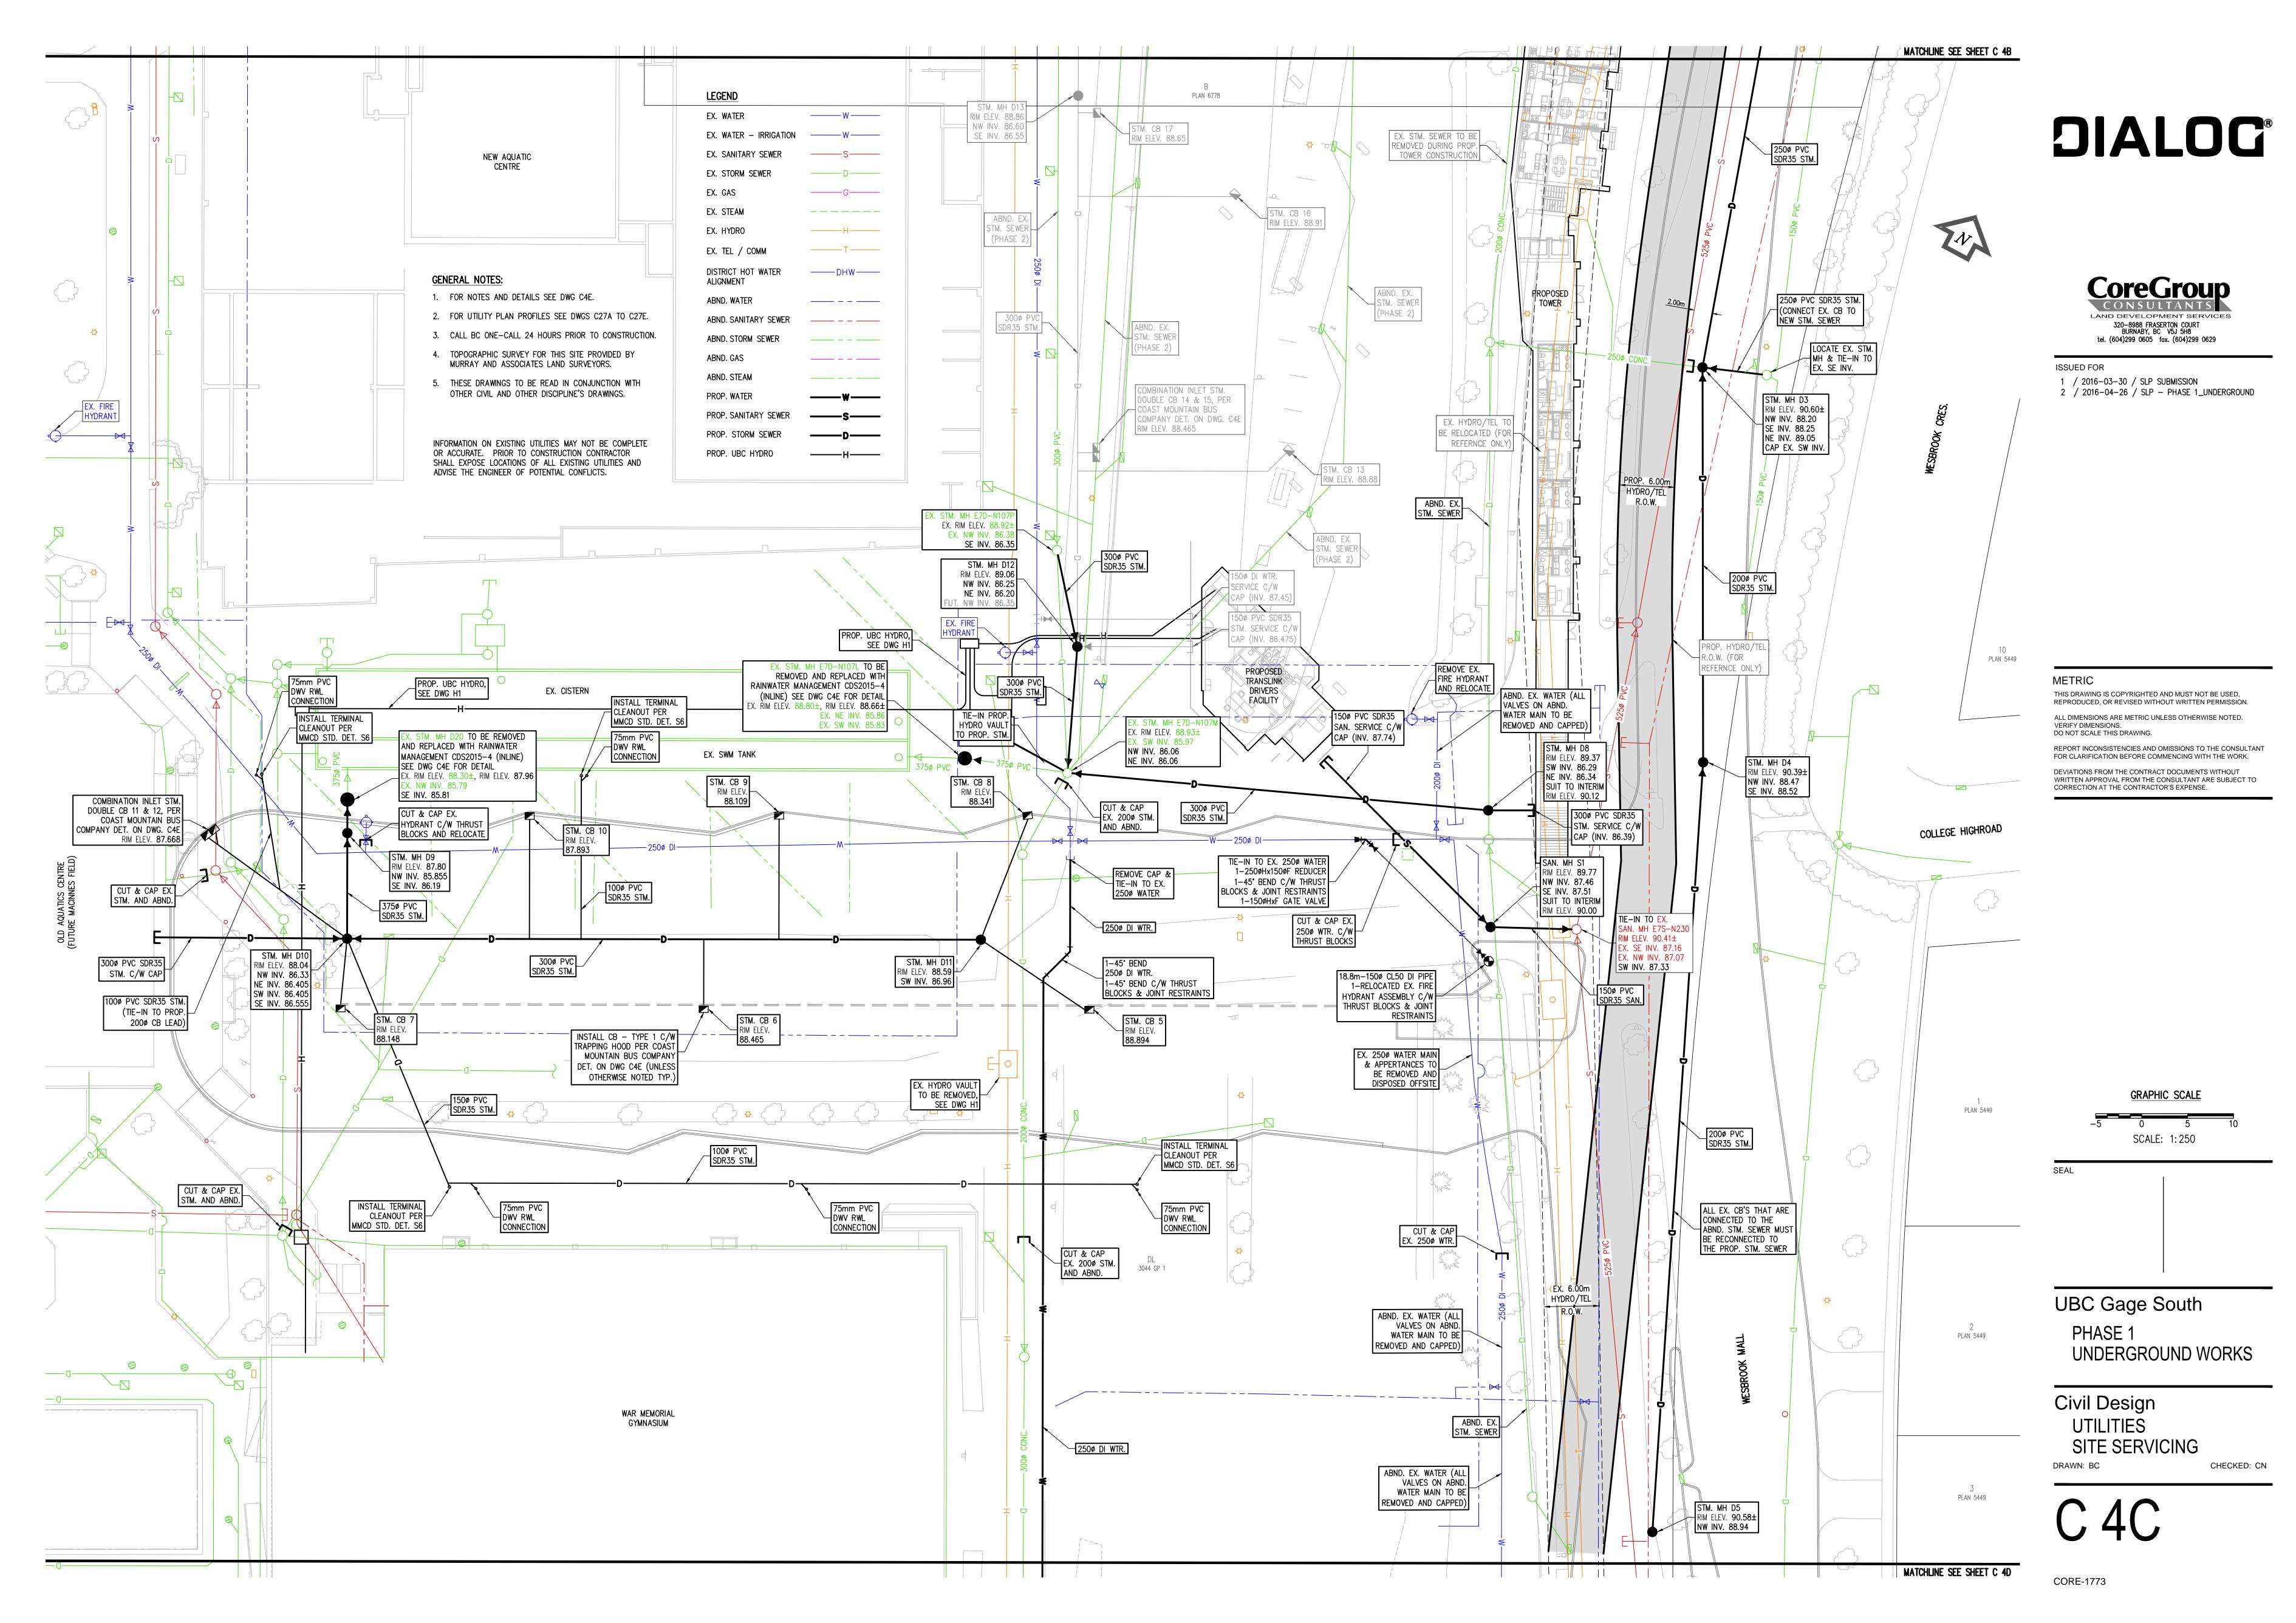

GENERAL NOTES:

LEGEND

EX. GAS

EX. STEAM

EX. HYDRO

EX. TEL / COMM

ABND. WATER

ABND. GAS

ABND. STEAM

PROP. WATER

DISTRICT HOT WATER ALIGNMENT

ABND. SANITARY SEWER

PROP. SANITARY SEWER

PROP. STORM SEWER

ABND. STORM SEWER

EX. WATER

EX. WATER — IRRIGATION

____D__

———G——

_____T___

——DHW——

EX. SANITARY SEWER

EX. STORM SEWER


1. FOR NOTES AND DETAILS SEE DWG C4E.

2. FOR UTILITY PLAN PROFILES SEE DWGS C27A TO C27E.

4. TOPOGRAPHIC SURVEY FOR THIS SITE PROVIDED BY MURRAY AND ASSOCIATES LAND SURVEYORS.

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3. CALL BC ONE-CALL 24 HOURS PRIOR TO CONSTRUCTION.



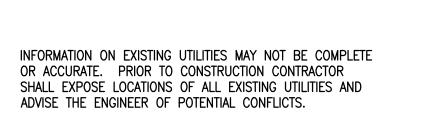



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GRAPHIC SCALE

-5 0 5 10

SCALE: 1: 250

UBC Gage South

PHASE 1 UNDERGROUND WORKS

Civil Design
UTILITIES
SITE SERVICING
DRAWN: BC CHECKED: CN

C 4D

TESTING:


- 1. ALL TESTING TO BE PERFORMED BY A CSA OR CCIL (CANADIAN CERTIFIED TESTING LABORATORIES) CERTIFIED LABORATORY.
- FREQUENCY OF DENSITY TESTS FOR EXCAVATING, TRENCHING AND BACKFILLING SHALL BE ONE TEST PER 50 LINEAL METRES OR TRENCH PER METRE OF DEPTH. MATERIAL TO BE COMPACTED IN 300mm LIFTS.
- 3. FREQUENCY OF DENSITY TESTS FOR ROADWAY EXCAVATION, EMBANKMENT (SUB-GRADE FILL) AND COMPACTION SHALL BE ONE TEST PER 250m² PER 300mm LIFT.
- 4. FREQUENCY OF DENSITY TESTS FOR GRANULAR BASE AND SUB-BASE SHALL BE ONE TEST PER 30 LINEAL METRES OF LANE WIDTH STAGGERED EACH SIDE OF CENTRELINE PER 150mm LIFT OR OF SPECIFIED THICKNESS.
- 5. FREQUENCY OF DENSITY TESTS FOR SIDEWALK BASE SHALL BE ONE TEST PER 30 LINEAL METRES WITHIN SIDEWALK AND DRIVEWAY AREA.
- 6. FREQUENCY OF DENSITY TESTS FOR CURB BASE SHALL BE ONE TEST PER 100 LINEAL METRES.
- 7. FREQUENCY OF MARSHALL TESTS FOR HOT-MIX ASPHALT CONCRETE PAVING SHALL BE ONE TEST PER 500 TONNES OF MIX PLACED OR ONE TEST FOR EACH TYPE OF ASPHALT MIX, MINIMUM ONE PER DAY.
- 8. FOR PAVING, CORE LOCATIONS WILL BE SELECTED FOR EACH PASS OF THE PAVING MACHINE AS
- 8.1. ACROSS THE WIDTH, CORE LOCATIONS WILL BE SELECTED RANDOMLY FROM ONE-SIXTH
- 8.2. ALONG THE LENGTH, CORE LOCATIONS WILL HAVE A RANDOMLY SELECTED START WITH CORES
- AT A SPACING OF APPROXIMATELY, BUT NOT TO EXCEED 30 METRES. 8.3. FOR OTHER PAVING OPERATIONS, A MINIMUM OF ONE CORE FOR EVERY 250 SQUARE METRES OF ASPHALT MIX PLACED.
- FREQUENCY OF PLASTIC CONCRETE TESTS FOR SIDEWALK SHALL BE ONE TEST PER 150 LINEAL METRES OR A MINIMUM OF ONE PER DAY.
- 10. FREQUENCY OF PLASTIC CONCRETE TESTS FOR CURB AND GUTTER SHALL BE ONE TEST PER 300 LINEAR METRES OF A MINIMUM OF ONE PER DAY.
- 11. PRESSURE AND BACTERIOLOGICAL TESTING TO BE DONE BY CONTRACTOR PRIOR TO TIE-IN AND ACCEPTANCE BY UBC UTILITIES. ASSUMED TEST PRESSURE OF 1380 kPa (200 psi). THE CONTRACTOR SHALL TEST ALL WATERMAINS: PRESSURE TEST TO B.C. BUILDING CODE (2012) AND SHALL CHLORINATE AND FLUSH TO MINISTRY OF HEALTH AND AWWA STANDARDS. ALL TESTING IS TO BE WITNESSED BY THE ENGINEER AND THE UBC INSPECTOR. TESTING TO BE APPROVED BY UBC PRIOR TO TIE-IN TO MUNICIPAL WATER SYSTEM. ALL STORM AND SANITARY SYSTEMS TO BE TESTED PER SECTION 3.6 OF THE B.C. PLUMBING CODE. THE ENGINEER IS TO BE NOTIFIED 48 HOURS PRIOR TO TESTING.
- 12. STORM SEWERS SHALL BE VIDEO INSPECTED PER MMCD SPECIFICATIONS SECTION 02731.
- 13. SANITARY SEWERS SHALL BE PRESSURE TESTED AND VIDEO INSPECTED PER MMCD
- 14. EXISTING SANITARY AND STORM SERVICE STUBS ARE TO BE CCTV INSPECTED AFTER SHORING. SUBMIT THE CCTV INSPECTION REPORTS AND VIDEOS TO UTILITIES TO ENSURE NO CONSTRUCTION DAMAGE ON EXISTING SERVICE STUBS.
- 15. ALL TESTING TO BE DONE AND APPROVED BEFORE BACKFILLING PIPE.


WATER NOTES

- 1. ALL WORKS TO BE CARRIED OUT IN ACCORDANCE WITH MMCD AND UBC SPECIFICATIONS.
- 2. WATERMAIN TO HAVE MIN. 1.0m COVER.
- 3. PIPE BEDDING SHALL BE GRANULAR PIPE BEDDING AND SURROUND MATERIAL CONFORMING TO MMCD CLAUSE 2.7. SECTION 02226.
- 4. PIPE BACKFILL SHALL BE 100mm PIT RUN GRAVEL MATERIAL CONFORMING TO MMCD CLAUSE 2.3. SECTION 02226.
- 5. ALL PIPE TO BE CLASS 50 DUCTILE IRON MANUFACTURED TO AWWA C151; CEMENT MORTAR LINED TO AWWA C104 AND COATED 1 MIL. THICK ASPHALT.
- 6. PRESSURE AND BACTERIOLOGICAL TESTING TO BE DONE BY CONTRACTOR PRIOR TO TIE-IN AND ACCEPTANCE BY UBC UTILITIES. ASSUMED TEST PRESSURE OF 1380 kPa (200 psi).
- 7. WATER MAIN OR SERVICE PIPE WALLS TO HAVE WRAPPED JOINTS PER LOCAL & MUNICIPAL HEALTH STANDARDS IF CLOSER THAN 0.5m VERTICAL OR 3.0m HORIZONTAL TO SANITARY OR STORM MAIN PIPE WALLS.
- 8. VALVE, VALVE BOXES, COMPONENTS & HYDRANTS TO BE PER UBC TECHNICAL GUIDELINES SECTION 02660, CLAUSE 2.7 AND 2.8. CIRCULAR VALVE BOXES SHALL BE NELSON TYPE.
- 9. ALL WATER VALVE KNUCKLES TO BE RAISED TO 0.6m BELOW FINAL GRADE.
- 10. ALL WATER MAIN JOINTS TO BE RESTRAINED.

STORM & SANITARY SEWER NOTES :


- 11. ALL WATER MAIN FITTINGS TO BE INSTALLED WITH THRUST BLOCKS PER MMCD.
- 12. ALL TESTING TO BE DONE AND APPROVED BEFORE BACKFILLING PIPE.
- 13. WHERE CONTROLLED DENSITY FILL (CDF) OR CONCRETE IS USED, 6 MIL POLY BARRIER TO BE PLACED BETWEEN CDF/CONCRETE AND WATER MAIN/FITTINGS.
- 7. ALL SANITARY AND STORM SEWER MANHOLES TO BE 1. ALL WORKS TO BE CARRIED OUT IN ACCORDANCE WITH CURRENT UBC AND MMCD SPECIFICATIONS.
- 2. PIPE BEDDING SHALL BE GRANULAR PIPE BEDDING AND SURROUND MATERIAL CONFORMING TO MMCD CLAUSE 2.7, SECTION 02226.
- 3. PIPE BACKFILL SHALL BE 100mm PIT RUN GRAVEL MATERIAL CONFORMING TO MMCD CLAUSE 2.3, SECTION 02226.
- 4. ALL PIPES UP TO AND INCLUDING 525mmø PVC PIPE TO UBC SPECIFICATIONS AS FOLLOWS (UNLESS OTHERWISE NOTED)
- 150mmø & SMALLER SDR28 - 200mmø TO 525mmø SDR35 TO ASTM 03034 SPECS.
- 5. ALL PIPES SHALL HAVE CLOSED JOINTS
- 6. PIPE TO BE INSTALLED PER MANUFACTURER'S RECOMMENDATIONS FOR PIPE DEPTH AND SLOPE PER SOIL CONDITIONS.

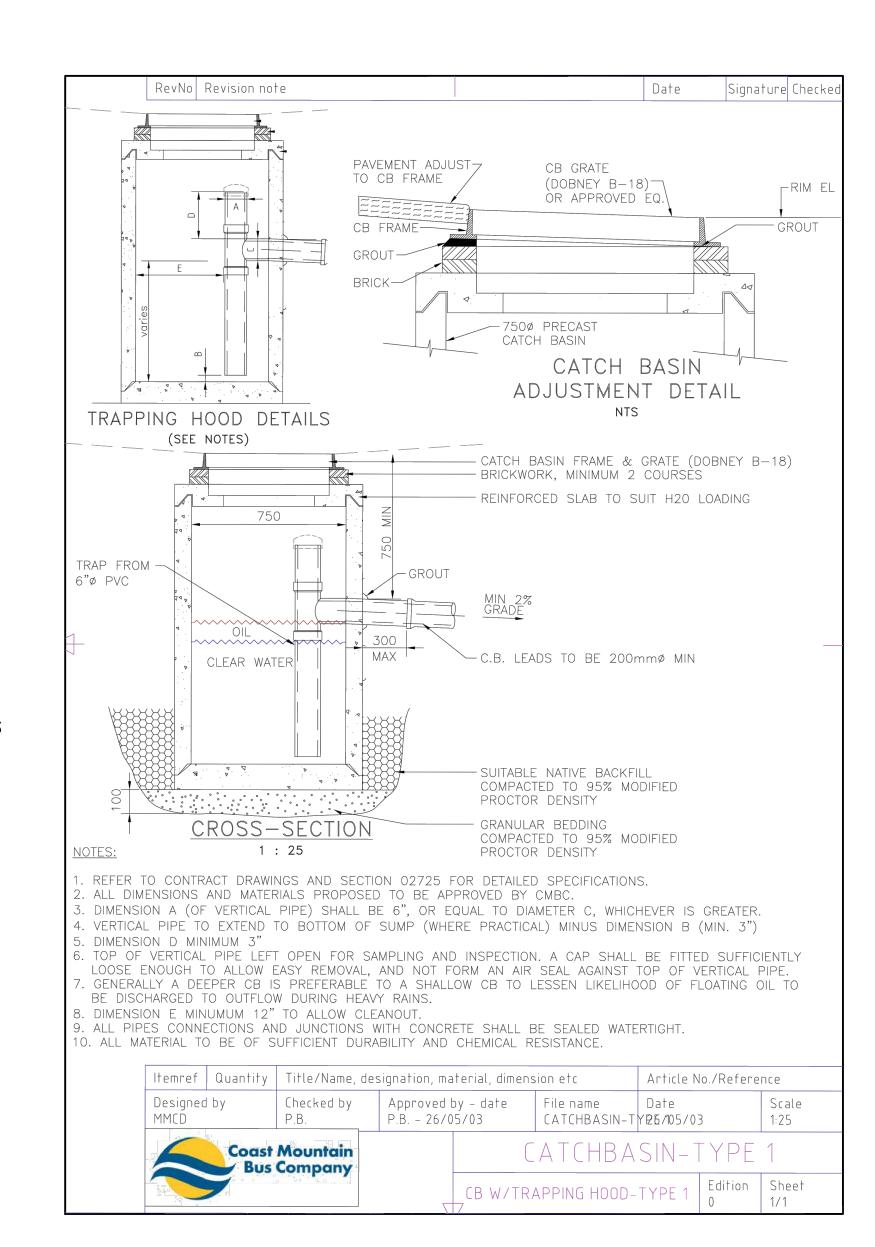


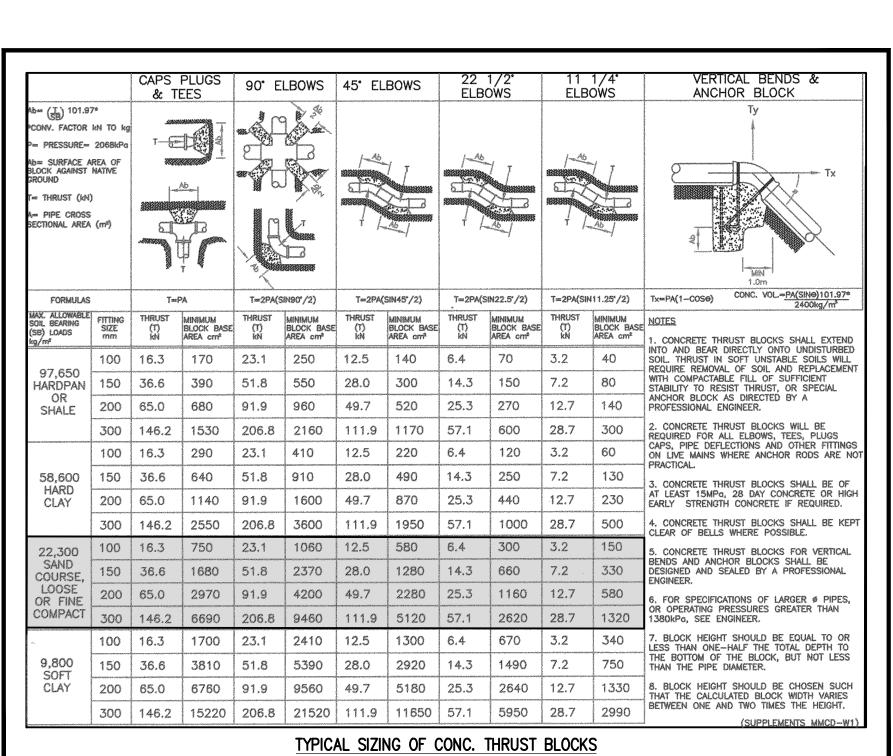



1050mmø WITH MARKINGS PER UBC REQUIREMENTS UNLESS OTHERWISE NOTED.

- 8. ALL CATCH BASIN LEADS SHALL HAVE A MINIMUM OF 1.0% GRADE.
- 9. ALL STORM MANHOLES TO BE BENCHED UNLESS NOTED OTHERWISE.
- 10. CONTRACTOR TO CONFIRM ANY FOUNDATION STABILIZATION REQUIREMENTS OF EXISTING STRUCTURES IN TRENCHING AREA WITH GEOTECHNICAL ENGINEER.
- 11. EXISTING SANITARY AND STORM SERVICE STUBS ARE TO BE CCTV INSPECTED AFTER SHORING. SUBMIT THE CCTV INSPECTION REPORTS AND VIDEOS TO UTILITIES TO ENSURE NO CONSTRUCTION DAMAGE ON EXISTING SERVICE STUBS.

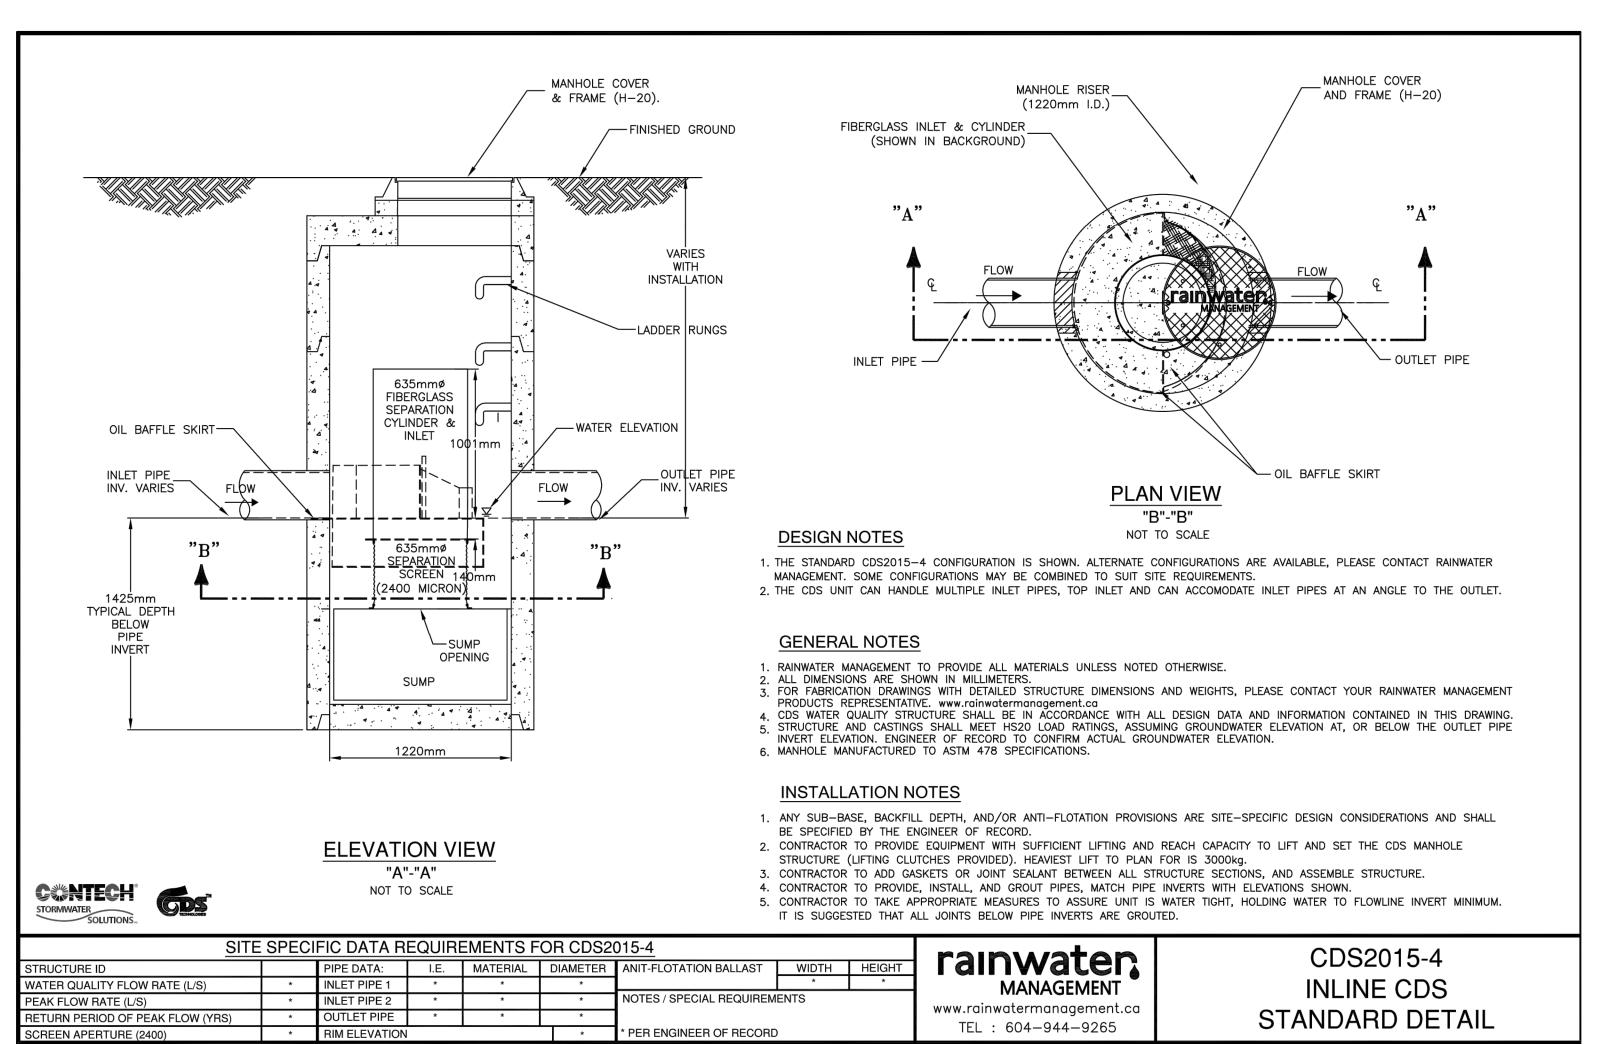

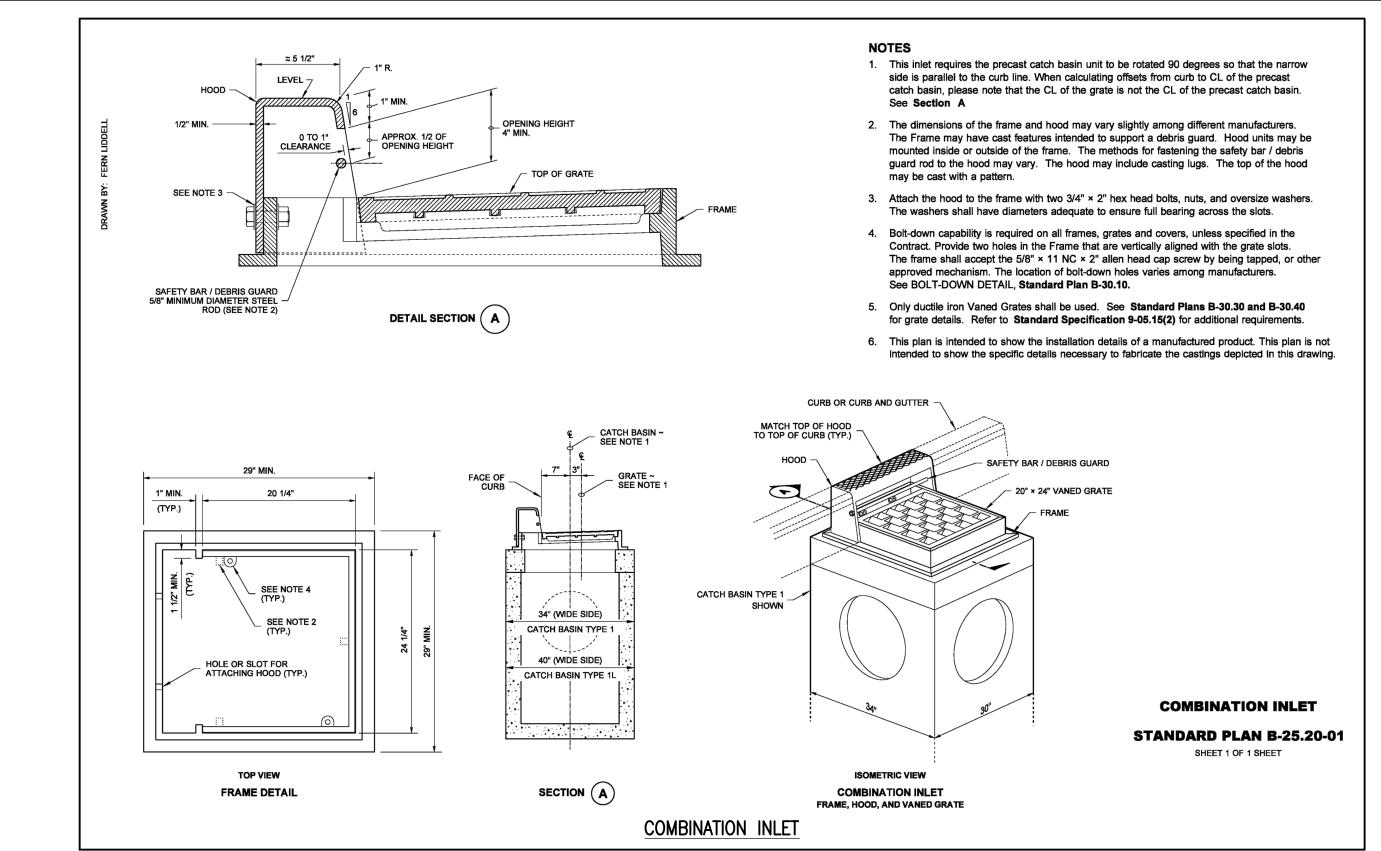

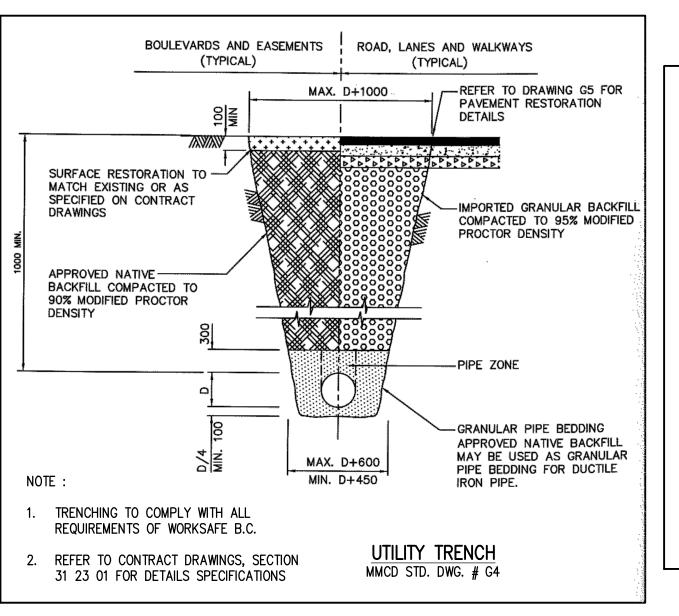

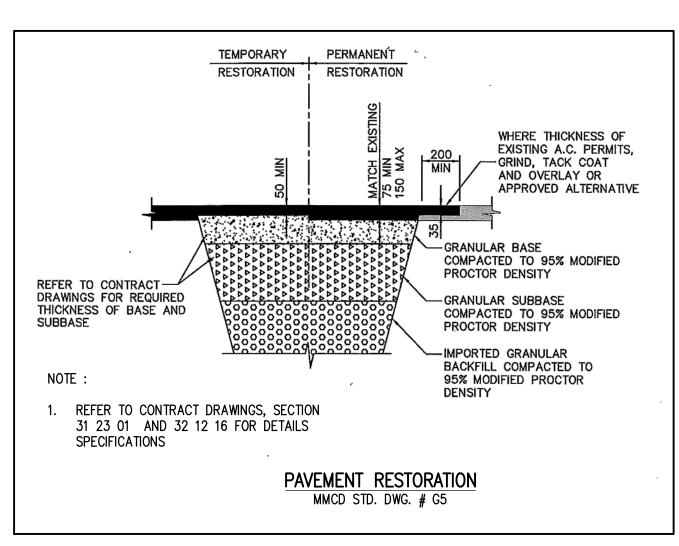

DIALOG®

LAND DEVELOPMENT SERVICES 320-8988 FRASERTON COURT BURNABY, BC V5J 5H8 tel. (604)299 0605 fax. (604)299 0629

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> GRAPHIC SCALE SCALE: 1:250

SEAL


UBC Gage South PHASE 1


UNDERGROUND WORKS

CHECKED: CN

Civil Design UTILITIES **NOTES & DETAILS**

DRAWN: BC

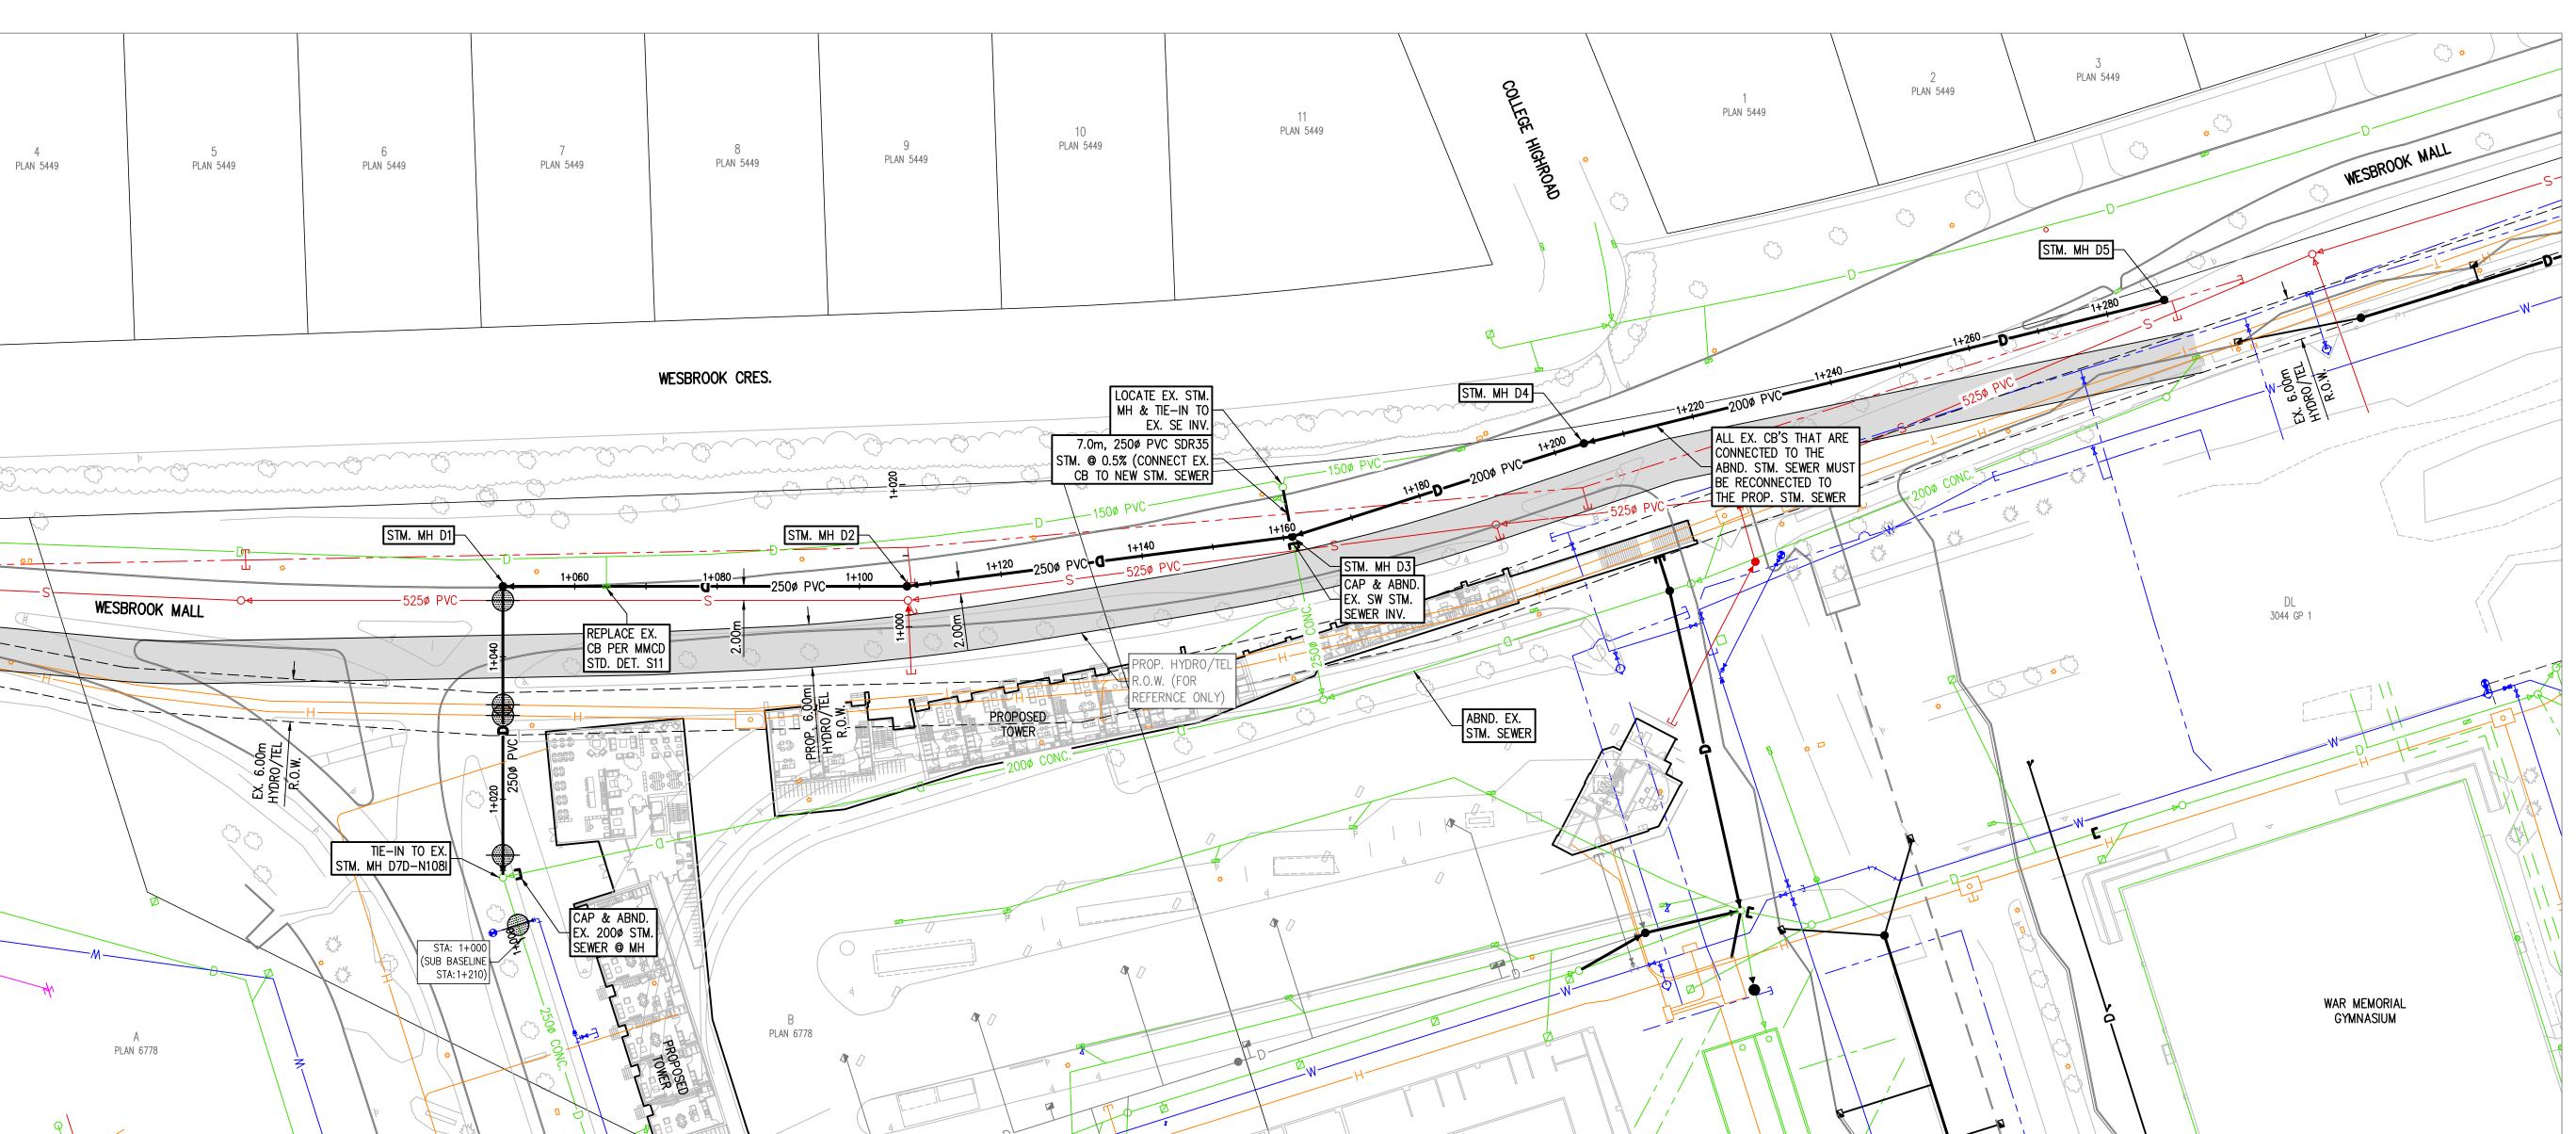

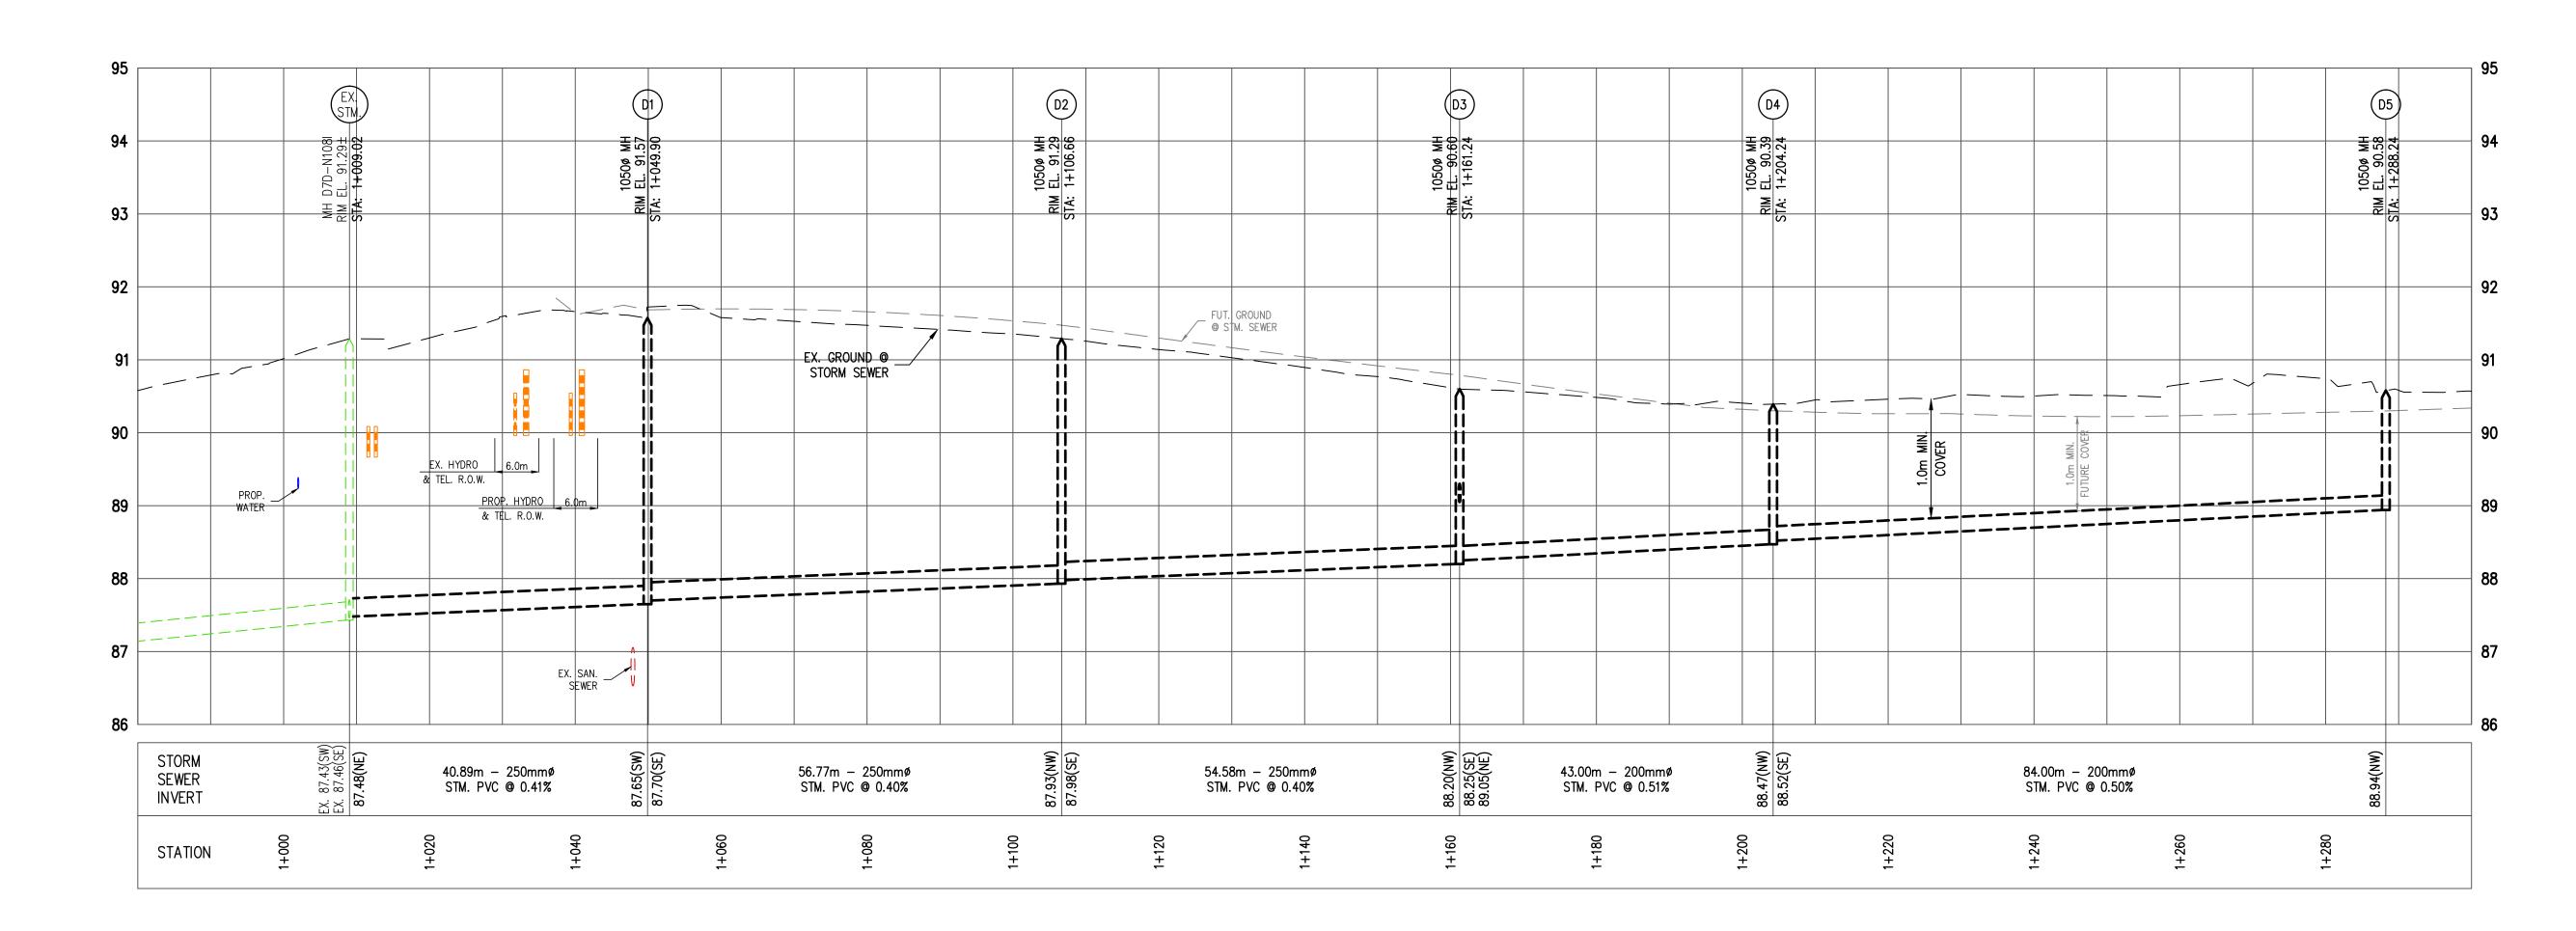



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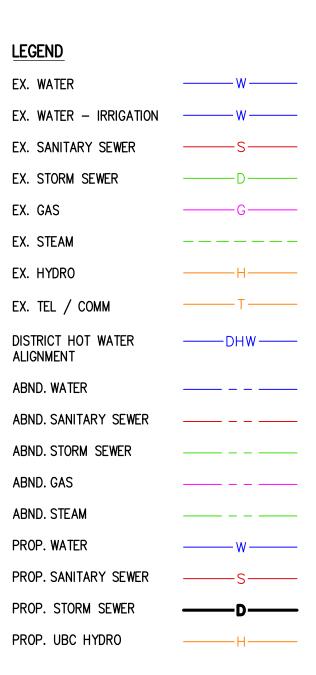
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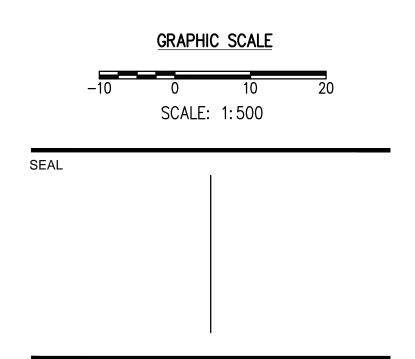
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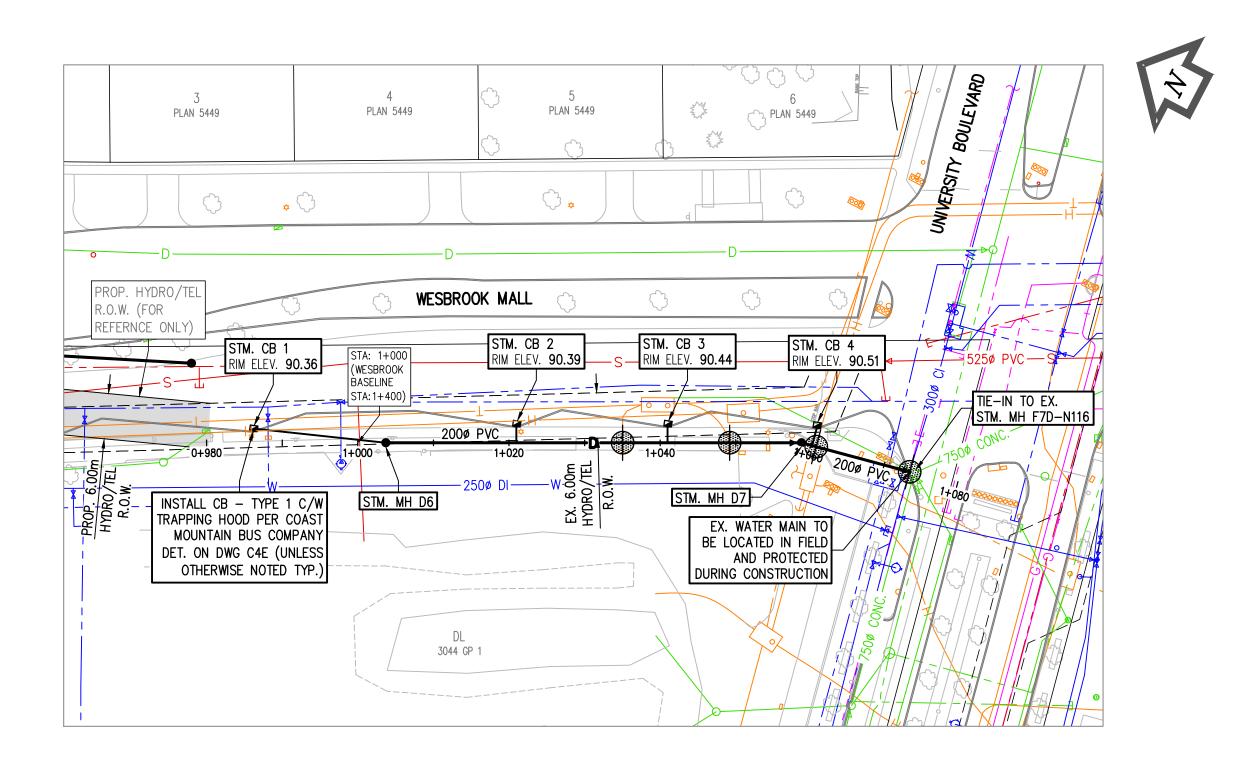
UBC Gage South


PHASE 1 UNDERGROUND WORKS


Civil Design
UTILITIES - PLAN/PROFILE
STORM SEWER

DRAWN: BC CHECKED: CN

C 27A



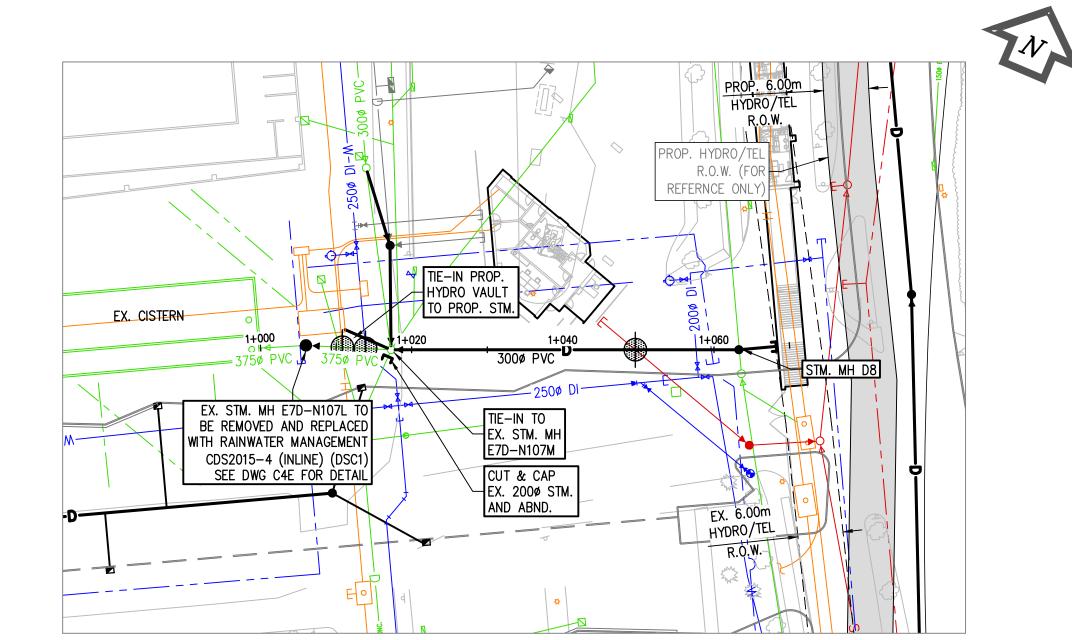


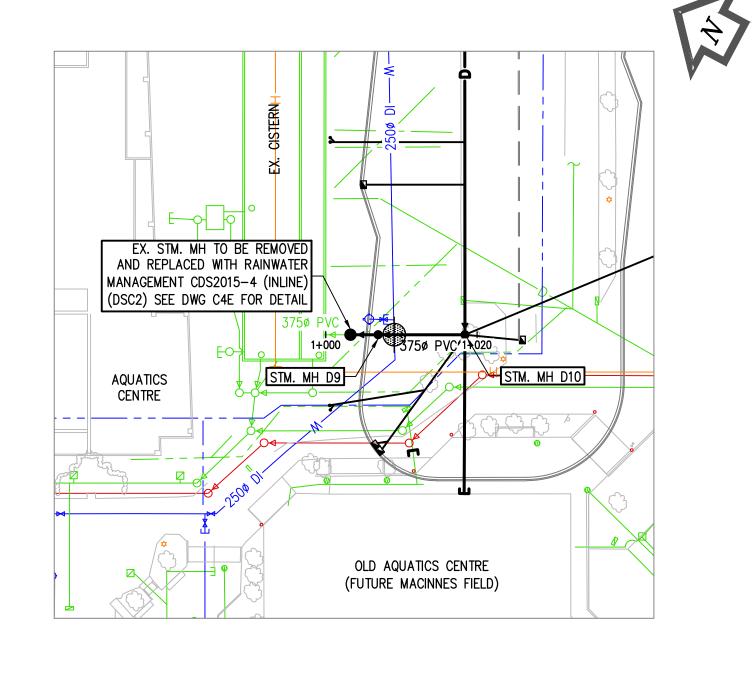





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GRAPHIC SCALE

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SCALE: 1:500

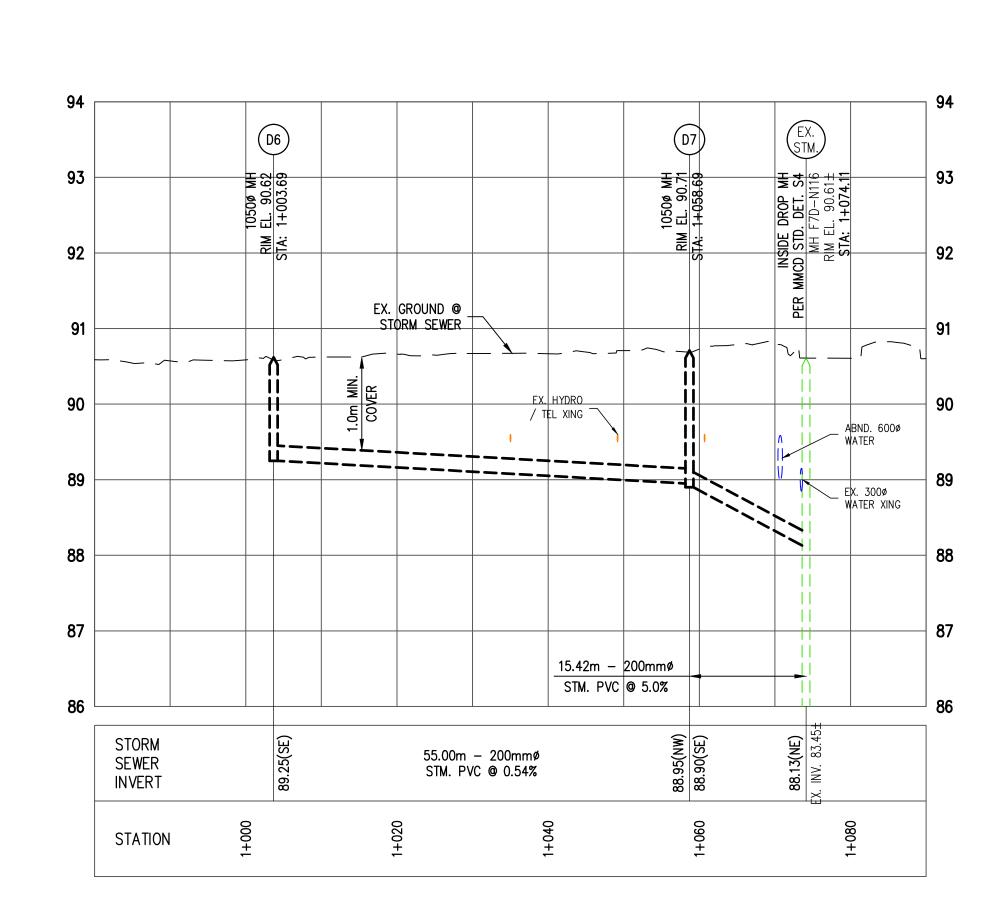
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Civil Design
UTILITIES - PLAN/PROFILE
STORM SEWER
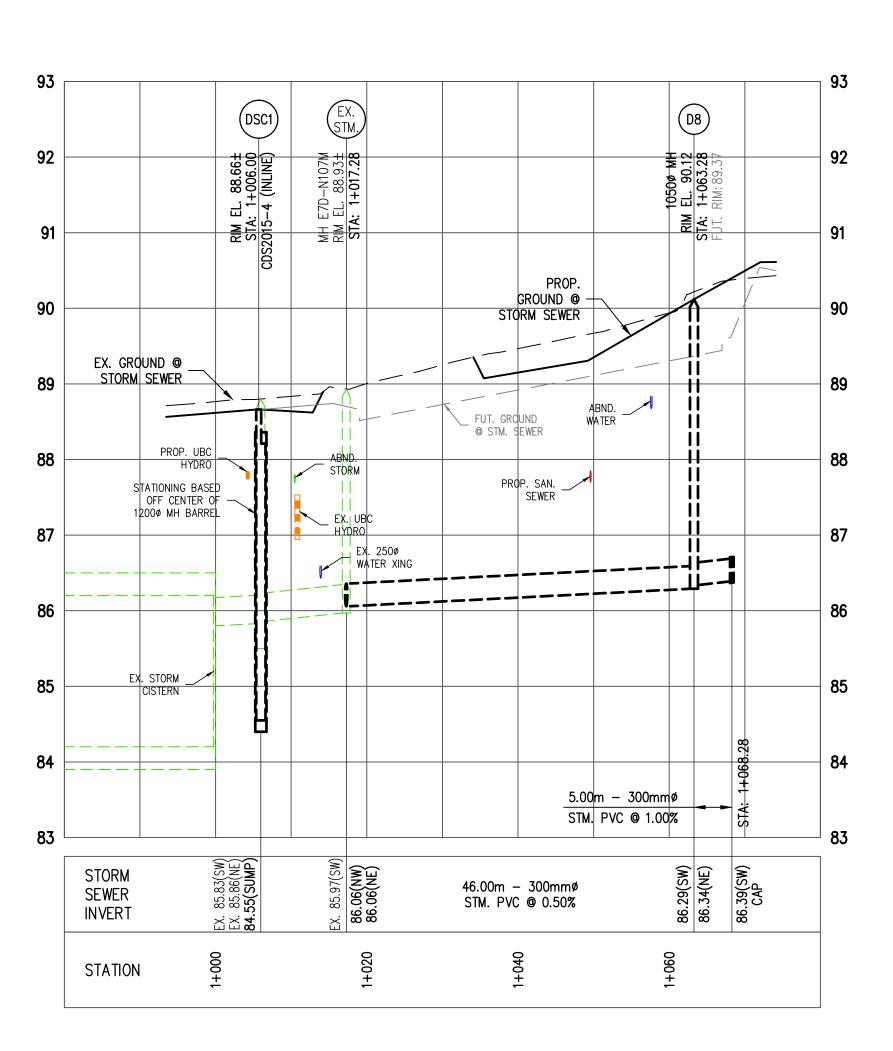
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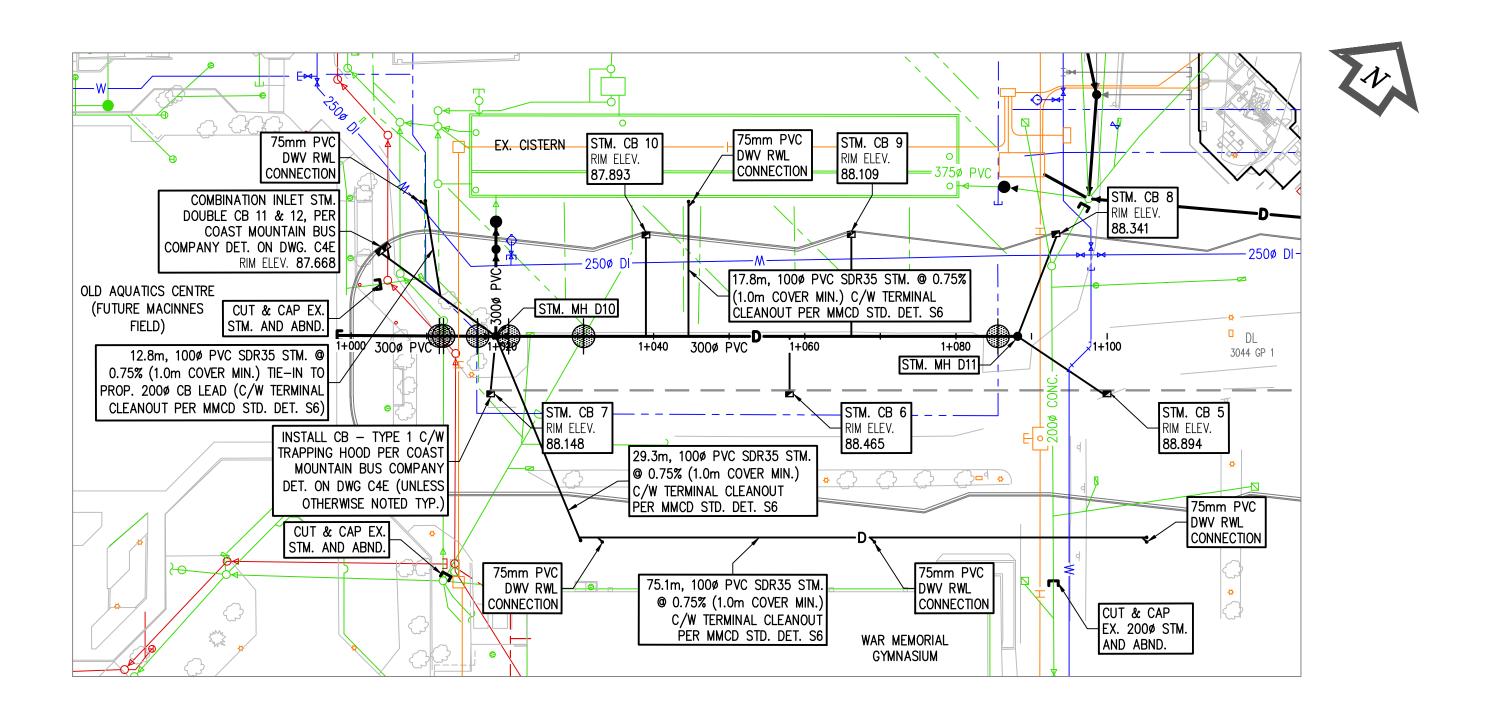
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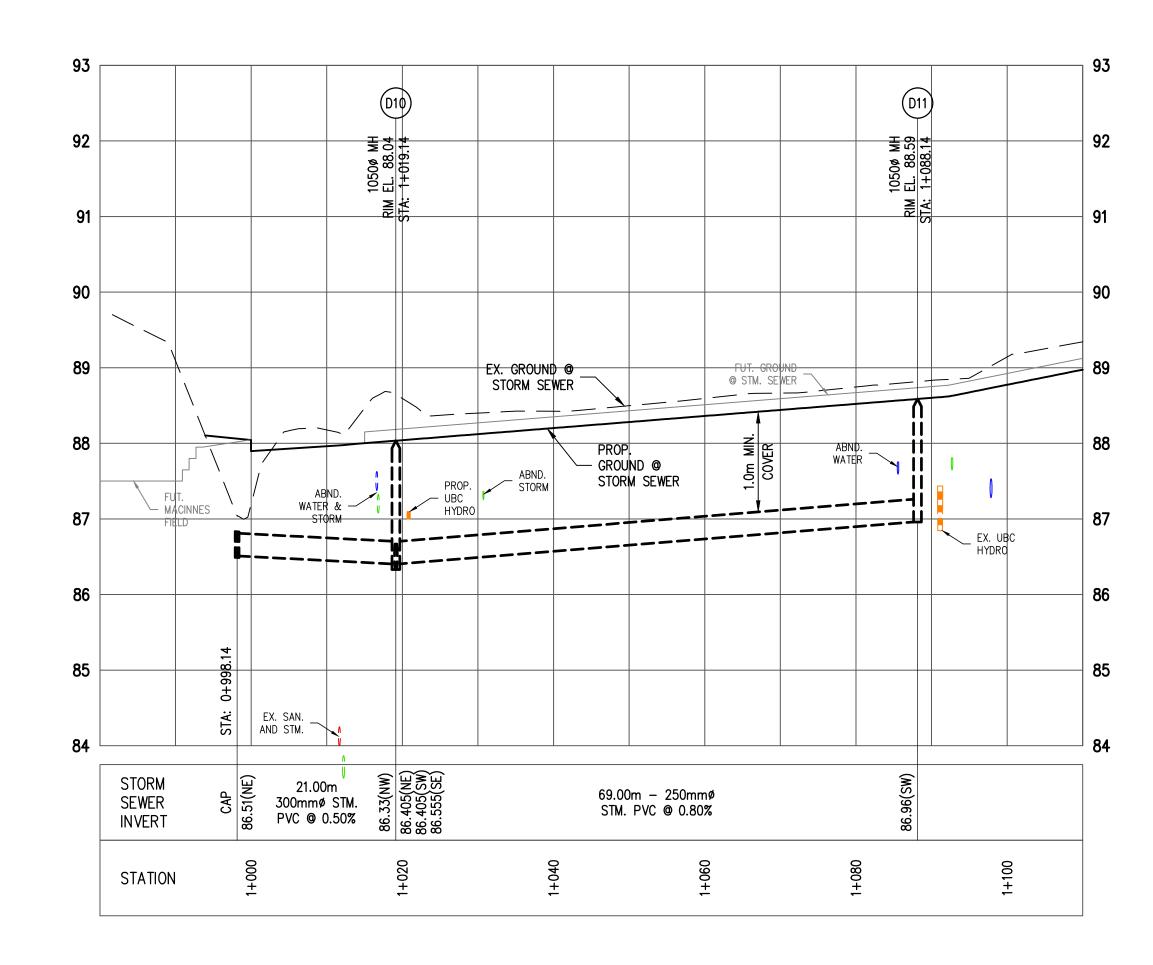


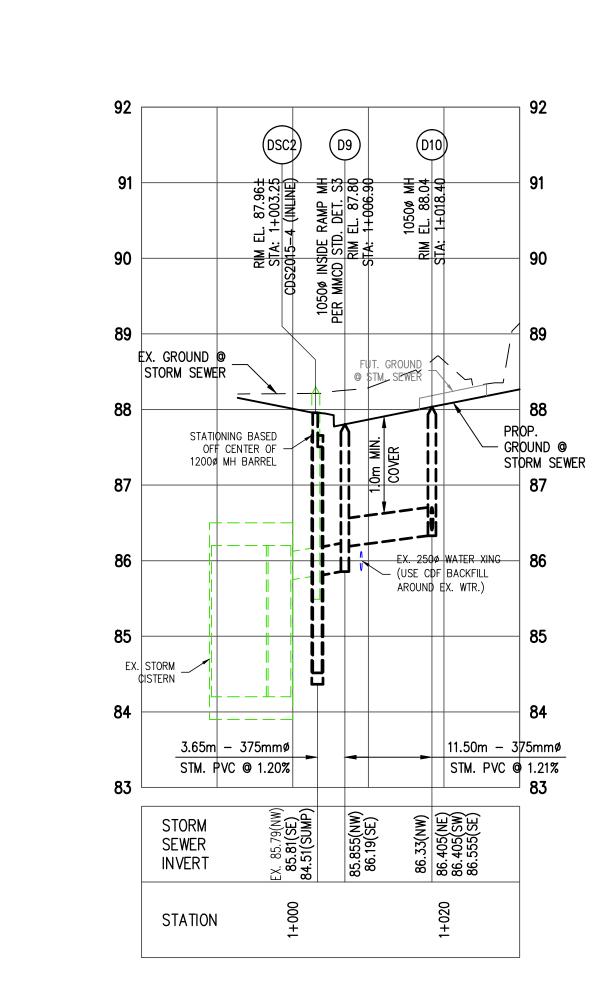
GENERAL NOTES:


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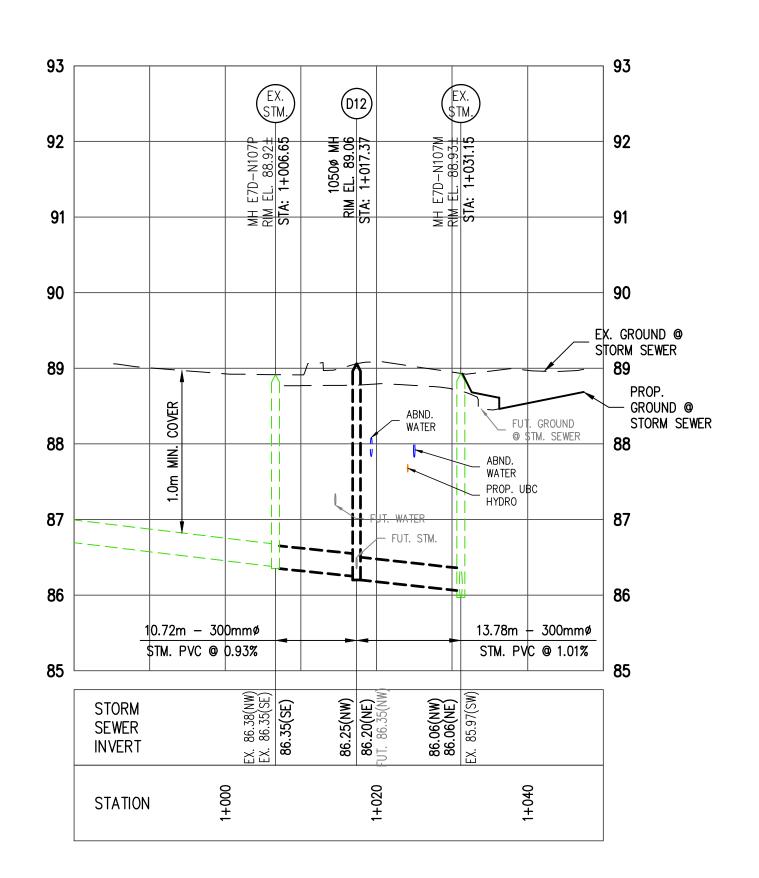
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GRAPHIC SCALE

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SCALE: 1:500

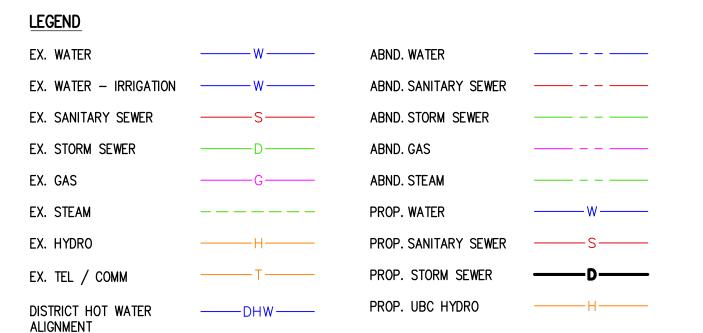SEAL

UBC Gage South

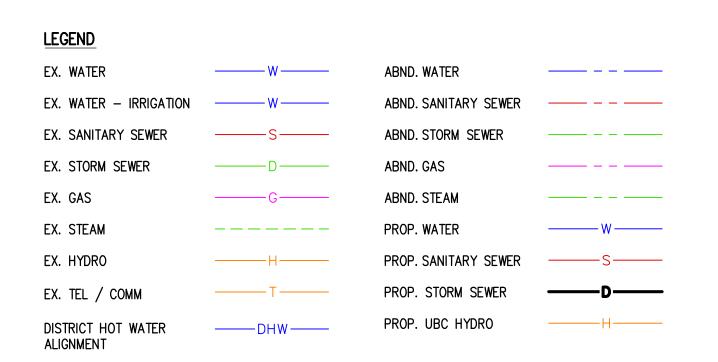PHASE 1 UNDERGROUND WORKS

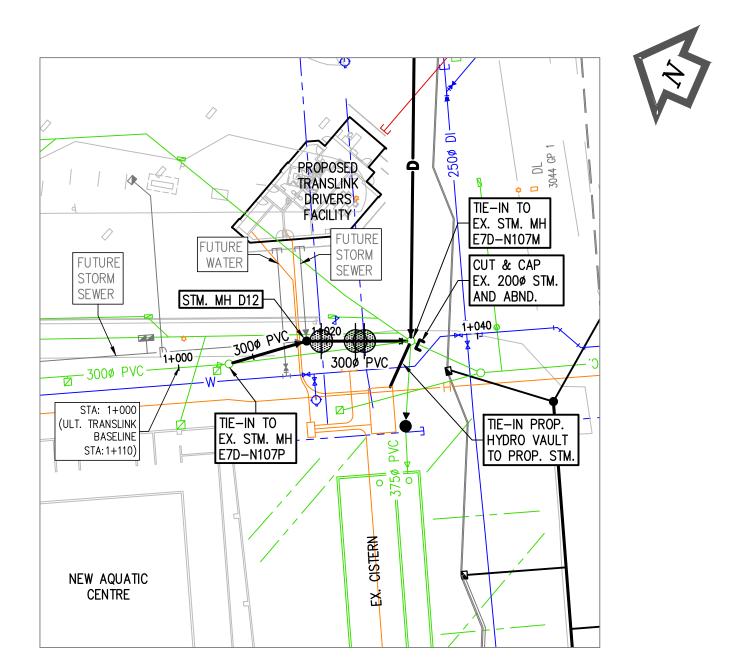Civil Design
UTILITIES - PLAN/PROFILE
STORM SEWER


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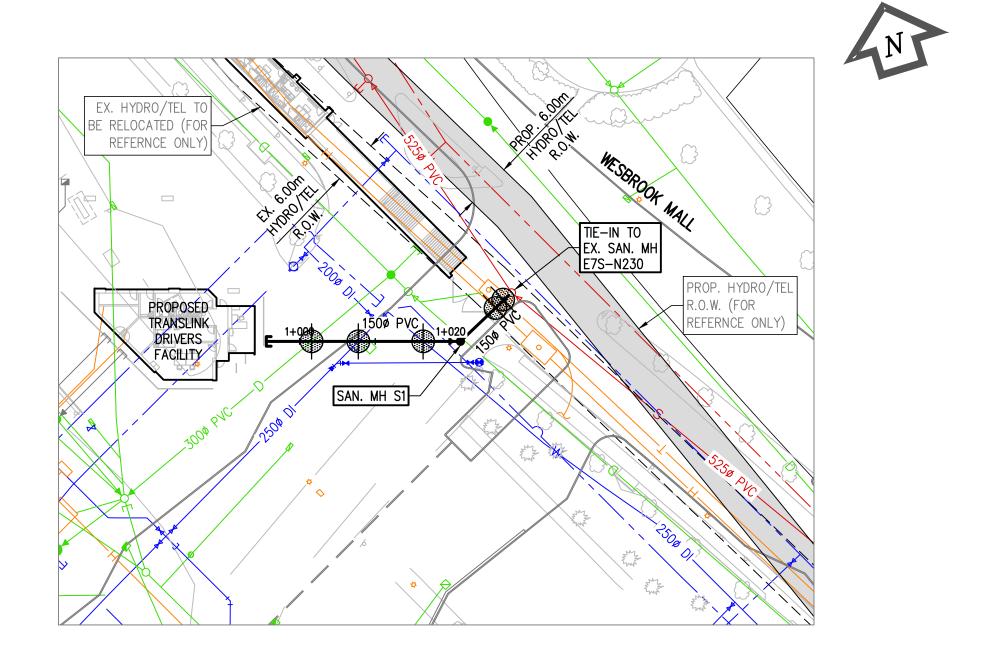
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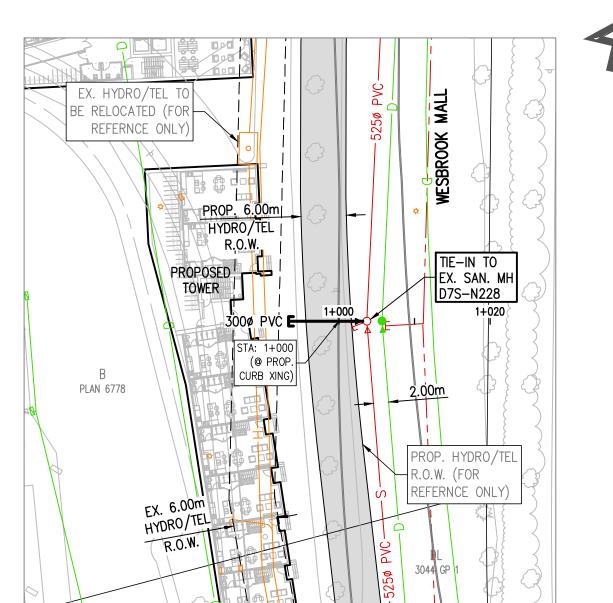
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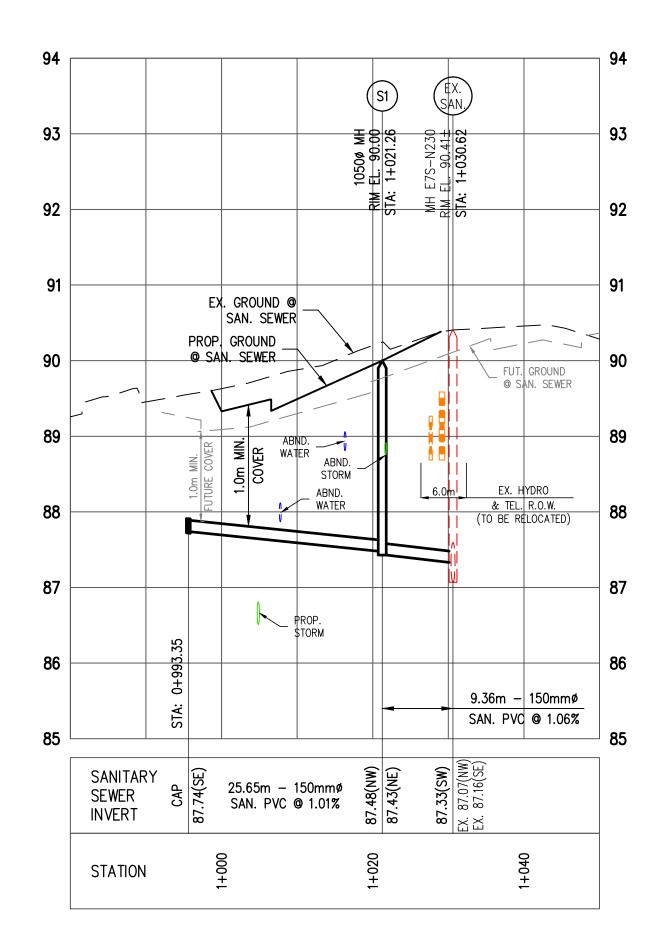
CORE-1773


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<u>LEGEND</u>	
EX. WATER	——— W ———
EX. WATER - IRRIGATION	
EX. SANITARY SEWER	——————————————————————————————————————
EX. STORM SEWER	D
EX. GAS	——— G———
EX. STEAM	
EX. HYDRO	———Н———
EX. TEL / COMM	T
DISTRICT HOT WATER ALIGNMENT	——DHW——
ABND. WATER	
ABND. SANITARY SEWER	
ABND. STORM SEWER	
ABND. GAS	
ABND. STEAM	
PROP. WATER	——— w ———
PROP. SANITARY SEWER	——s—
PROP. STORM SEWER	D
PROP. UBC HYDRO	———Н———

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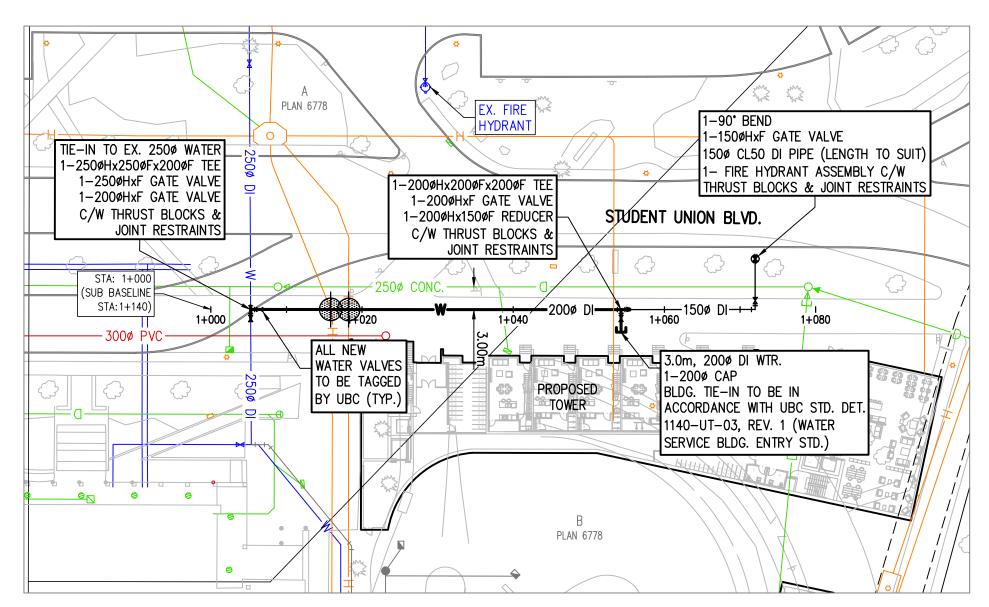
PHASE 1 **UNDERGROUND WORKS**


Civil Design UTILITIES - PLAN/PROFILE SANITARY SEWER


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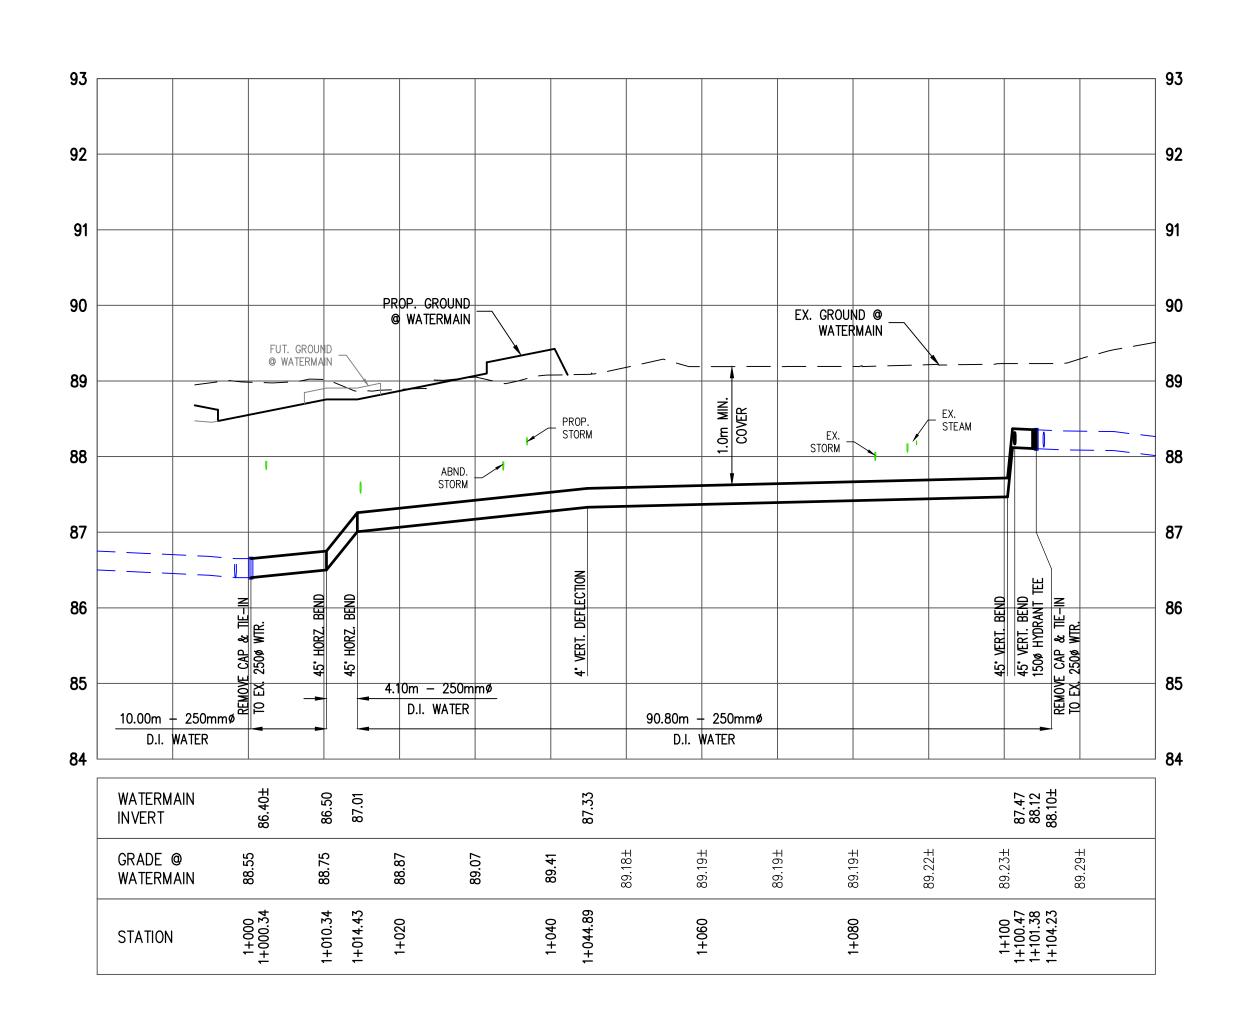
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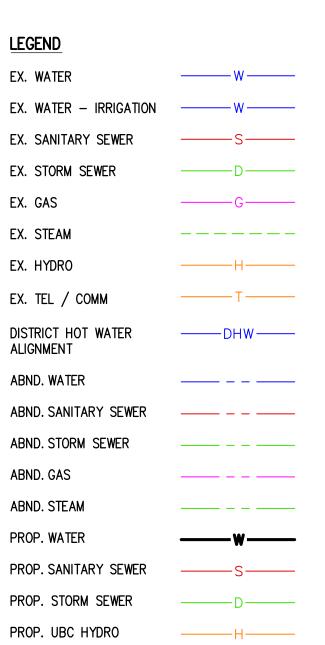


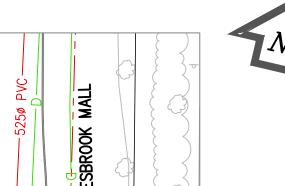

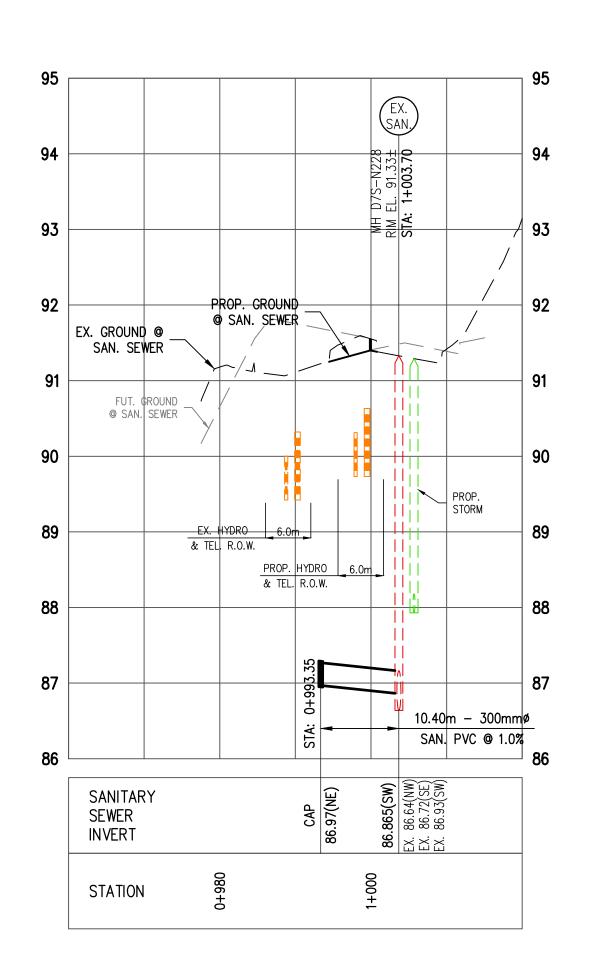




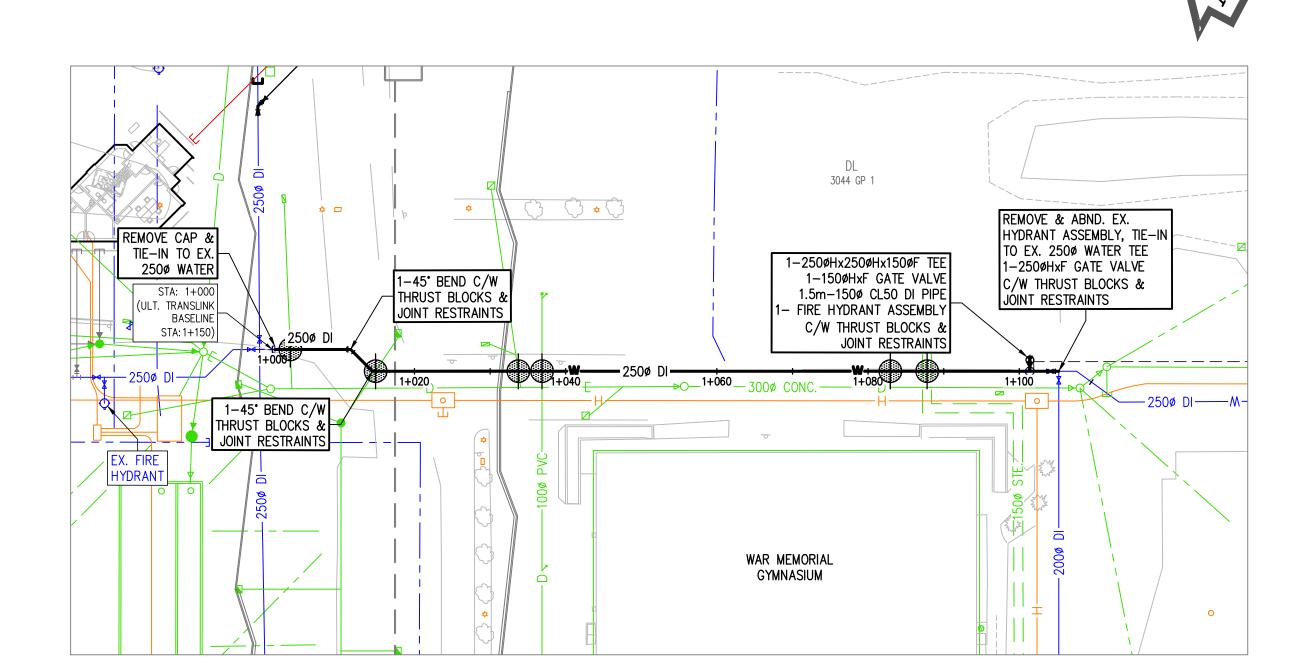

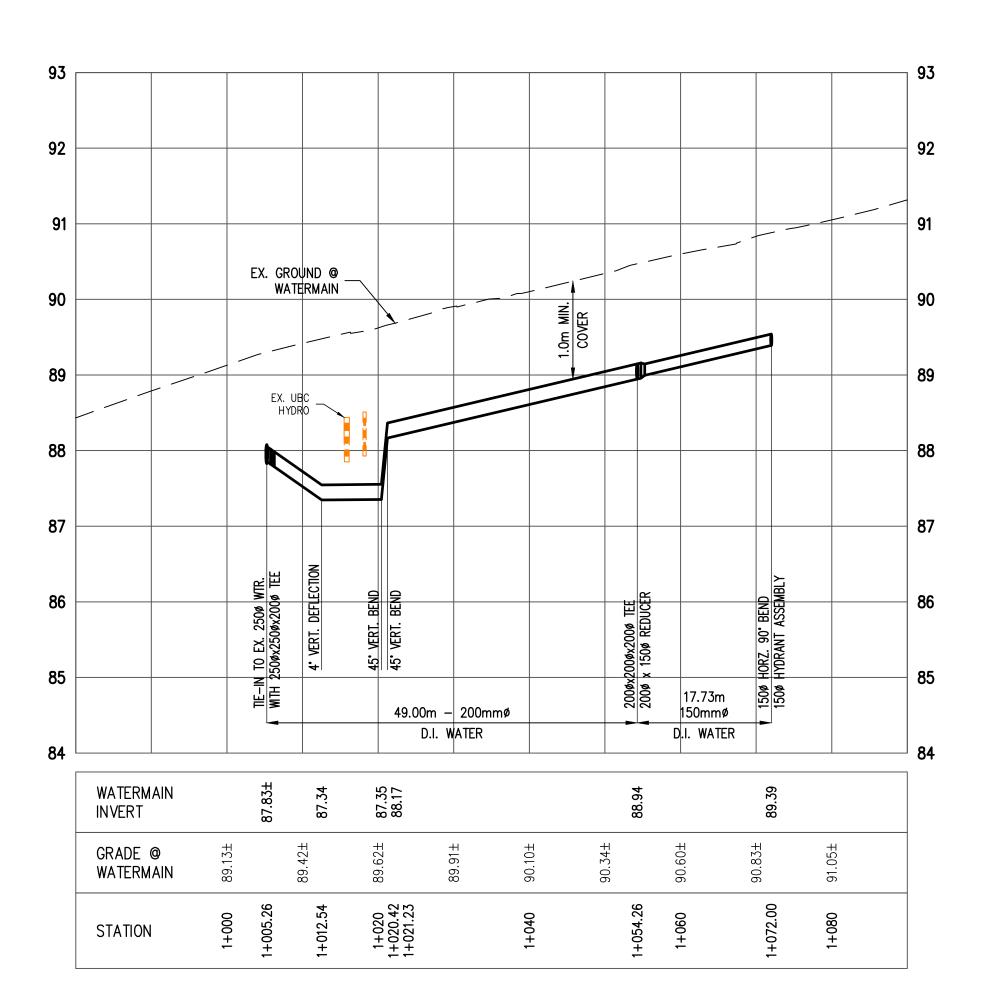

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- 2. UTILITY TRENCH WIDTH VARIES WITH DIAMETER AND DEPTH OF UTILITY PIPE TO BE INSTALLED. MINIMUM WIDTH TYPICALLY 600mm OR AS PER MMCD STD. DET. G4.
- 3. ALL EX. VALVES AND MANHOLES TO BE ADJUSTED TO SUIT NEW GRADES. ADJUSTED EX. WATER VALVES TO BE REPLACED WITH SQUARE ROBAR VALVE BOXES SUPPLIED BY DOBNEY OR APPROVED EQUIVALENT, VALVE # TO BE MARKED WITH GREASE PEN.
- 4. COORDINATE ALL EXCAVATIONS CLOSE TO BUILDING WITH SHORING PLANS BY GEOTECH.
- 5. CALL BC ONE-CALL 24 HOURS PRIOR TO CONSTRUCTION.
- 6. TOPOGRAPHIC SURVEY FOR THIS SITE PROVIDED BY MURRAY AND ASSOCIATES LAND SURVEYORS.
- 7. THESE DRAWINGS TO BE READ IN CONJUNCTION WITH OTHER CIVIL AND OTHER DISCIPLINE'S DRAWINGS.

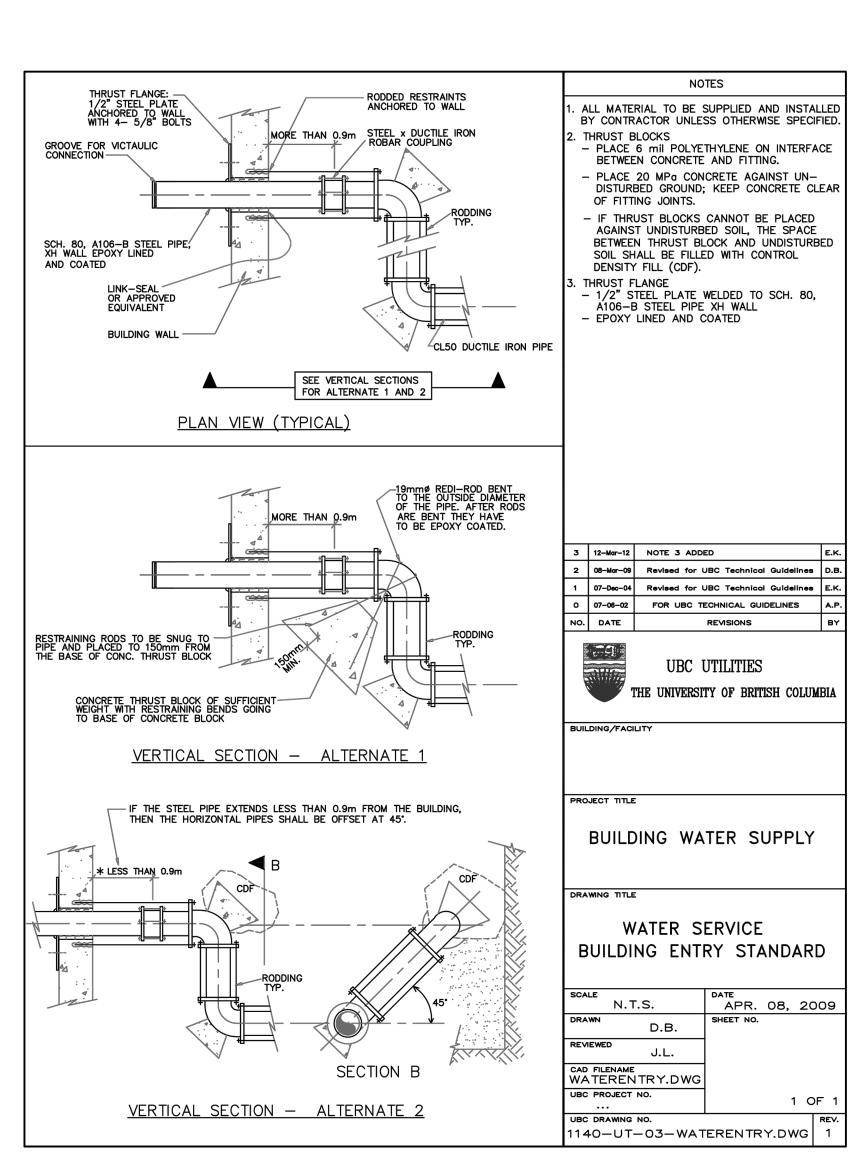

INFORMATION ON EXISTING UTILITIES MAY NOT BE COMPLETED OR ACCURATE. PRIOR TO CONSTRUCTION CONTRACTOR SHALL EXPOSE LOCATIONS OF ALL EXISTING UTILITIES AND ADVISE THE ENGINEER OF POTENTIAL CONFLICTS.

DIALOG®

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tel. (604)299 0605 fax. (604)299 0629

ISSUED FOR

1 / 2016-03-30 / SLP SUBMISSION 2 / 2016-04-26 / SLP - PHASE 1_UNDERGROUND

METRIC

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GRAPHIC SCALE

-10 0 10 20

SCALE: 1:500

UBC Gage South


PHASE 1 UNDERGROUND WORKS

Civil Design
UTILITIES - PLAN/PROFILE
WATER WORKS

CHECKED: CN

DRAWN: BC

C 27E

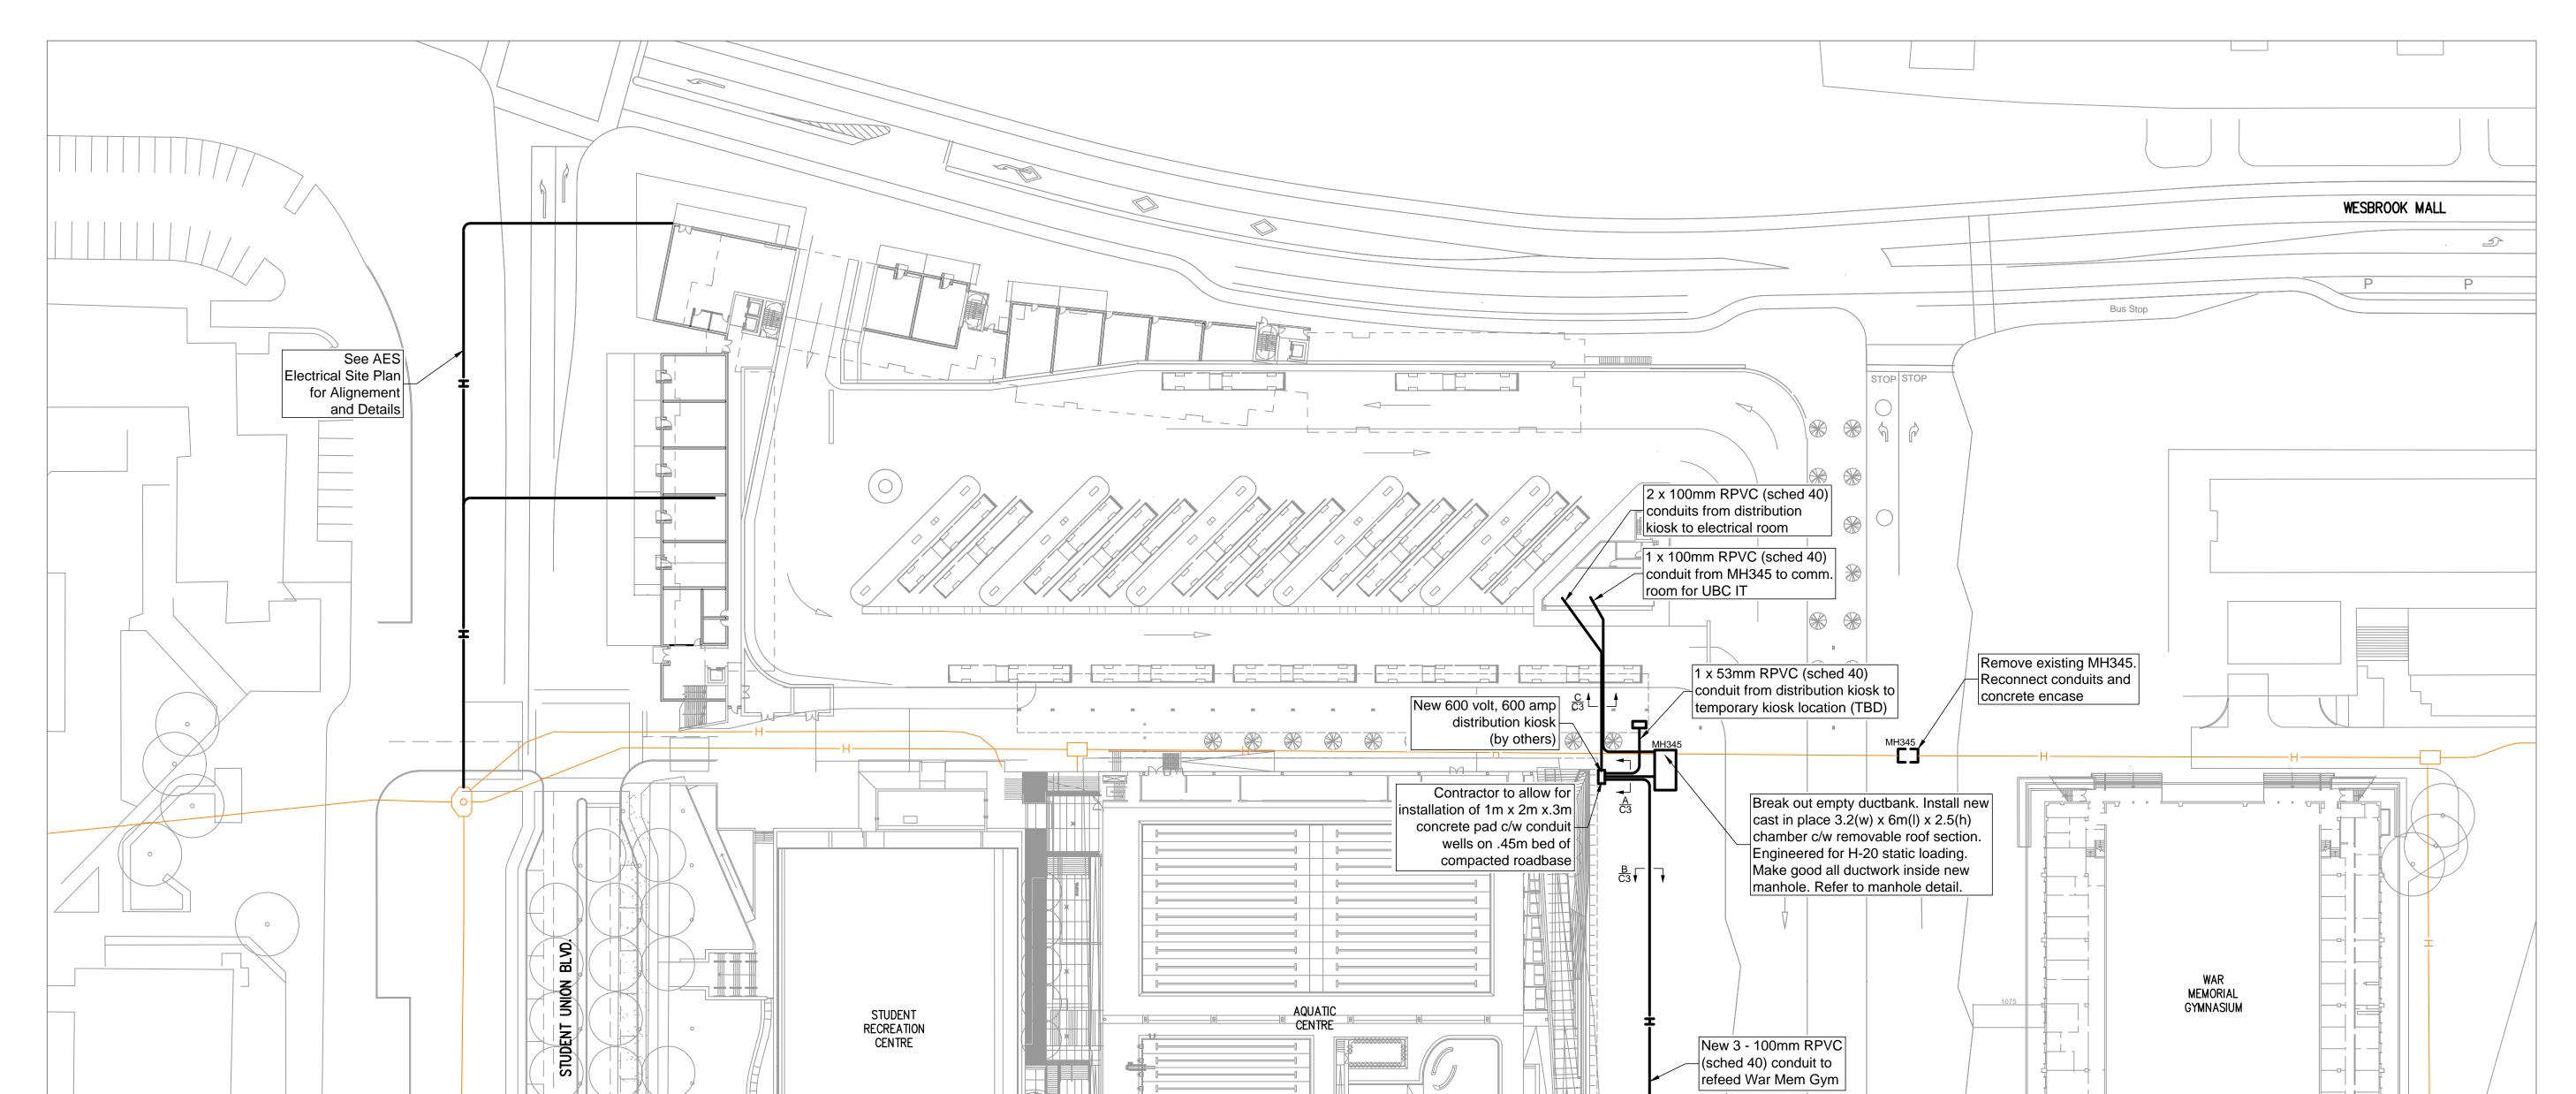






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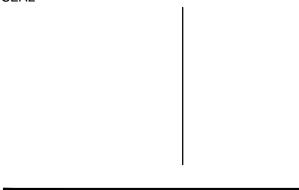
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UBC Gage South

PHASE 1 UNDERGROUND WORKS


Civil Design ELECTRICAL SITE SERVICING PLAN


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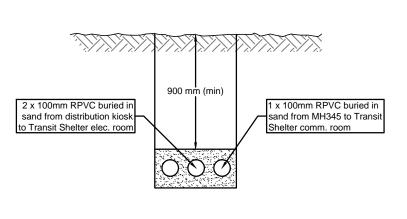


CORE-1773

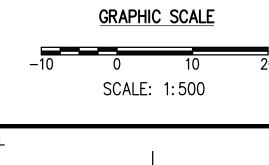OR ACCURATE. PRIOR TO CONSTRUCTION CONTRACTOR SHALL EXPOSE LOCATIONS OF ALL EXISTING UTILITIES AND ADVISE THE ENGINEER OF POTENTIAL CONFLICTS.



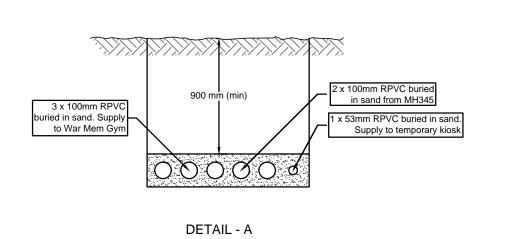

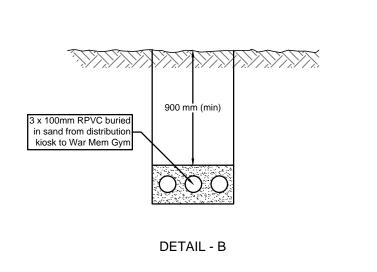

DETAIL - C

New 1.5m junction box

New 1.5m junction box

GENERAL NOTES:

- DRAWINGS ARE FOR REFERENCE PURPOSES ONLY.
 UBC CANNOT GUARANTEE ACCURACY OF SERVICE
 LOCATIONS. CONTRACTOR SHALL VERIFY BY SITE
 SURVEY, VACUUM EXCAVATION, HAND DIGGING OR
 OTHER NON-INVASIVE METHODS.
- CALL BC ONE—CALL 24 HOURS PRIOR TO CONSTRUCTION.
- 3. THESE DRAWINGS TO BE READ IN CONJUNCTION WITH OTHER CIVIL AND OTHER DISCIPLINE'S DRAWINGS.

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