


REFERENCE NOTES SCHEDULE

SYMBOL	EXISTING DESCRIPTION
	TREE-REMOVED
	TREE-EXISTING
SYMBOL	EXISTING DESCRIPTION
	EXISTING CONCRETE PAVERS TO REMAIN
	EXISTING PLANTING TO REMAIN
	EXISTING CIP CONCRETE PAVING TO REMAIN
SYMBOL	HARDSCAPING DESCRIPTION
	CIP CONCRETE BAND
	NEW CONCRETE (BROOM FINISH)
	EXISTING CONCRETE WALL TO REMAIN
SYMBOL	DESCRIPTION
	PLANTING BED
SYMBOL	DESCRIPTION
	TRENCH DRAIN
SYMBOL	HARDSCAPING DESCRIPTION
	RIVER ROCK SURFACING

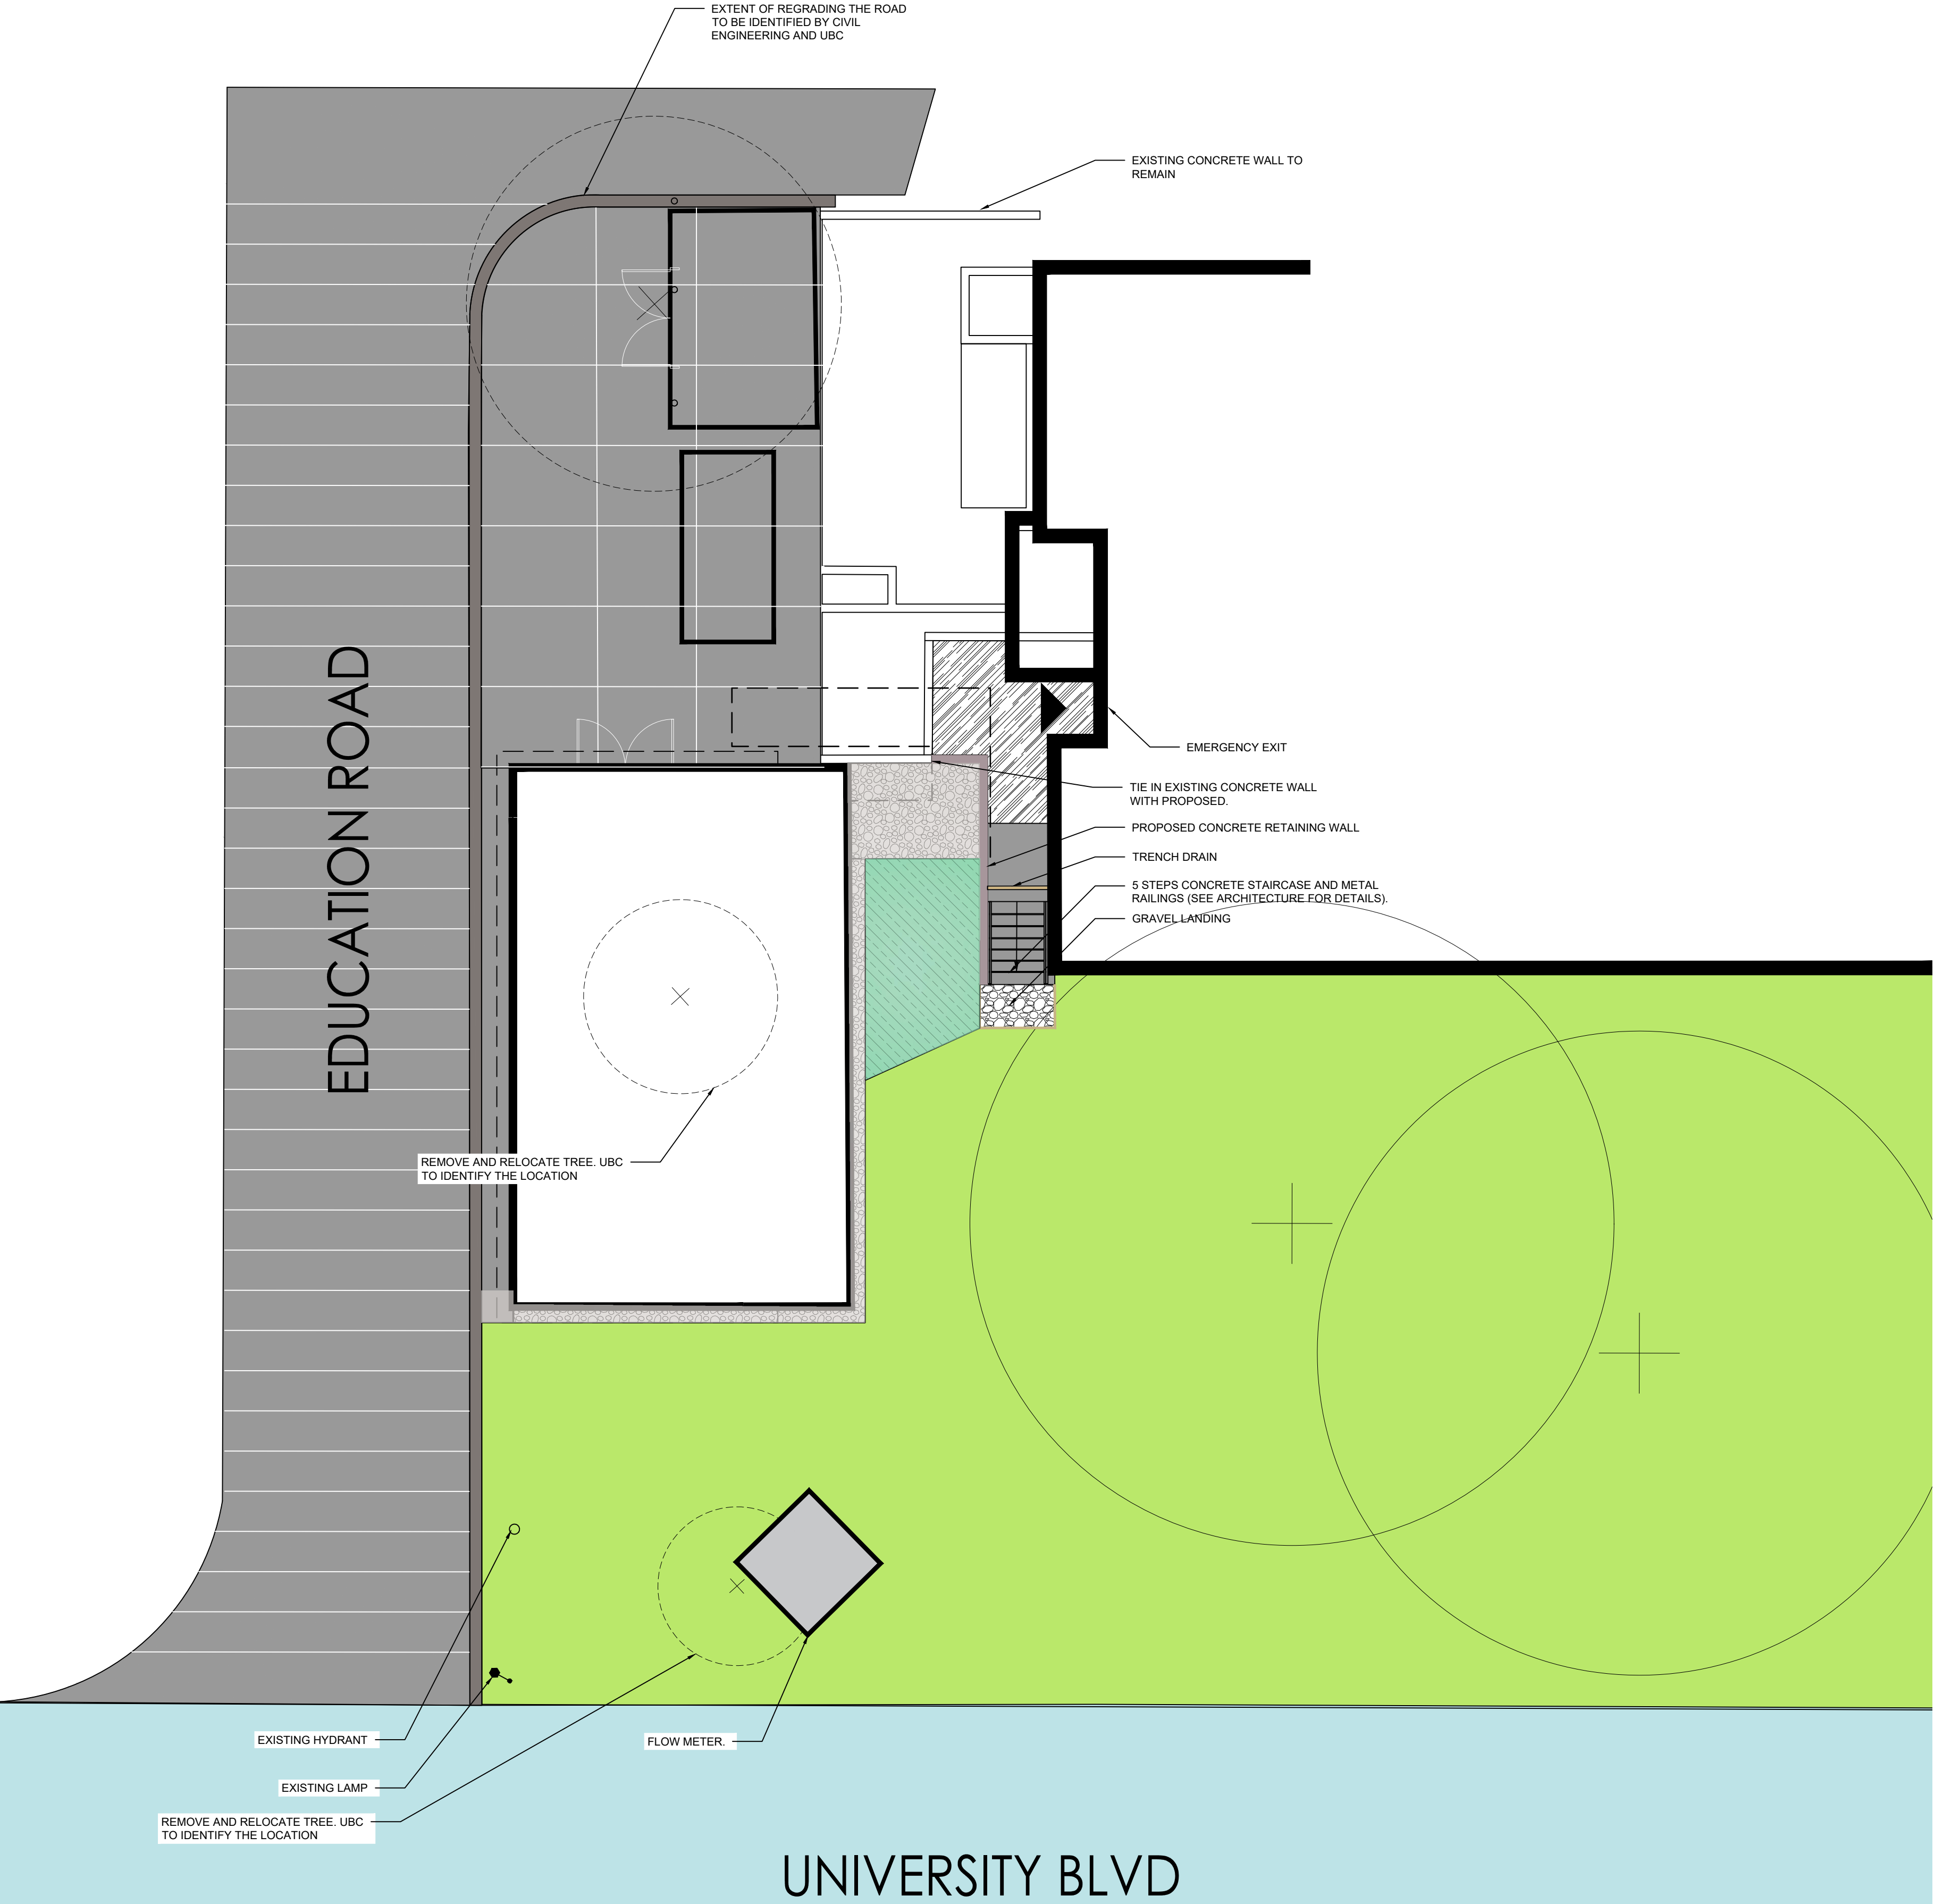

1	ISSUED FOR PRELIMINARY	WGS	ED	2019.09.08
2	Revision	By	Appd	YYYY.MM.DD
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Permit/Seal

**PRELIMINARY
NOT FOR
CONSTRUCTION**

Not for permits, pricing or other official purposes. This document has not been completed or checked and is for general information or comment only.



Client/Project

UBC Pump House


Title
LANDSCAPE LAYOUT PLAN

Project No. 5618454	Scale 1 : 100
Revision	Drawing No. L-101

The Contractor shall verify and be responsible for all dimensions. DO NOT scale the drawing - any errors or omissions shall be reported to Stantec without delay. The Copyrights to all designs and drawings are the property of Stantec. Reproduction or use for any purpose other than that authorized by Stantec is forbidden.

Notes

CODE	DESCRIPTION
← 1:1	SLOPE
× 00.0	BOTTOM OF STEP (BS)
× 05.0	BOTTOM OF WALL (BW)
× 00.0	EXISTING ELEVATION (EX)
× EX	FIRST FLOOR ELEV. (FFE)
× 00.0	FLOOR GROUND (FG)
× 00.0	FLOOR GROUND (FG)
× 05.0	INVERT ELEVATION (INV.)
× INV	LOW POINT (LP)
× 00.0	LOW POINT (LP)
× 05.0	TOP OF STEP (TS)
× 00.0	TOP OF STEP (TS)
× 05.0	TOP OF WALL (TW)
× TW	TOP OF WALL (TW)

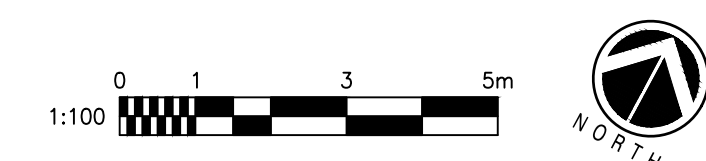

UNIVERSITY BLVD



UBC Pump House

Title

GRADING PLAN

Project No.
115618454

Revision
1

Scale
1 : 100
Drawing No.
L-201

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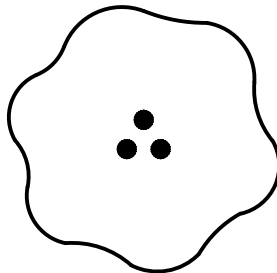
The Contractor shall verify and be responsible for all dimensions. DO NOT scale the drawing - any errors or omissions shall be reported to Stantec without delay.
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Consultant

Notes

PLANT SCHEDULE

TREES	CODE	QTY	BOTANICAL / COMMON NAME	SIZE	DETAIL
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AA 1 AMELANCHIER 'AUTUMN BRILLIANCE' / AUTUMN BRILLIANCE SERVICEBERRY MULTISTEM

SHRUBS




LP 7 LONICERA PILEATA / PRIVET HONEYSUCKLE #3 POT



BB 13 RHODODENDRON 'BADEN BADEN' / BADEN BADEN RHODODENDRON #3 POT

GROUND COVERS

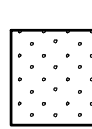

S 185.8 m² SODDED LAWN NATIVE MIX/ HYDROSEED

SPACING

DETAIL

EDUCATION ROAD

TREE TO BE RELOCATED.
UBC TO IDENTIFY LOCATION.

UNIVERSITY BLVD

0 1 3 5m
1:100



Client/Project Logo



Client/Project

UBC Pump House

Title

GRADING PLAN

Project No.
115618454

Revision
1

Scale
1 : 100

Drawing No.

L-301