SPECIFICATIONS

1. GENERAL CONDITIONS


1.1 REFER TO DIVISION 1 SPECIFICATIONS.


2. POWER AND LIGHTING WIRING

- USE ONLY THE SPECIFIC EQUIPMENT NAMED IN THE TENDER DOCUMENTS FOR THIS CONTRACT, OR AN APPROVED SUBSTITUTE. THE DESIGN IS BASED ON THE FIRST NAMED EQUIPMENT AND ANY ADDITIONAL COSTS REQUIRED FOR THE USE OF ALTERNATIVES SHALL BE INCLUDED IN THE TENDER. SUBSTITUTIONS MADE TO THE CONTRARY WILL BE REJECTED OUTRIGHT UNLESS WRITTEN AUTHORITY IS OBTAINED FROM THE CONSULTANT PRIOR TO THE PURCHASE OF SUCH EQUIPMENT. SUBSTITUTIONS FOR NAMED MATERIAL MAY BE USED ONLY IF APPROVED BY THE CONSULTANT IN WRITING.
- 2.2 ALL EQUIPMENT TO BE ADEQUATELY SUPPORTED FROM BUILDING STRUCTURAL MEMBERS. WHERE POSSIBLE USE CAST IN CONCRETE INSERTS; OTHERWISE DRILLED METAL INSERTS. WHERE WOOD SCREWS ARE USED, THEY MUST PENETRATE AT LEAST 25MM (1"), EXCEPT IN COUNTERS. PERFORATED PIPE HANGER IRONS SHALL NOT BE USED. OBTAIN THE SERVICES OF A SEISMIC CONSULTANT TO ENSURE ALL SUPPORT METHODS COMPLY WITH LOCAL CODE REQUIREMENTS.
- 2.3 IDENTIFY ALL ELECTRICAL DEVICES, PANELBOARDS, STARTERS, CONTROLLERS, FEEDERS, SWITCHES, ETC. PROVIDE TYPEWRITTEN, REMOVABLE PANELBOARD CIRCUIT DIRECTORIES. USE "LAMICOID" LABELS TO IDENTIFY EQUIPMENT. USE BLACK-ON-CLEAR "BROTHER" STYLE LABEL SHOWING CIRCUIT NUMBER ON COVERPLATE OF ALL RECEPTACLES.
- 2.4 PROVIDE OR ARRANGE FOR ALL CUTTING, PATCHING, FLASHING, SLEEVING, ETC.
 ALL DRILLING AND CORING IN EXISTING WALLS/SLABS SHALL BE RESTORED TO ORIGINAL FIRE PROOF RATING WITH APPROVED FIRE PROOF COMPOUND.
 ALL DAMAGED SURFACES SHALL BE RE—FINISHED TO ORIGINAL CONDITIONS.
- 2.5 COORDINATE THE DISCONNECTION AND REMOVAL OF THE EXISTING DISTRIBUTION EQUIPMENT INCLUDING EXTENSION OF FEEDERS AND BRANCH CIRCUITING TO SUIT THE NEW EQUIPMENT ARRANGEMENT
- 2.6 COORDINATE FOR ALL SHUTDOWNS TO BE UNDERTAKEN WITH FULL COOPERATION OF THE TENANTS OVER THE WEEKEND AND/OR AFTER NORMAL WORKING HOURS.
- 2.7 THE CONTRACTOR SHALL IDENTIFY EXISTING BRANCH CIRCUITING AND EXTEND TO THE PROPER PANEL FOR TERMINATION.
- 2.8 ALL WIRING TO BE CONCEALED. FEEDERS SHALL BE WIRED IN CONDUIT. BRANCH WIRING SHALL BE
- 2.9 CONDUIT BETWEEN MOTOR DISCONNECT SWITCH AND MOTOR TERMINALS SHALL BE FLEXIBLE, WATER TIGHT TYPE.
- 2.10 ALL CONDUCTORS SHALL BE RW90 STRANDED COPPER, NO SMALLER THAN NO. 12 AWG.
- 2.11 COLOUR CODING TO C.S.A STANDARDS.


3. GROUNDING

3.1 PROVIDE EQUIPMENT GROUNDING AND BONDING AS REQUIRED BY LOCAL INSPECTION AUTHORITIES.

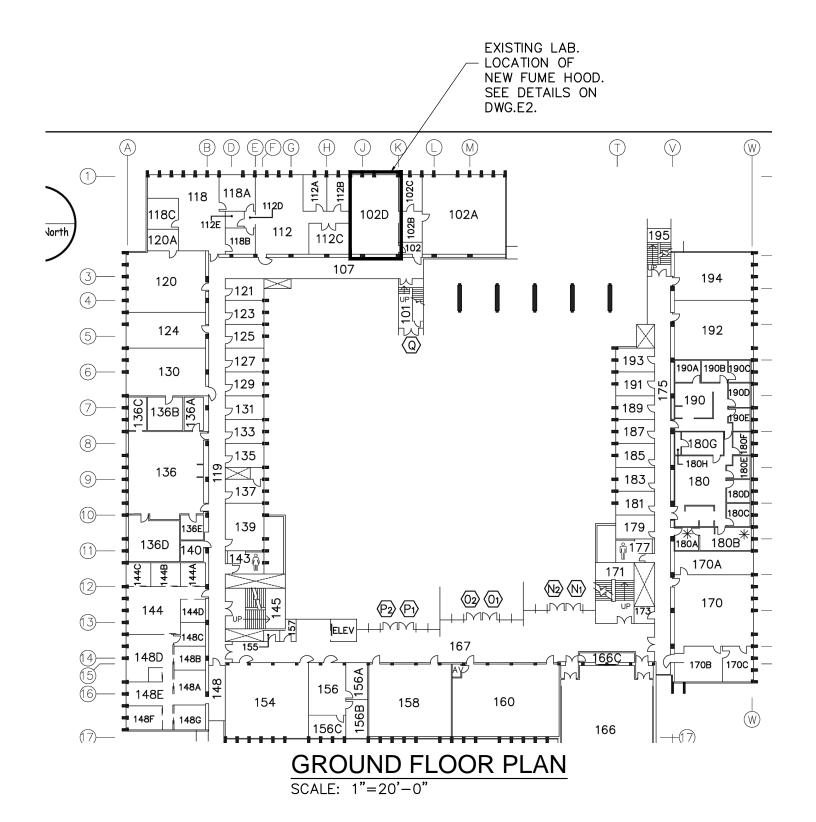

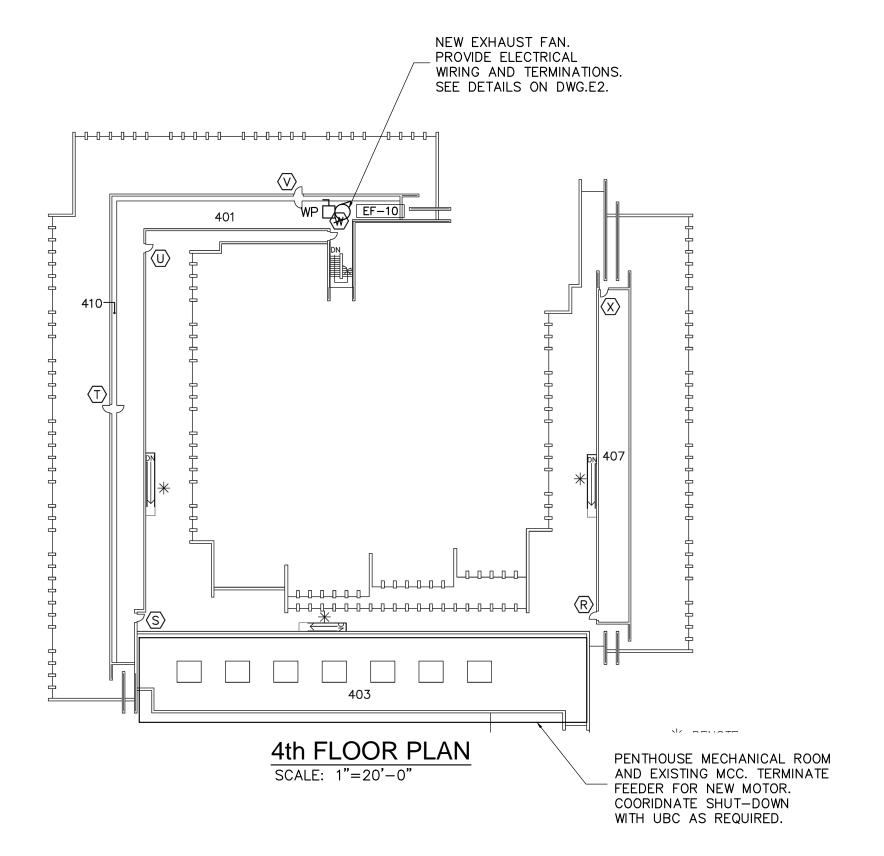



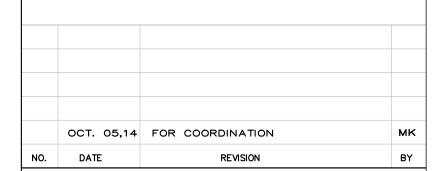

ELECTRICAL CONSULTANT

BLC ENGINEERING INC. Electrical Consultants

Tel: 604-986-4128
Fax: 604-986-4129
mirek@blcengineering.com
41-850 West17th Street
North Vancouver, B.C. V7P 3K4

PPYRIGHT RESERVED. THIS PLAN AND DESIGN IS AND AT ALL TIMES REMAINS THE EXCLUSIVE PROPERTY OF THE UBC PLANT OPERATIONS, LBS PROJECT SERVICES — DESIGN OFFICE DEPARTMENT OF THE UNIVERSITY OF RITISH COLUMBIA AND CANNOT BE USED OR REPRODUCED WITHOUT THE EXPRESS CONSENT OF UBC PLANT PERATIONS, LBS PROJECT SERVICES — DESIGN OFFICE

WRITTEN DIMENSIONS SHALL HAVE PRECEDENCE OVER SCALED DIMENSIONS. CONTRACTOR SHALL VERIFY AND BE RESPONSIBLE FOR ALL DIMENSIONS AND CONDITIONS ON THE JOB AND SHALL REQUEST CLARIFICATION OF ERRORS, DISCREPANCIES, OR DOUBTFUL INFORMATION CONTAINED IN CONTRACT DRAWNOS AND DOCUMENTS. FAILURE TO OBTAIN SUCH CLARIFICATION RENDERS THE CONTRACTOR RESPONSIBLE FOR ANY RESULTING IMPROPER WORK AND THE COST OF RECTIFICATION.

CONSULTANT



THE UNIVERSITY OF BRITISH COLUMBIA

MACMILLAN BUILDING 2357 MAIN MALL

FUME HOOD INSTALLATION

DRAWING TITLE

KEY PLANS AND

SPECIFICATIONS

DATE SEP. 2014

DRAWN MK


REVIEWED MK

CAD FILENAME 14124E

UBC PROJECT NO. XXX

UBC DRAWING NO. XX

REV.

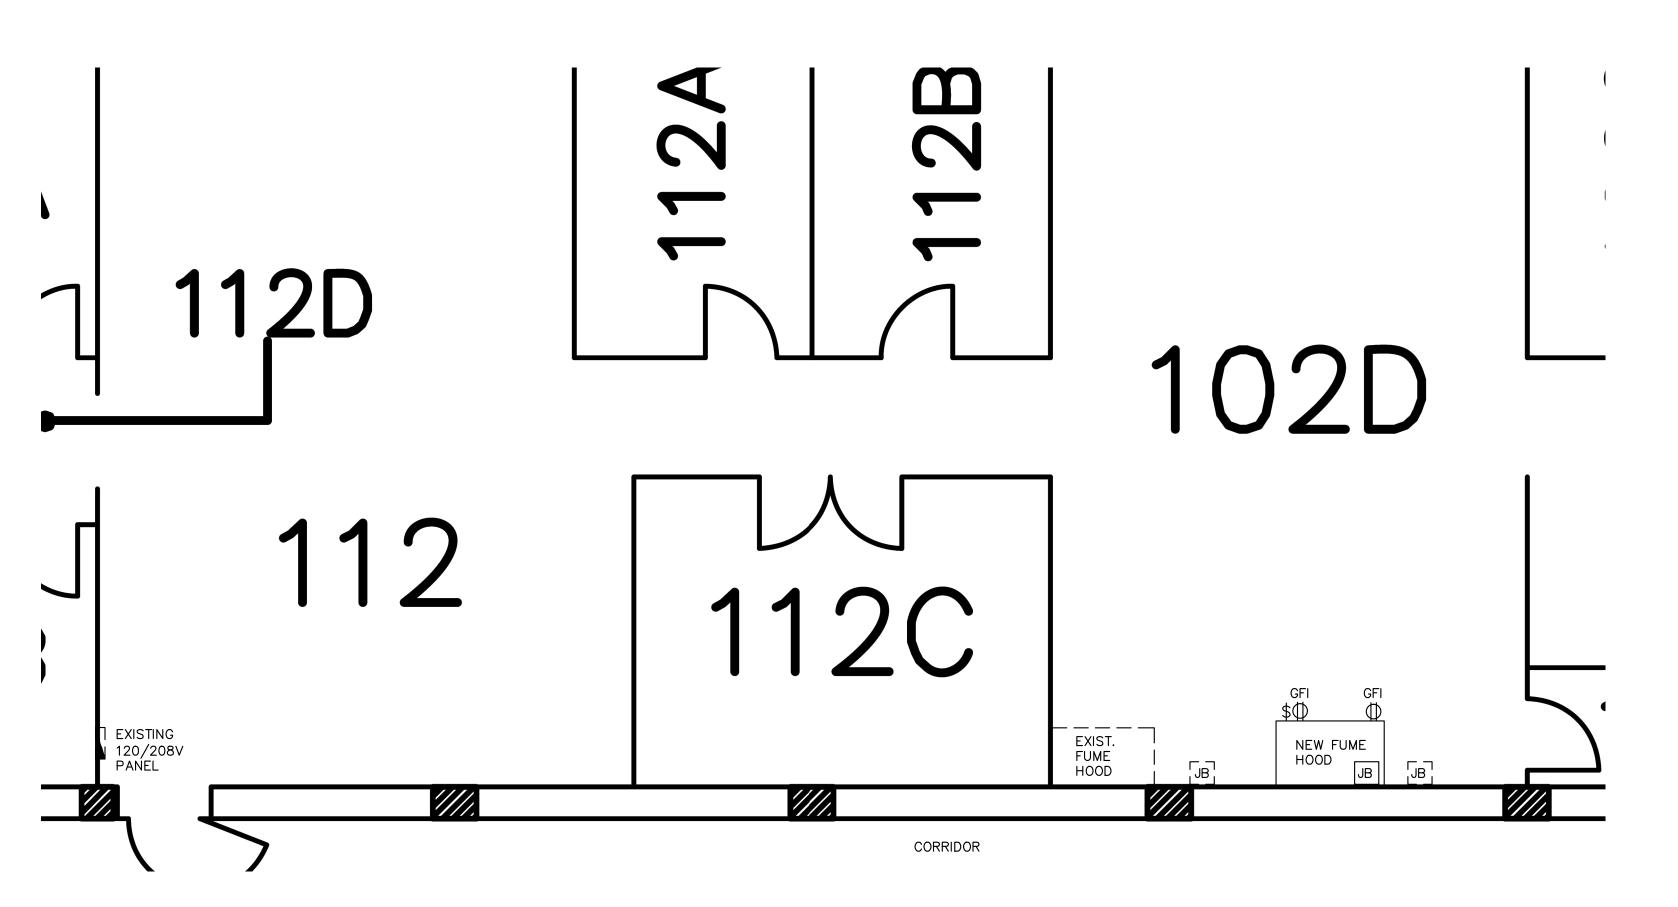

ELECTRICAL PLAN
SCALE: 1/4"=1'-0"


JNIT No.	UNIT DESCRIPTION	LOCATION	LOAD	٧	PH	DISC	CONN	ECT		STA	RTER		PILC	T DE	VICE	BREAKER	FEEDER	NOTES
						SUPPLIED BY:	INSTALLED BY:	WIRING BY:	TYPE	SUPPLIED BY:	INSTALLED BY:	WIRING BY:	SUPPLIED BY:	INSTALLED BY:	WIRING BY:			ELECTRICAL CONTRACTOR TO INSTALL MANUAL ON/OFF SWITCH AT FUME HOOD ENCLOSURE ON GROUND FLOOR AND LOW VOLTAGE WIRING IN ORDER TO CONTROL FAN STARTER. ADDITIONALLY PROVIDE 1/2"CONDIUT FROM MCC CONTROLS TO DDC PANEL.
EF-10	ROOF TOP UNIT	ROOF	1.0HP	208	3	Е	Е	E	MG	М	М	М	Е	Е	Е	3P-15A	3No.12	
M - M C - C		MN — M. VSD— V	ANUAL STA	ARTER PEED D	C/W		T LIG	нт	OA HO <i>A</i>	- - \- :/LO/	OFF/ HAN[RT/ST 'AUT()/OFI	TOP O F/AU	ТО	F	F - FLOV C - TIME T - THEF	SWITCH CLOCK	TCH S — MANUAL SWITCH TS — TAMPER SWITCH TR — REVERSE—ACTING THERMOSTAT D — DEHUMIDSTST DDC—EMS SYSTEM

SYMBOL LEGEND							
Ø	MOTOR						
마	DISCONNECT SWITCH AND EQUIPMENT CONNECTION						
EF-#	MECHANICAL EQUIPMENT LABEL						
\$	CONTROL SWITCH						
\ominus	DUPLEX RECEPTACLE						
	DISTRIBUTION PANEL						
GFI	GFCI PROTECTED DEVICE						



NOTES:

- REMOVE EXISTING 120/208V, SURFACE MOUNTED JUNCTION BOXES AND WIRING. TRIM CONDUITS AT FLOOR LEVEL.
- REUSE 120V CIRCUIT REMOVED FROM ABANDONED JB'S TO SUPPLY ELECTRICAL DEVICES WITHIN NEW FUME HOOD.
- 3. TERMINATE NEW CIRCUIT TO JUNCTION BOX MOUNTED TO TOP OF FUME HOOD.
- INSTALL FAN MOTOR CONTROL SWITCH AS DESCRIBED IN MECHANICAL MOTOR LIST. SWITCH CONDUIT AND WIRING SHOULD FOLLOW MECHANICAL DUCT RISER TO TOP OF BUILDING.

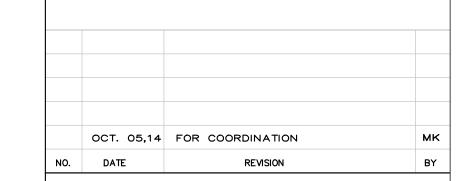

ELECTRICAL CONSULTANT



BLC ENGINEERING INC. Electrical Consultants

Tel: 604-986-4128
Fax: 604-986-4129
mirek@blcengineering.com
41-850 West17th Street
North Vancouver, B.C. V7P 3K4

COPYRIGHT RESERVED. HIS PLAN AND DESIGN IS AND AT ALL TIMES REMAINS THE EXCLUSIVE PROPERTY OF THE USE PLANT OPERATIONS, LBS PROJECT SERVICES — DESIGN OFFICE DEPARTMENT OF THE UNIVERSITY OF BRITISH COLUMBIA AND CANNOT BE USED OR REPRODUCED WITHOUT THE EXPRESS CONSENT OF UBC PLANT OPERATIONS, LBS PROJECT SERVICES — DESIGN OFFICE

BE RESPONSIBLE FOR ALL DIMENSIONS AND CONDITIONS ON THE JOB AND SHALL REQUEST CLARIFICATION ERRORS, DISCREPANCIES, OR DOUBTFUL INFORMATION CONTAINED IN CONTRACT DRAWNOS AND DOCUMEN' FALURE TO OBTAIN SUCH CLARIFICATION RENDERS THE CONTRACTOR RESPONSIBLE FOR ANY RESULTING IMPROPER WORK AND THE COST OF RECTIFICATION.

CONSULTANT

OWNER



THE UNIVERSITY OF BRITISH COLUMBIA

MACMILLAN BUILDING 2357 MAIN MALL

PROJECT TITL

FUME HOOD INSTALLATION

DRAWING TITLE

CONSTRUCTION DETAILS

UBC DRAWING NO. XX

SCALE AS NOTED	SEP. 2014
DRAWN MK	SHEET NO.
REVIEWED MK	ГО
CAD FILENAME 14124E	LZ of 2
UBC PROJECT NO.	

REV.