DESIGN RATIONALE

The Ponderosa Commons will be the first of several mixed-use student housing developments to be built on the University of British Columbia (UBC) campus. The design of the Ponderosa Commons reflects UBC's vision to create vibrant centers that will animate the campus core and create a sense of place. Located between West Mall and Lower Mall, the three buildings that comprise the Ponderosa Commons are an ensemble of public and academic programmed podiums along University Boulevard, with a residential tower component set back. Together, they create an urban landmark at the terminus of University Boulevard and serve as a gateway when approaching the campus from Marine Drive. Every aspect of the design balances the complexity of the mixed-use nature of the buildings with the need for clarity in understanding the various components of the project. Design strategies using massing, materials, colour, and integrated public-realm spaces strengthen the legibility of the campus design by providing a landmark at an urban level and at a pedestrian level offering wellconsidered hierarchies of spaces that assist users in quickly identifying and navigating through the project.

Massing, Height and Scale:

Phase 2 continues the massing approach of Phase 1 which reinforces the existing campus pattern of blocks defining the public space on University Boulevard, West and Lower Malls. During the design development of Phase 1 extensive sightline studies were performed to ensure the character of the shore area and views from Wreck beach is maintained and this similarly informed the massing of Phase 2. Due to the high density of Phase 2, studies were conducted in order to minimize its impact on the public realm e.g. the height and notched profile of the Phase 2 podium is designed to bring sunlight into the adjacent courtyard in order to maximize natural light into the lower academic levels.

Material Palette:

The project spans both the Campus Core and Forest Edge districts of the campus as described in the Campus Plan. Phase 1 East, in the former zone, is clad in white precast panels patterned to reference the white brick cladding of the early modernist and contemporary buildings on campus. Phase 1 West and Phase 2 are located in the Forest Edge zone and are clad in white and light-charcoal precast panels.

The use of colour is strategically applied to the project to achieve UBC's goal for animation, the need for identity as a landmark on campus and at a local level as a means of way-finding and navigation. Phase 1 East introduces a playful palette of coloured glass panels on the façade of the Department of Art History, Visual Art and Theory (AHVA) component of the building which distinguishes the AHVA studios from the residential housing block behind. In Phase 1 West, vertical glass in hues of green indicate the public interior corridor adjacent to University Boulevard with orange glass highlighting primary entrances along the façade in order to more easily facilitate entry on the long façade. The Phase 2 podium employs colour in a similar strategy, using accent colours and materials on the soffits to visually breakup the building mass and highlight opportunities for entry and gathering. The Phase 2 tower has a graphic facade similar to that of Phase 1, maintaining a common identity across the three buildings.

Public Realm:

In common with the Phase 1 buildings, Phase 2 is highly transparent, permeable and animated at grade. The Phase 2 breezeway is an extension of the Phase 1 West breezeway, providing a pedestrian connection between the two courtyards, passing through the center of the University Boulevard plaza. The breezeway is articulated by drawing the lower façade of the collegium in on a gentle angle. This gesture towards the Scarfe building is meant to create a connection between the two homes of the Faculty of Education. By drawing the lower façade into the building the main entry to the education department is emphasized and a weather canopy becomes inherent to the building's form, creating a comfortable pedestrian access zone along the building.

The courtyard in Phase 2 provides limited pedestrian access in order to encourage activity along University Boulevard. The courtyard is designed to maximize views of the namesake Ponderosa pine both from the ground level and within the building. An outdoor seating area is designed to provide access to the base of the tree – offering a quiet, contemplative area and thus integrating this important landscape feature into the overall experience of the project.



PROJECT DESCRIPTION



UBC PONDEROSA COMMONS Phase 2 North

The University of British Columbia University Boulevard and West Mall, Vancouver, B.C

ADVANCE TENDER PACKAGE

Nov 8, 2013

OWNER
UBC Properties Trust
101-555 Great Northern Way
Vancouver, BC V5T 1E2
T: 604.731.3103
F: 604.731.2103

CONSTRUCTION MANAGER Urban One 301 - 611 Alexander Street Vancouver, BC V6A 1E1 T: 604.873.5100 F: 604.873.5101

CONSULTANTS

ARCHITECTURAL

Architects in Joint Venture Kuwabara Payne McKenna Blumberg Architects 3rd Floor, 322 King Street West Toronto, ON M5V 1J2 T: 416.977.5104 F: 416.598.9840

Hughes Condon Marler Architects 300 - 1508 West 2nd Avenue Vancouver, BC V6J 1H2 T: 604.732.6620 F: 604.732.6695

STRUCTURAL Wicke Herfst Maver Consulting 2227 Douglas Road Burnaby, BC V5C 5A9 T: 604.484.2859 F: 604.484.2861

MECHANICAL Stantec Consulting 1100-111 Dunsmuir Street Vancouver, BC V6B 6A3 T: 604.696.8000 F: 604.696.8100

ELECTRICAL Stantec Consulting 1100-111 Dunsmuir Street Vancouver, BC V6B 6A3 T: 604.696.8000 F: 604.696.8100

PLUMBING Stantec Consulting 1100-111 Dunsmuir Street Vancouver, BC V6B 6A3 T: 604.696.8000 F: 604.696.8100

LANDSCAPE

Hapa Collaborative 210 -128 West Hastings Street Vancouver, BC V6B 1G8 T: 604.807.4980

Kamps Engineering 79 Cheritan Avenue Toronto, ON M4R 1S7 T: 604.682.2020

SPECIFICATIONS

Keyword Specifications Inc 3537 - 5th Avenue West Vancouver, BC V6R 1S1 T: 604.676.8113

CODE GHL Consultants 950-409 Granville Street Vancouver, BC V6C 1T2 T: 604.689.4449 F: 604.689.4419

GEOTECHNICAL

GeoPacific 215-1200 West 73rd. Avenue Vancouver, BC V6P 6G5 T: 604.439.0922 F: 604.439.9189

SUSTAINABILITY Stantec Consulting 1100-111 Dunsmuir Street Vancouver, BC V6B 6A3 T: 604-696-8389

ENVELOPE RDH Building Engineering Ltd. 224 West 8th Avenue Vancouver, BC V5Y 1N5 T: 604.873.1181 F: 604.873.0933

ENERGY MODELLING

EnerSys Analytics Inc. 2989 Delahaye Drive Coquitlam, BC V3B 6Y9 T: 604.552.0700 F:604.648.8391

SURVEY Murray & Associates 201 - 12448 82nd Avenue Surrey, BC V3W 3E9 T: 604.597.9189 F: 604.597.9061

ENVIRONMENTAL ACM Environmental 217 - 2323 Quebec Street Vancouver, BC V5T 4S7 T: 604.873.8599 F: 604.873.5956

ELEVATOR Vertech Elevator Services Inc. 723 - 602 West Hastings Stree Vancouver, BC V6B 1P2 T: 604.647.4900 F: 604.647.4908

COMMISSIONING
Seawood Solutions and Services Inc.
700 - 1045 Howe Street
Vancouver, BC V6Z 2A9
T: 604.688.3649
F: 604.683.8655

ARCHITECTURAL DRAWING LIST:

0.00 NOTES / ASSEMBLIES An-0.00 COVER SHEET An-0.11 PARTITION TYPES

An-0.12 EXTERIOR WALL, ROOF, CEILING, GLAZING & SOFFIT TYPES

An-0.31 TYPICAL PRECAST & WINDOW WALL ELEVATION
An-0.34 PRECAST PANELS - CUSTOM PATTERN

2.00 PLANS

An-2.00 BASEMENT LEVEL PLAN
An-2.01 LEVEL 1 PLAN

An-2.01 LEVEL 1 PLAN
An-2.02 LEVEL 2 PLAN
An-2.03 LEVEL 3 PLAN
An-2.04 LEVEL 4 PLAN
An-2.05 LEVEL 5 PLAN
An-2.06 LEVEL 6 & 7 PLAN

An-2.07 LEVEL 8 & LEVEL 10 PARTIAL PLAN

An-2.08 LEVEL 17 & 18 PLAN An-2.09 LEVEL 2 ROOF PLAN An-2.10 ROOF PLAN

2.10 REFLECTED CEILING PLANS

An-2.11 LEVEL 1 REFLECTED CEILING PLAN
An-2.12 LEVEL 2 REFLECTED CEILING PLAN An-2.13 LEVEL 3 REFLECTED CEILING PLAN

3.00 ELEVATIONS/ SECTIONS
 An-3.01 SOUTH ELEVATION
 An-3.02 WEST ELEVATION
 An-3.03 NORTH ELEVATION
 An-3.04 EAST ELEVATION
 An-3.04 SOUTH ELEVATION/ SECTION - TOWER & LOWER COURTYARD
 An-3.06 NORTH ELEVATION/ SECTION - PODIUM
 An-3.07 WEST ELEVATION/ SECTION - TOWER
 An-3.08 EAST ELEVATION/ SECTION - PODIUM

4.00 BUILDING SECTIONS / HIDDEN ELEVATIONS

4.00 BUILDING SECTION - FOWER

An-4.01 BUILDING SECTION - SOUTH PODIUM
An-4.03 BUILDING SECTION - BREEZEWAY

5.00 VERTICAL CIRCULATION & WASHROOMS

5.00 VERTICAL CIRCULATION & WASHROOMS
 An-5.01 STAIR A - PLANS AND SECTIONS
 An-5.02 STAIR B & LLEVATOR 3 - PLANS AND SECTIONS
 An-5.03 STAIR C & ELEVATOR 3 + 2 - PLANS AND SECTIONS
 An-5.06 STAIR E & ELEVATOR 5 - PLANS AND SECTIONS
 An-5.06 STAIR F, RAMP A, SERVICE ELEVATOR 6 & ELEVATOR 4 - PLANS AND SECTION

6.00 ENLARGED PLANS
An-6.11 DEPARTMENT OFFICES & EDUCATION RECEPTION PLAN AND RCP
An-6.12 GROCER PLAN AND RCP
An-6.13 SHHS RECEPTION PLAN & RCP
An-6.14 LAUNDRY & GAMES ROOM, MUSIC ROOMS, CUSTODIAL CHANGE FACILITY
An-6.41 ENLARGED PLAN & RCP - TOWER RESIDENTIAL
An-6.42 ENLARGED PLAN & RCP - RESIDENTIAL GRIDS 1-8
An-6.43 ENLARGED PLAN & RCP - RESIDENTIAL GRIDS 3-4 (LEVEL 4 & 5)
An-6.44 ENLARGED PLAN & RCP - RESIDENTIAL GRIDS A-4 (LEVEL 6-7)
An-6.45 ENLARGED PLAN & RCP - RESIDENTIAL GRIDS A-4 (LEVEL 6-7)
An-6.45 ENLARGED PLAN & RCP - RESIDENTIAL GRIDS A-4 (LEVEL 6-7)
An-6.45 ENLARGED PLAN & RCP - RESIDENTIAL GRIDS A-4 (LEVEL 6-7)
An-6.45 ENLARGED PLAN & RCP - RESIDENTIAL GRIDS A-4 (LEVEL 6-7)
AN-6.45 ENLARGED PLAN & RCP - RESIDENTIAL GRIDS A-4 (LEVEL 6-7)
AN-6.45 ENLARGED PLAN & RCP - RESIDENTIAL GRIDS A-4 (LEVEL 6-7)
An-6.45 ENLARGED PLAN & RCP - RESIDENTIAL GRIDS A-C (LEVEL 8) An-6.46 ENLARGED PLAN & RCP - RESIDENTIAL GRIDS L-U (LEVEL 4-7)

An-6.46 ENLANGED PLAN & RCP - RESIDENTIAL
An-6.55 ANANGER'S SUITE PLANS AND RCP'S
An-6.56 VIP LOUNGE PLANS AND RCP'S
An-6.57 RESIDENTS LOUNGE PLAN
An-6.58 ESSIDENTS LOUNGE RCP
An-6.61 UNIT PLAN & RCP - STUDIO

An-6.61 UNIT PLAN & RCP - SI UDIO
An-6.62 UNIT PLAN & RCP - VIP STUDIO
An-6.63 UNIT PLAN & RCP - STUDIO TYPE B
An-6.71 UNIT PLAN & RCP - 2 BEDROOM TYPE A
An-6.72 UNIT PLAN & RCP - 2 BEDROOM TYPE A
An-6.81 UNIT PLAN & RCP - 4 BEDROOM TYPE B
An-6.81 UNIT PLAN & RCP - 4 BEDROOM TYPE B

An-6.82 UNIT PLAN & RCP - 4 BEDROOM TYPE B An-6.91 UNIT PLAN & RCP - ACCESSIBLE SUITE

8.00 ENVELOPE DETAILS
An-8.01 FOUNDATION DETAILS
An-8.10 PLAN DETAILS - DOOR JAMBS

AIR-6.10 PLAN DETAILS - LOUY AJMINS
AR-8.11 PLAN DETAILS - LEVEL 1 AND 2
AR-8.12 PLAN DETAILS - LEVEL 3
AR-8.13 PLAN DETAILS - LEVEL 3
AR-8.21 PARTIAL WALL SECTIONS
AR-8.21 PARTIAL WALL SECTIONS - CORES
AR-8.22 DOOR DETAILS
AR-8.22 DOOR DETAILS

An-8.23 DOOR & LOUVRE DETAILS

An-8.23 DOOR & LOUVRE DETAILS
An-8.31 EOGE OF SLAB DETAILS
An-8.33 ADDITIONAL DETAILS
An-8.34 SOFFIT DETAILS
An-8.51 ROOF DETAILS - PODIUM AND TERRACE
An-8.52 ROOF DETAILS

ISSUED FOR DEVELOPMENT PERMIT RESUBMISSION

UBC PONDEROSA COMMONS PHASE 2 NORTH

The University of British Columbia University Boulevard and West Mall, Vancouver, B.C.

Sheet Title COVER SHEET

3rd Floor, 322 King Street W Toronto, Ont: M5V 1J2 Can: T 416 977 5

F 416.598.9840 Suite 300 - 1508 West 2nd Avenue Vancouver, British Columbia

0 - 1508 West 2nd Avenue ancouver, British Columbis V6J 1H2 Canads T 604.732.6620 F 604.732.6695

UBC PONDEROSA HUB PHASE 2 NORTH Project Summary Updated 2012-12-20 PHASE 2 NORTH SITE AREA_ Area m2 ____ Area Sq. ft_ Site Area Site Coverage 7128.3 4282.6 76728.4 46097.5 BUILDING HEIGHTS_ South Podium (T.O. Slab not incl. Mech) West Podium (T.O. Slab not incl. Mech) Tower (T.O. Slab not incl. Mech) 105950 108650 134530 BUILDING AREA_ Component___ Area m2 Area Sq. ft Assignable per Program Non-Assignable Area m2 Area Sq. ft Corridors/ Service Space Structure/ Walls/ Un-Ass 65,196 ___17,942___ 102009 Total Building GSM 27,189 292,658 BED COUNT_ Studio Suite (1 Bedroom) 2 Bedroom Suite 4 Bedroom Suite Accessible Suite (1 Bedroo Total Student Housing Short Term (Class 2) Long Term (Class 1) nil 78

Coppright reserved. These diswings and the design contained threative which may be informed therefore are, and at all times remain, the exclusive property contained threative threative threative property contained threative threative threative threative threative Knuebace Payre McGreen Stutterburg | Hughess Condon Marker Architects | Architects in joint versum brods the coppright and constantly in the said diswings, which will be a subject of the contained on the said diswings which will be considered threative threative threative will be considered threative threative will be considered threative will be considered threative will be considered to the constant will be considered threative will be considered to the constant will be considered threative will be considered to the constant will be constant will be considered to the constant will be considered to the constant will be considered to the constant will be constant will be

No. ISSUES DATE

1 50% DESIGN DEVELOPMENT
DEVELOPMENT PERMIT
DEC 20, 2012
3 100% DESIGN DEVELOPMENT
AUG 18, 2013
4 100% DO - CUENT APPROVAL
5 50% WORKING DRAWINGS
OCT 22, 2013
OP PRESUMBRISION
NO VIO 8, 2013

ISSUED FOR DEVELOPMENT PERMIT RESUBMISSION



The University of British Columbia University Boulevard and West Mall, Vancouver. B.C.

Sheet Title PROJECT STATISTICS, CONTEXT PLAN

Job No. 1040 | 1024 Issue Date Nov 8, 2013 Scale As indicated



KOOTENAY HOUSE

**

ST. JOHN'S COLLEGE ST. JOHN'S COLLEGE 1

UNIVERSITY BOULEVARD

CONTINUING STUDIES

MATH/ STATS RESOURCE CENTRE

MATHEMATICS ANNEX

> SAUDER SCHOOL OF BUSINESS

SCARFE BUILDING

EDUCATION LIBARY \bigcirc

0

GEOGRAPHY

AGRICULTURAL ROAD

LEONARD S. KLINCK BUILDING

> BINNING STUDIOS

SCHOOL OF SOCIAL WORK POWER HOUSE

SOMERSET STUDIOS


THEATRE/FILM


ARTS 1

FIRST NATIONS LONGHOUSE


PONDEROSA OFFICE ANNEXES

WEST PARKADE

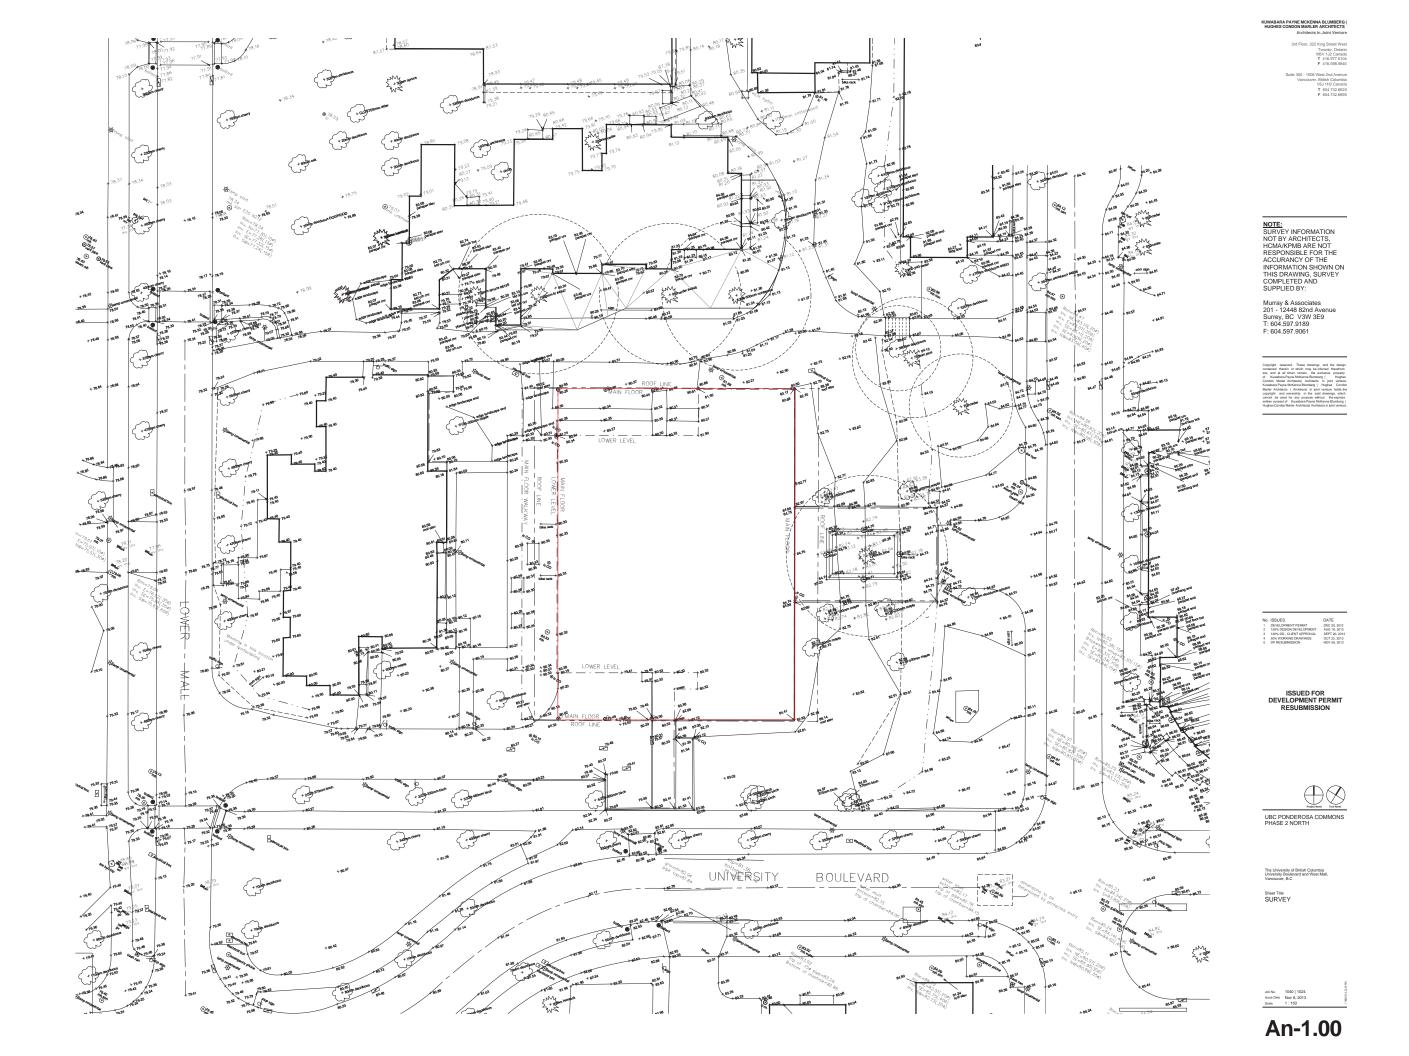


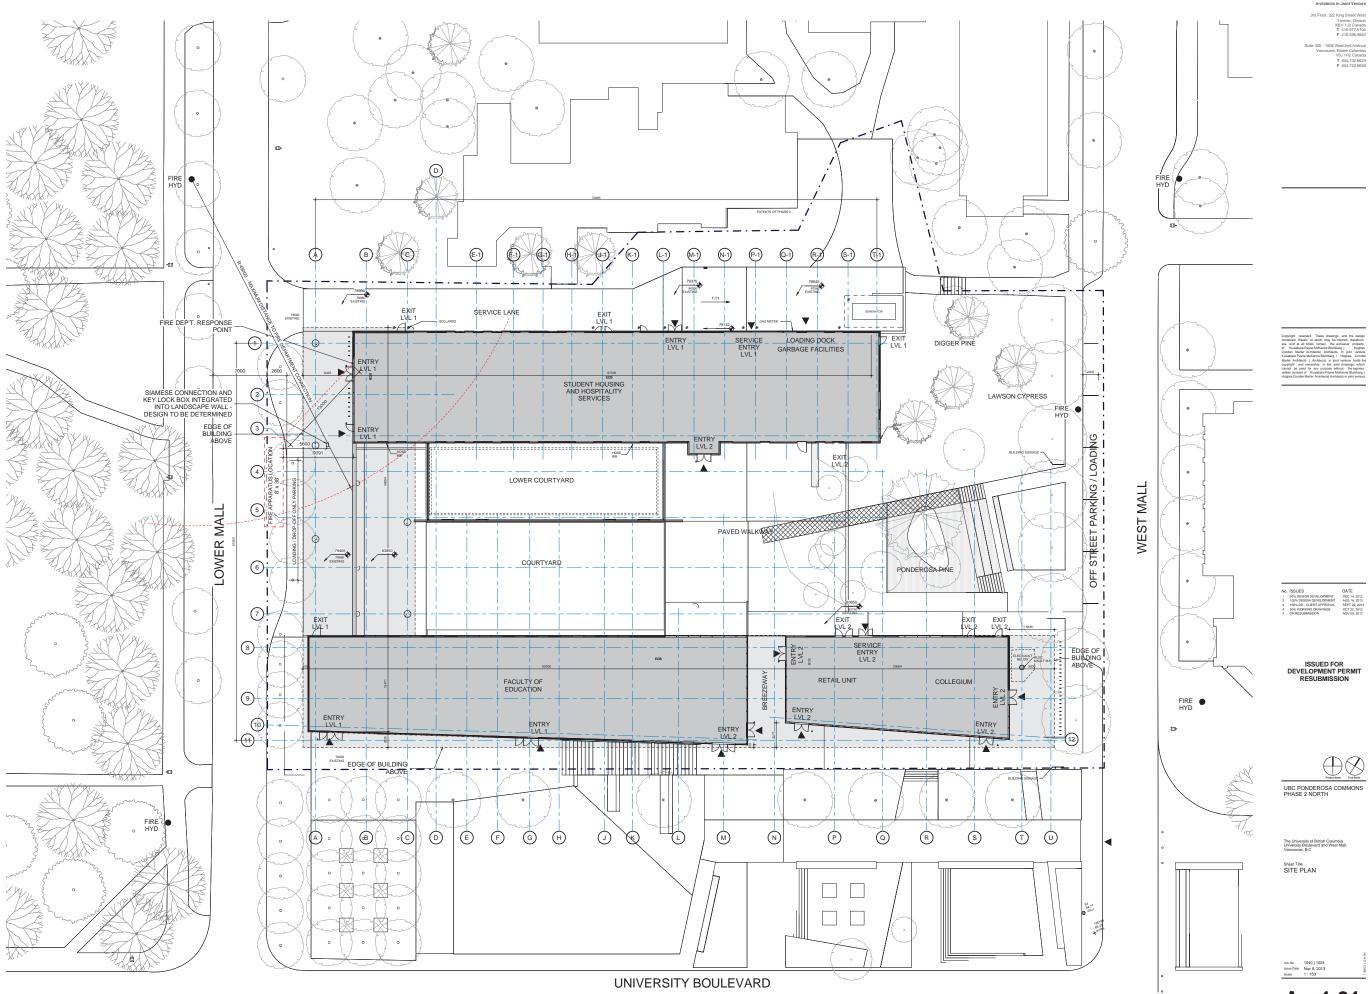

An-1.01

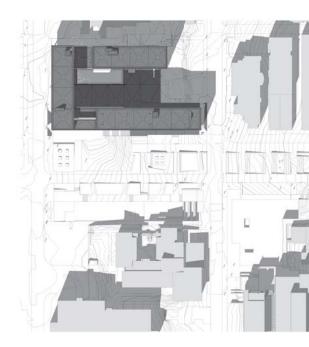


2 SPRING 12PM

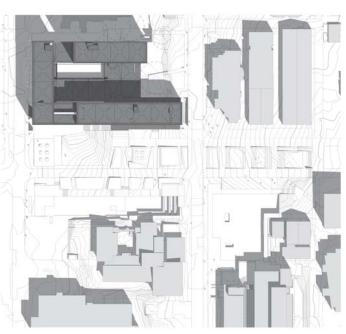


1 SPRING 10AM

4 SUMMER 10AM

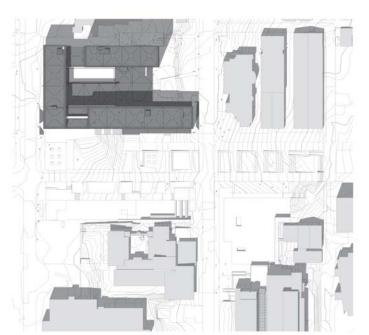

5 SUMMER 12PM

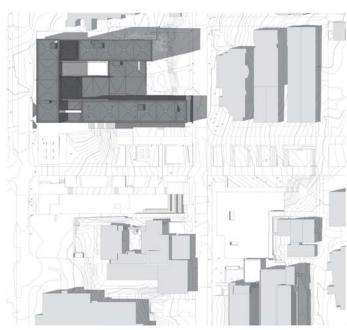

6 SUMMER 2PM

3 SPRING 2PM

No. ISSUES 1 50% DESIGN DEVELOPMENT 2 100% DESIGN DEVELOPMENT 3 50% WORKING DRAWINGS 4 DP RESUBMISSION	DATE DEC 14, AUG 16, OCT 23, NOV 08,
ISSUED FOR DEVELOPMENT PERM RESUBMISSION	

UBC PONDEROSA COMMONS PHASE 2 NORTH

The University of British Columbia University Boulevard and West Mall, Vancouver, B.C

Sheet Title SHADOW ANALYSIS