## UBC Recreation Centre North

**Development Permit Application** 

P U C

Prepared for: UBC Campus + Community Planning

> epared by: HAPE Architecture

March 2021

## Table of Contents

#### Introduction

- 04 Executive Summary
- Project Scope 05
- Project Team 06
- Submission Requirements 07

#### **Design Policy Compliance: Urban Design**

- 10 Edges
- 11 Accessible Connections
- 12 Public Realm
- 13 **Building Mass**
- 14 Programming

#### **Design Policy Compliance: Architectural**

- 18 Height and Massing
- 20 Accessibility
- 22 Pedestrian Connections
- 24 Entrances
- 26 Public Spaces
- 28 CPTED
- 30 Sustainability
- 31 Green Building Certification
- 32 Weather Protection
- 34 Solar Access
- 36 Space Between
- 38 Access and Loading
- 40 Loading Bay and Walkway
- 42 West Entrance and Stairs
- 44 Material Approach
- 46 Elevation Strategy
- 48 Universal Design
- 50 Extending the Public Realm

The following Development Permit Application is intended to document the development of the project from early conceptual drivers into a refined design proposal. Project goals have been balanced against program objectives and a comprehensive contextual analysis.

The design team has met with owner and stakeholder representatives throughout the schematic design process to review ongoing design work and confirm user requirements and overall project direction.


This document illustrates the contextual analysis and resultant schematic design for Campus + Community Planning's consideration.



Nick Sully Architect AIBC NSAA MRAIC Managing Partner **SHAPE** Architecture

#### **Drawing Requirements**

- **Project Statistics** 54
- Context Plan 55
- 56 Site Plan
- 57 Utilities Site Plan
- 58 Survey Plans
- Shadow Studies 61
- 62 Floor Plans
- 66 Roof Plan
- 67 Elevations
- 69 Sections
- 72 Landscape Plans
- 83 Lighting

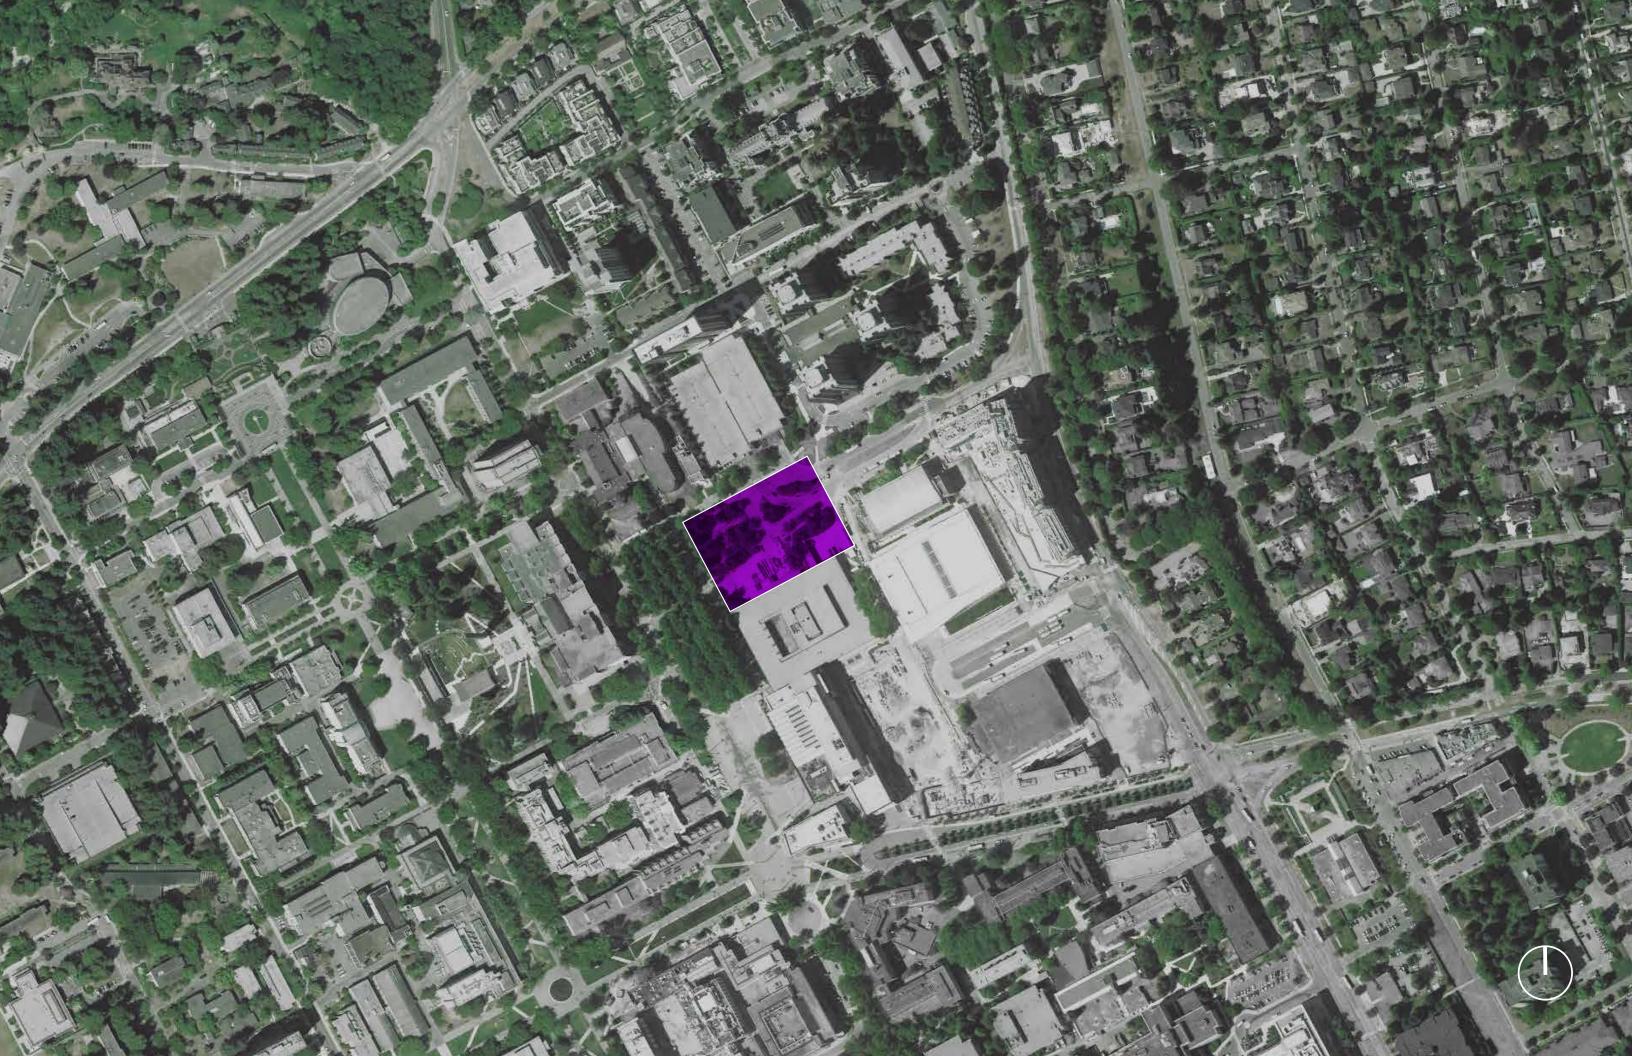

### Executive Summary

The New UBC Recreation Centre adds significant new state-of-the-art recreation space for the campus community, while resolving a complex set of existing site conditions.

The building defines and activates the south edge of the new Arrival Court and Green public realm. A new Recreation Gallery is created in the space between Life and the New Recreation Centre, which is animated on both sides with views into both adjacent student facilities. The building's north edge continues the new street wall of the student residences along Student Union Boulevard, while the west edge facing the Bosque aligns with the existing Life Building.

The project knits these edges together with a coherent and legible massing with articulations to define key moments of engagement. The defining characteristic being a generous new exterior walkway that continues the north-south student services spine into the public realm, linking together interior with exterior.

The building responds to the existing pedestrian circulation that crosses the site by creating new accessible connections that address many existing grade issues. New continuous weather protected pathways along the north and south edges lead to the three main entrances on the north, south and west. All three entrances offer accessible connections to the main lobby atrium, which further connects to the existing Life Building LO. The building massing and articulations are optimized for solar access to the public realms on the north and south, while also controlling solar gain to the heating dominated fitness and gym spaces.


This recreation centre will be a new destination for the health and wellness of the campus community. It connects and extends the student services spine, creates opportunities for formal and informal play, and will be accessible to and inclusive of the entire campus community.

The following sections articulate and illustrate the rationale for the urban and architectural design of this exciting new facility.

Development Permit Application UBC Recreation Centre North March 2021 4

## **Project Scope**

The UBC Recreation Centre is a brand new 9,377 square meter (101,000 square feet) facility comprised of three gymnasia, an interior walking track, cardio and weight-lifting fitness areas, multipurpose rooms, changerooms, and administrative offices. The project scope boundary is defined as approximately 6 meters from the building edge on all sides. The adjacent Arrival Court and Green public realm scope will be submitted as a separate project.

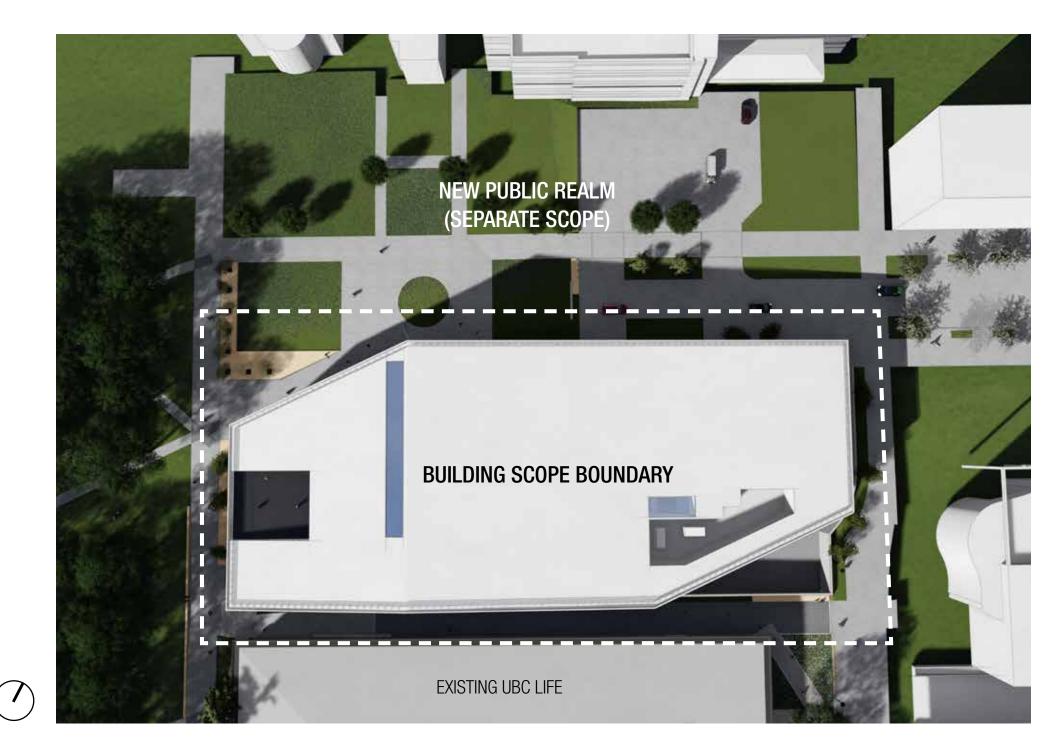

## Project Team

Architectural **SHAPE Architecture** 534 W Pender Street Vancouver, BC V6B 1V3 604.687.4457

#### Structural

WSP 1000 - 840 Howe Street Vancouver, BC V6Z 2M1 604.685.9381

Mechanical + Energy Modelling AME Group 200 – 638 Smithe Street Vancouver, BC V6B 1E3 604.684.5995

#### Electrical **PBX Engineering**

300 - 131 Water Street Vancouver, BC V6B 4M3 604.408.7222

**Construction Manager Etro Construction** 4727 Hastings Street Burnaby, BC V5C 2K8 604.492.0920

Landscape **DIALOG Design** 406 - 611 Alexander Street Vancouver, BC V6A 1E1 604.408.7222

#### Civil

**WSP** 300 - 65 Richmond Street New Westminster, BC V3L 5P5 604.525.4651

Acoustic **BAP** Acoustics

122 – 2227 St. Johns Street Port Moody, BC V3H 2A6 604.492.2992

Sustainability + Commissioning Integral Group 180 - 200 Granville Street Vancouver, BC V6C 1S4 604.687.1800

Elevator Apex 177 - 4664 Lougheed Highway Burnaby, BC V5C 5T5 604.533.4617

Envelope LDR Engineering Group 213 - 4288 Lozells Avenue Burnaby, BC V5A 0C7 604.805.6785

Geotechnical GeoPacific 1779 West 75th Avenue Vancouver, B.C. V6P 6P2 604.439.0922

#### Transportation **Bunt & Associates Engineering** 1550 - 1050 West Pender Street Vancouver, BC V6E 3S7 604 685 6427

#### Accessibility **KUNO Architecture** 580 E 29th Avenue Vancouver, BC V5V 2R9

604.512.3914

#### **DES Consulting** AME Group

200 – 638 Smithe Street Vancouver, BC V6B 1E3 604.684.5995

## Submission Requirements

The following additional Submission Requirements will be provided separately as individual files:

Application Form Application Fee Written Description Title Search Site Profile Tree Survey Geotechnical Report Photos DP Sign Notification 3D Model

Development Permit Application UBC Recreation Centre North March 2021 7

# 

## **Design Policy Compliance**

# Urban Design

## Edges

#### **FROM C+CP DESIGN BRIEF**


#### **Student Union Boulevard**

The vision for Student Union Boulevard is a consolidated, legible arrival experience that reflects the prominence of the street a destination in the *heart of campus. With the eastern portion already* upgraded, changes adjacent to the new recreation centre will complete this vision and tie into the surrounding campus fabric.

#### **DESIGN RESPONSE**

#### **Reinforce the Street Edge**

Three primary elevations reinforce campus context street edges; the south-east edge being the terminus of Athlete's Way. The north elevation of the New Recreation Centre will contribute to the entrance experience through the new Arrival Court and Green public realm.

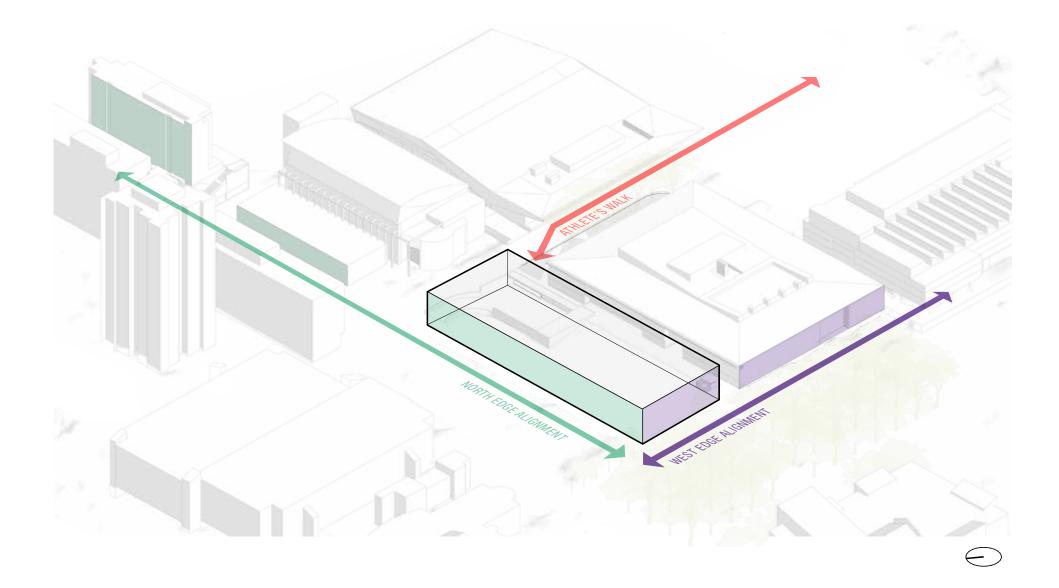

### Accessible Connections

#### FROM C+CP DESIGN BRIEF

#### **Student Services Complex**

The new building - as an addition to this student service hub - will need to enhance and build upon the hub's pattern of student services and create clear connections that draw people in and through.


#### **DESIGN RESPONSE**

#### **Accessible Connections**

Addressing the adjacent connection to UBC Life requires reconciling the vertical level change between L1 and L0 in order to address accessibility and approach.

The exterior space between the UBC Life Building and the New Recreation Centre has the potential to form a significant new pedestrian connection to the new bus terminus and Athlete's Way to the east and the north-south pedestrian connections to the student services complex and bosque.

There's an opportunity to extend the public realm through the building, connecting the student services complex to the Arrival Court and Green.

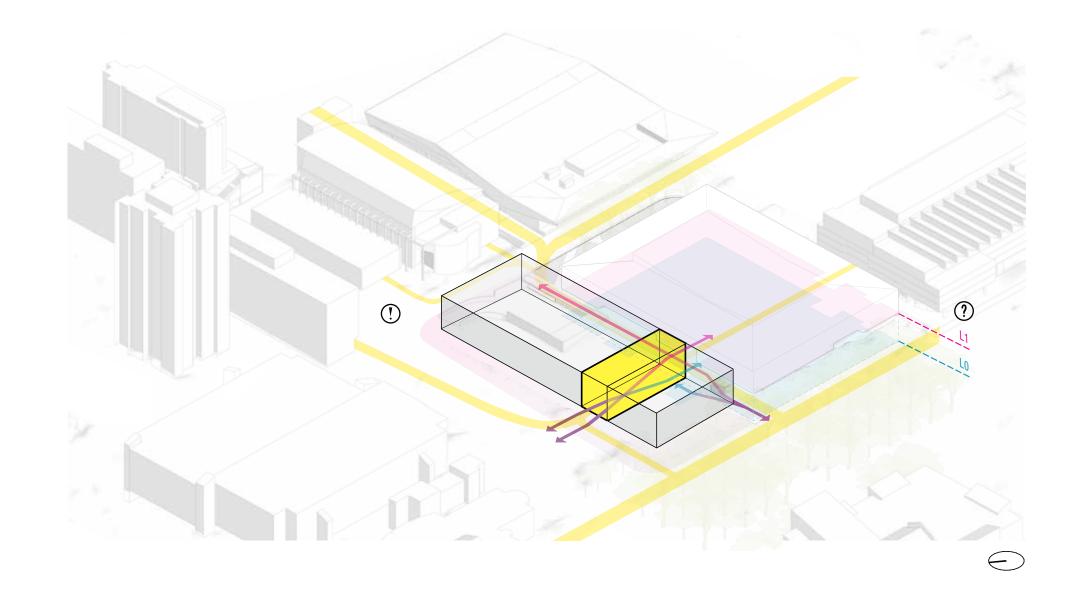

## Public Realm

#### **FROM C+CP DESIGN BRIEF**


#### **Campus Commons: The Porch and The Bosque**

To extend the Porch around the new recreation centre, tying the new building into the larger civic hub while also extending and connecting the social life of the new building to the Bosque, the green and (possibly) the arrival court.

#### **DESIGN RESPONSE**

#### **Delineating the Public Realm**

Once the extension of the public realm through the building has been established, opportunities for animating the Arrival Court and the Green will enhance the experience of the north entrance as the new face of health and wellness in the University Boulevard Precinct.

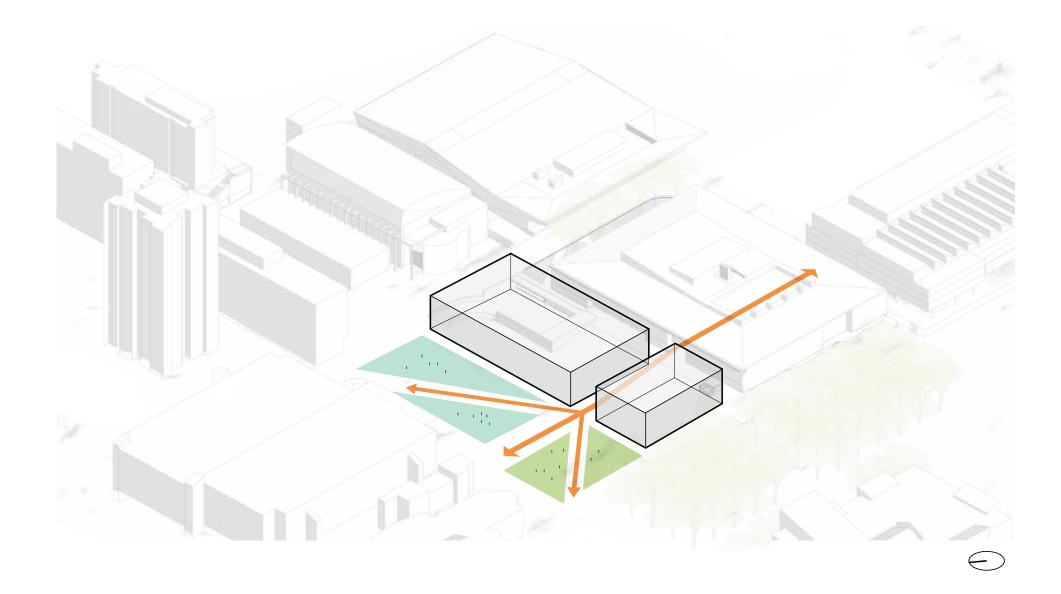

## Building Mass

#### FROM C+CP DESIGN BRIEF

#### Athlete's Way and Athletics + Recreation Hub

The new recreation centre will create an inviting place for arriving athletic teams at the arrival court and Athlete's Way. In doing so it should prioritize Pedestrian movement and comfort and reinforce the hub's identity.


#### **DESIGN RESPONSE**

#### Shaping the Building Mass

Reducing the building height for the west mass minimizes shadowing on the public realm to the north.

Tapering the massing at the corners directs visitors to the primary entrances.

Tapering the massing to avoid conflict with the existing loading area reduces the massing on the east edge.

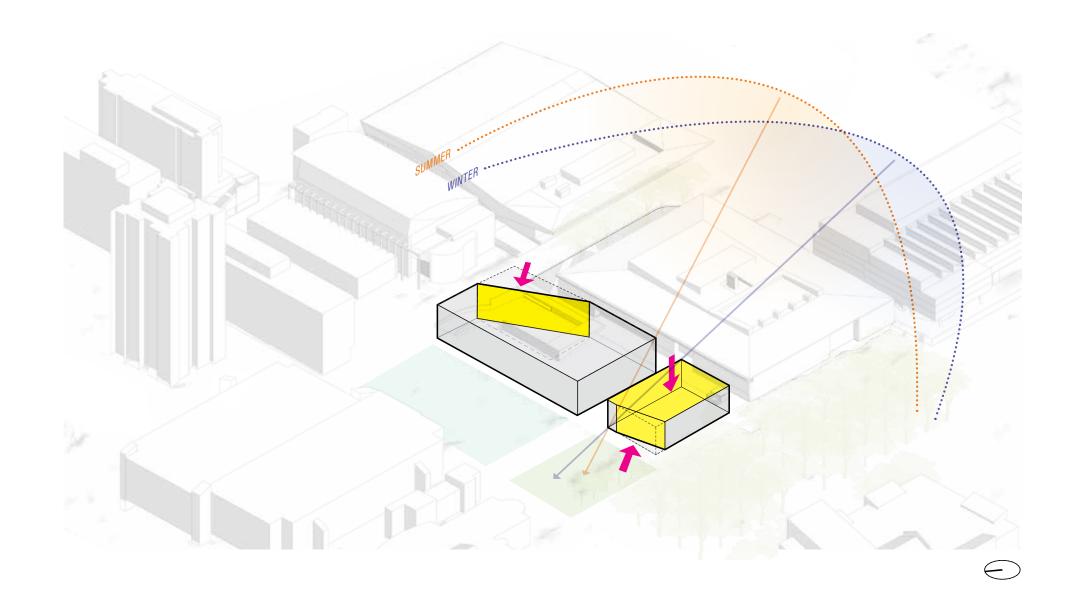


## Programming

#### **FROM C+CP DESIGN BRIEF**

#### Formal and Informal Play

The new recreation centre is a 9,377 gsm (101,000 gsf) UBC Athletics and Recreation building and will provide much needed recreation space including three non-varsity gymnasia, an interior walking track, an administrative suite, active spaces including space for strength training, functional fitness, cardio, stretching, and multipurpose studios, meeting rooms, change rooms, and back of house.

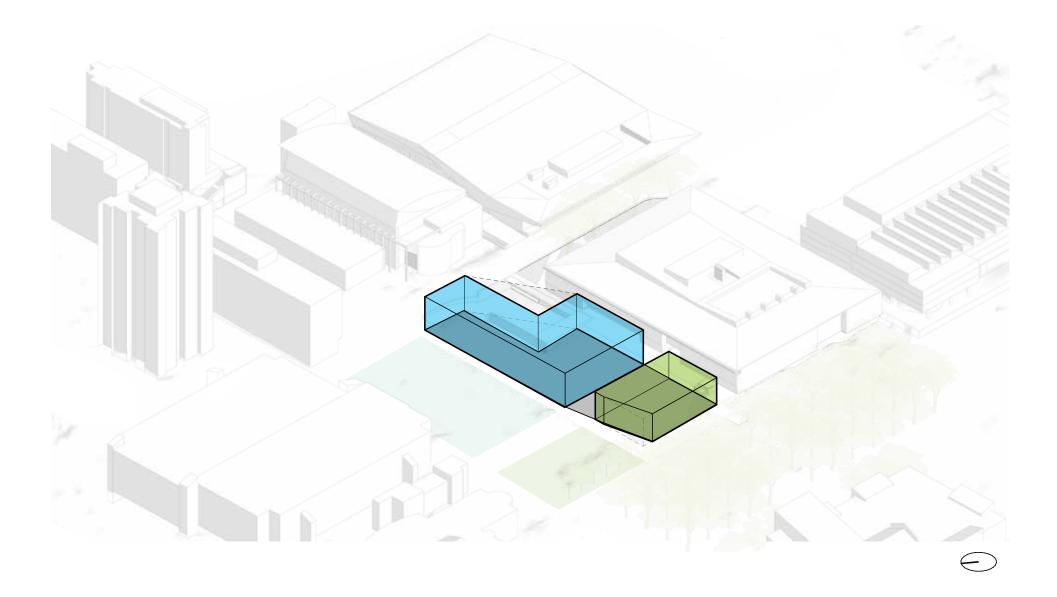

#### **DESIGN RESPONSE**

#### **Programming the Massing**

The fundamental spatial requirements of the program elements suggest gymnasia programming on the east and fitness programming on the west sitting atop a unifying podium.

Blank Page

Development Permit Application UBC Recreation Centre North March 2021 15

## 

## **Design Policy Compliance**

# Architectural


## Height and Massing


#### **Building Height and Program**

The minimum building height was determined by the clearance required for the athletic program spaces contained within. The roof peak aligns with the main north-south exterior connection and the north, south and west entrances, which all connect to the main lobby atrium along this axis.

The interior volume at this peak contains fitness programming on the western portion and a mechanical penthouse above the gymnasia on the east. This peak slopes down to the west and east; the west contains an outdoor space and two doubleheight interior volumes to face the bosque; while the east steps down to the height of the tall gym volumes and running track.

By reducing the building height on the narrow east and west edges of the building, a foreshortened perspective is experienced along the long north facade, thus reducing the perceived building mass.

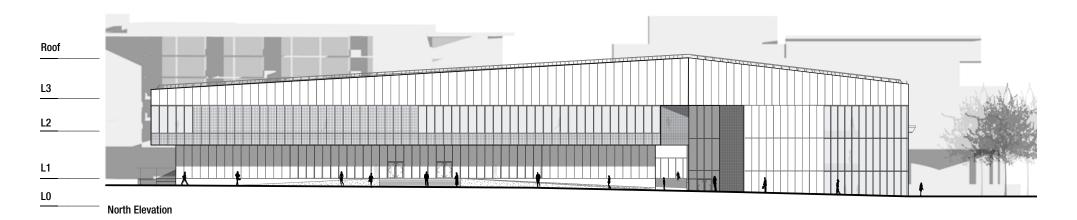

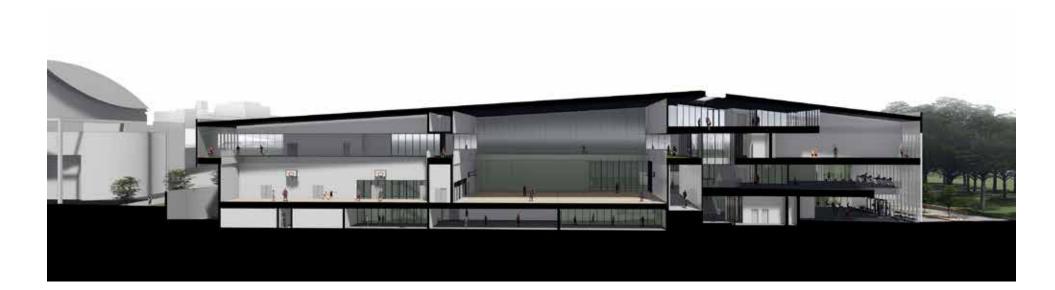




Looking south towards the roof peak that marks the exterior walkway and north entrance, with the building height sloping down to the west edge for improved solar access to the public realm

## Accessibility

#### **Existing Issues of Accessibility**

The existing north access to the UBC Life Building is extremely limited in terms of accessible connections to both L0 and L1. The elevation is broken with long runs of stairs going both up and down, as well as a lengthy and unpleasant ramp to the basement level.


#### Existing Accessibility Issues

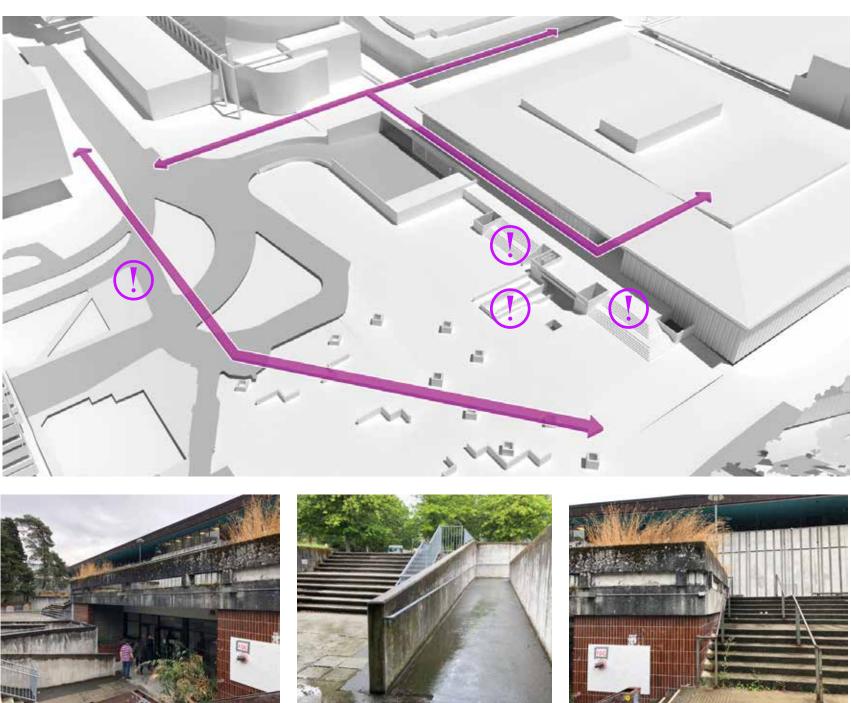







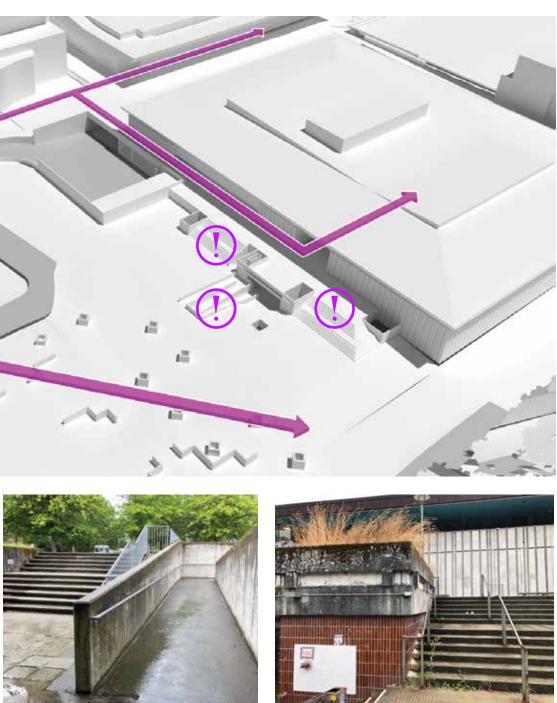

 $\in$ 

## Accessibility


#### **Creating New Connections**


The New Recreation Centre creates new connections to these existing disparate levels and integrates the experience into the facility itself. A north-south sloped exterior walkway extends the student services spine from the Nest and Life buildings to the new north public realm.

The Recreation Gallery between the Life Building and New Recreation Centre is at the same level as the existing L1 of Life. This passage now extends to the west with a new accessible connection to the bosque and greater campus beyond.

A new sloped walkway also extends to the West Entrance from along the bosque. This entrance has a shared vestibule with direct level access to both the Life Building and the New Recreation Centre.

#### **Proposed Accessibility Solutions**

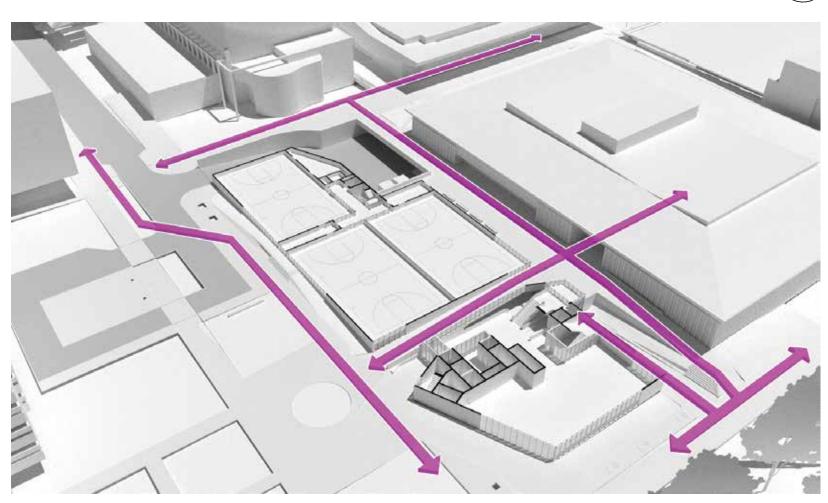

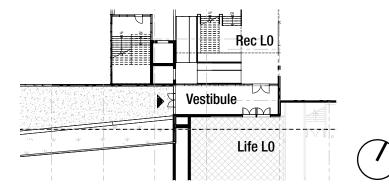


## Pedestrian Circulation

#### **Pedestrian Priority**

The network of exterior pedestrian connections that exist through the site directly informed the massing of the building. Most significantly, the exterior walkway that bisects the east and west massing extends both the exterior public realm between the buildings, while also weaving the interior of the New Recreation Centre and north public realm with the existing Life and Nest Buildings.

The east-west connection between the existing Life building is heavily used by people arriving to the campus from the main bus loop and heading to the north-west heart of campus. The north edge of the New Rec Centre defines the pedestrian experience of Student Union Boulevard which links the Pacific. Exchange and Gage student residences to campus. Athlete's Way continues past the east edge of the building, animated by the running track above the existing loading bay, and extending into the new public realm and beyond. The west edge enhances the pedestrian experience that connects various student service building, from Brock Hall to the Nest; animated with significant glazing of the fitness levels facing the Bosque, as well as the welcoming main West Entrance.

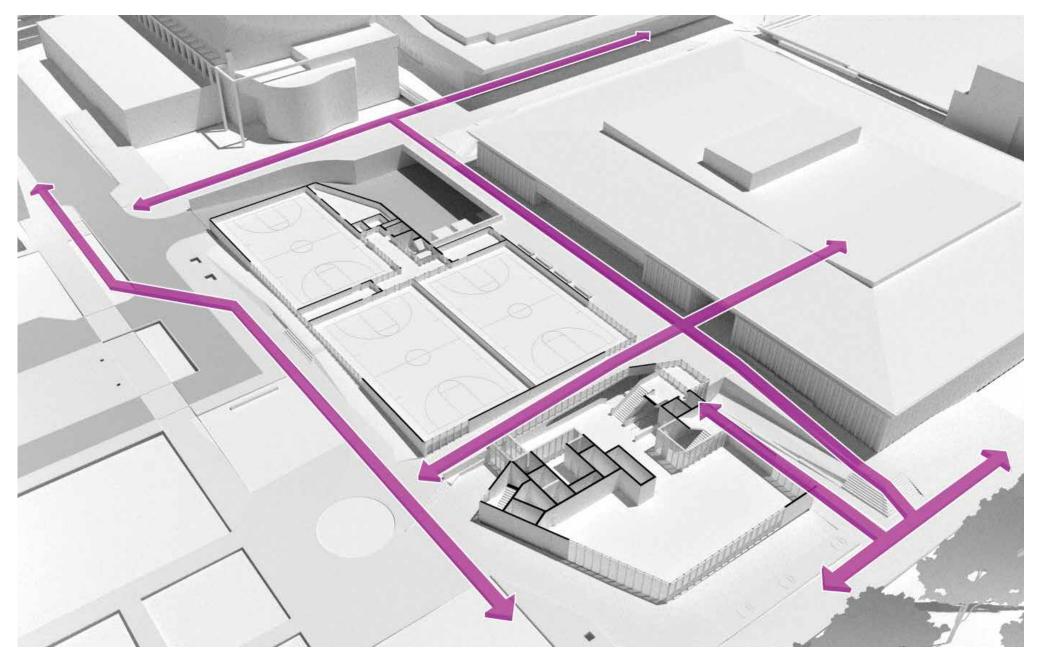






### Looking north along Athlete's Way, with a glimpse into the running track cantilever

## Entrances

#### **Building Entrance Identity**

Three main building entrances are intuitively represented through massing, weather protection and transparency while creating direct accessible connections to the main lobby atrium via entrance vestibules. The covered nature of these entrances extend the building into the landscape, and vice versa.

The North and South Entrances align with the main exterior walkway that bisects the building and is further emphasized by the roof peak. The West Entrance is identified with a large cantilever over it's entire approach, and is expressed as a double height transparent element under the main soffit line. All entrances are welcoming with ample views into the lobby, gym and/or fitness areas along their approach.

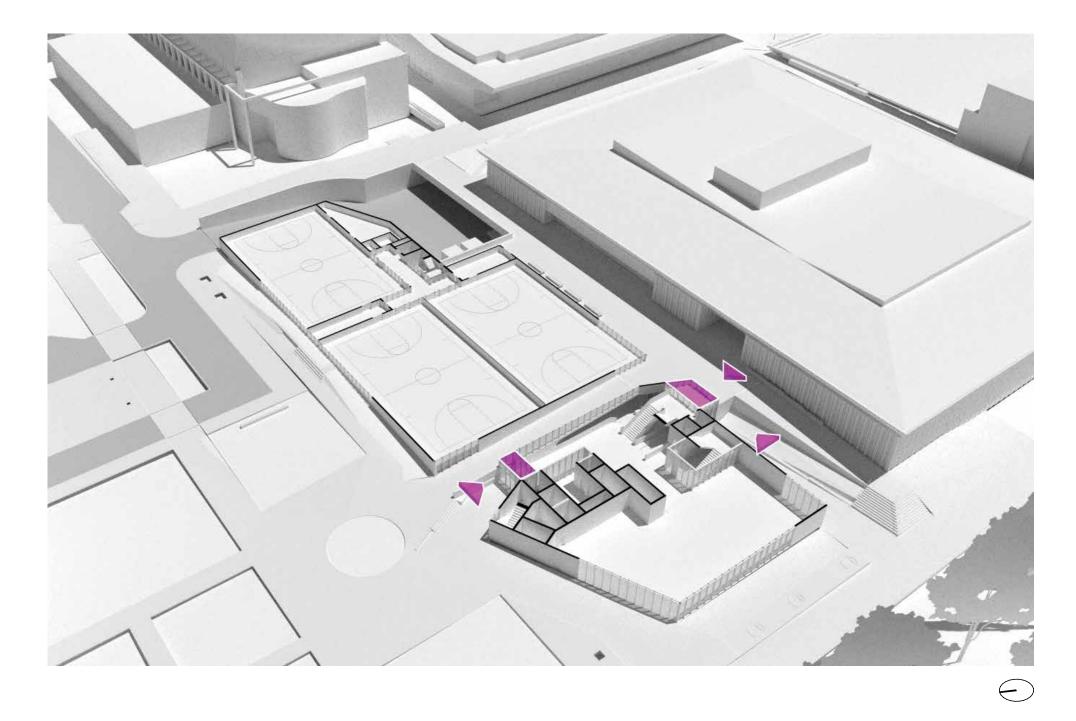



Generous North Entrance announces the main building entrance to the public realm, and offers views into various levels of the facility

South Entrance adjacent to the exterior walkway that connects to the Life Building, with views into the gymnasia that define this new Recreation Gallery





West Entrance facing the Bosque, offering weather protection with a large cantilever and views into the fitness area


## Public Spaces

#### **Creating New Connections**

Due to the existing levels of the Life Building, and an ambition to knit these existing disparate elevations together, the main entrance level of the New Rec Building matches L0 of the Life Building, and the second level matches L1 of the Life Building. These two levels are interconnected by the main northsouth exterior walkway; the exterior stair and ramp between Life and Rec; as well as an interior feature stair and elevator.

The exterior entrances are extended into the interior by way of a continuous soffit condition. Each entrance leads to the main lobby atrium, visually connecting three levels of the facility. From the main lobby, other public spaces of the facility can be accessed. The reception desks, changerooms, multipurpose room, admin offices, Physical Activity Office and controlled access to fitness are all available on this level. A stair and elevator takes users from this level to the gymnasia on L1.

Furthermore, there is a direct connection from the lobby to the running track and multi-purpose room on L2, both of which are publicly accessible.

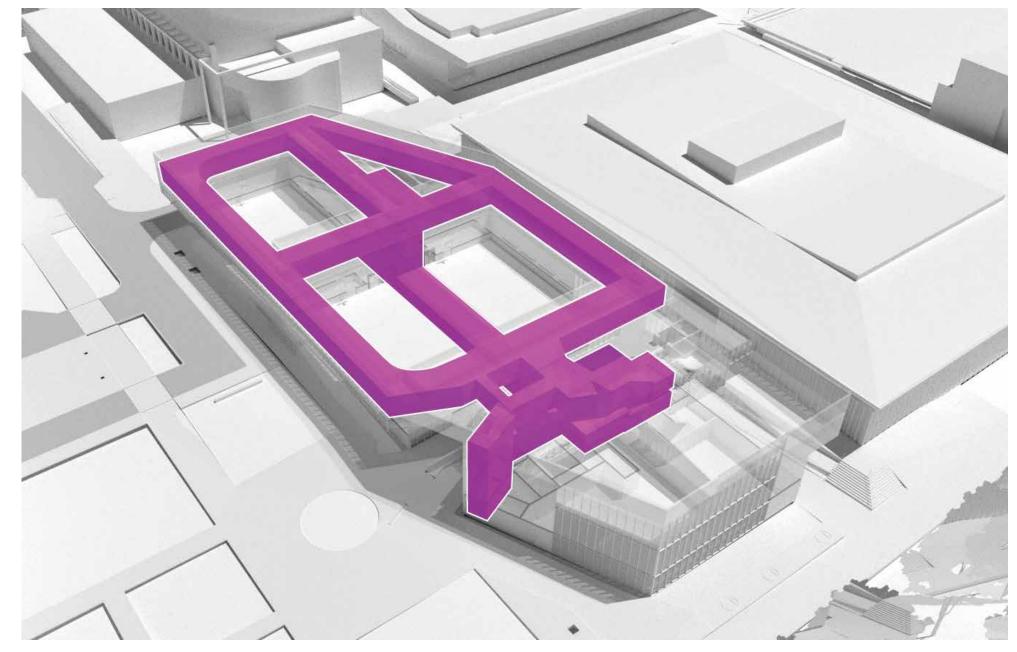







Main lobby atrium looking south towards stairs that go from the south entrance vestibule up to the running track and down to the main level of the facility

Looking into the gyms from the southwest edge of the walking track toward the north public realm


> Looking north into the main lobby atrium from the south entrance vestibule


## CPTED

#### **Connecting to Recreation and the Campus**

Strategic placement of windows, benches and landscaping further enhance this connection and encourage a dialogue between interior and exterior. Having both formal and informal recreation on display draws the larger campus into the sphere of health and wellness. People inside also have the opportunity to locate themselves within the surrounding campus, both physically and metaphorically.

In terms of CPTED, transparency along the ground plane creates passive surveillance of the public realm. Site lighting assists this visual control to enhance the safety and legibility of pedestrian routes to and from the larger campus.

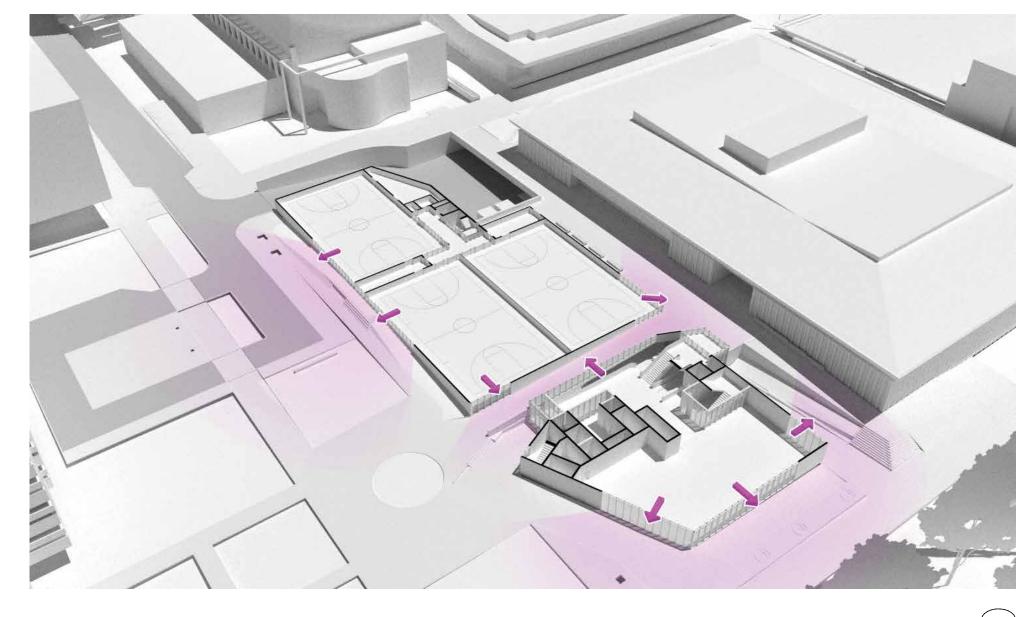

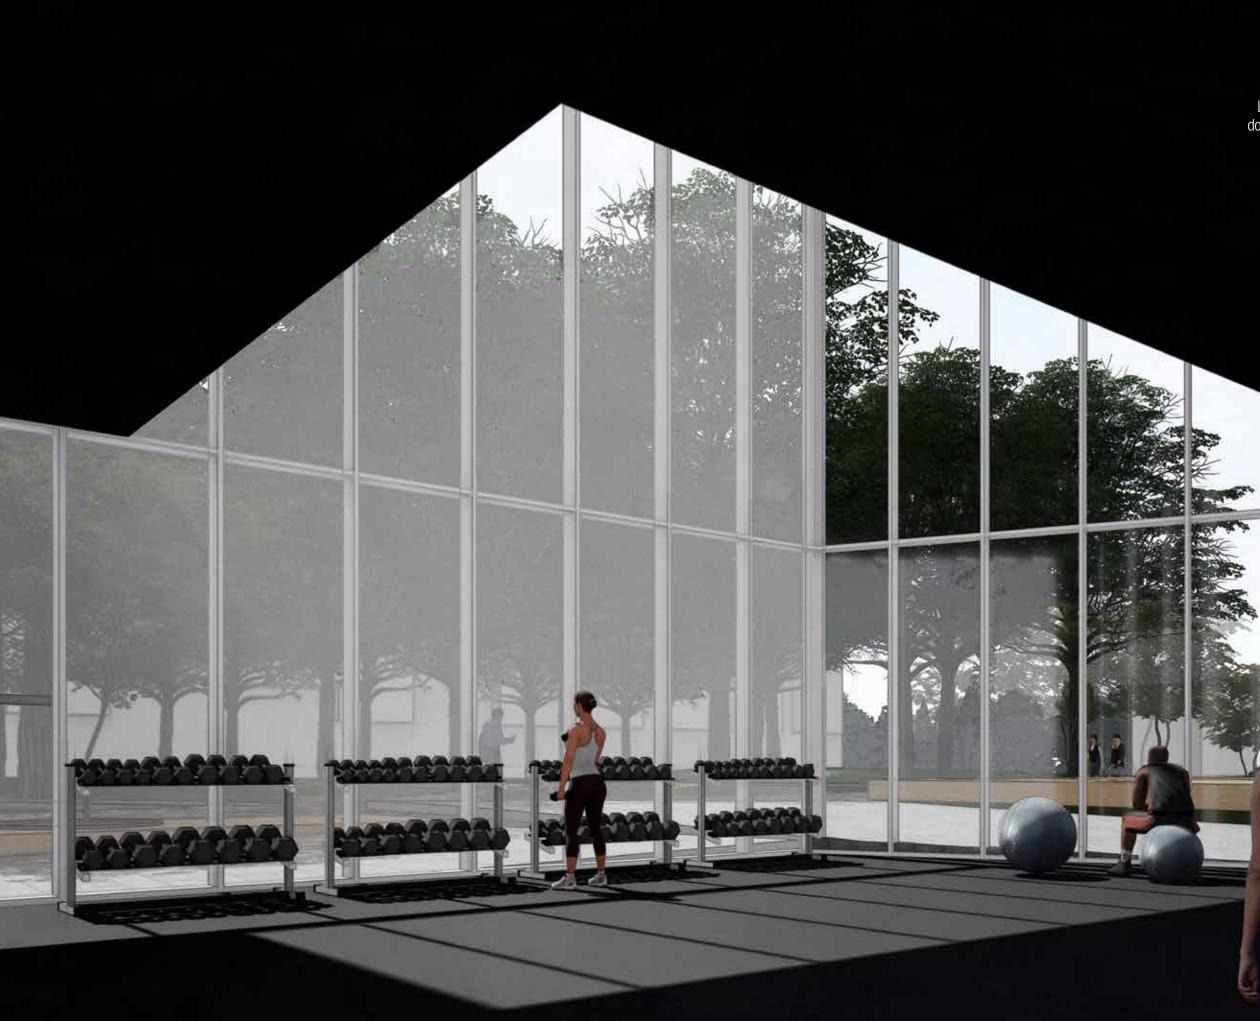

Looking from the ground level fitness through the double-height space that faces north-west towards the bosque and public realm

adices

XC

100

-

## Sustainability

The project integrates sustainability principles related to all three core tenets: environmental, social and economic. As a guiding framework, the LEED checklist will qualify the project as LEED Gold. To ensure environmental performance, quantitative energy use metrics are being measured and targeted per the C+CP Design Brief. To qualify the universal design, the project will be pursuing the Rick Hansen Foundation Accessibility Certified Gold.

Social sustainability is a driving principal in the core concept of the project, in terms of accessibility and inclusivity. The facility strives to be a new destination for health and wellness open to the entire campus community. New accessible pedestrian connections across the site and into both the new building and the existing Life Building are enabled by this project. A central exterior north-south sloped walkway divides the building mass in two, creating a new connection from the existing L1 of the Life north concourse, and connects this space to the new north public realm. This walkway aligns and connects both the north and south entrances to the New Recreation Centre. In addition, a West Entrance across from

the Bosque leads to a new shared vestibule that connects L0 of the Life Building and the main lobby atrium of the New Recreation Centre.

The environmental performance of the project has been considered and embedded into the core design. The overall massing and glazed areas address solar access to the exterior public realm and interior spaces. The majority of glazing on the heating-dominated fitness and gymnasia areas are north facing, while the minimal glazing that is south-facing is sheltered by overhangs. Furthermore, passive cooling through natural ventilation will be incorporated into these areas as well. The mechanical system and envelope assemblies are designed through energy modelling to meet the TEDI, EUI and DHW targets outlined in the Design Brief as follows:

- Energy use intensity (EUI) 130 kWh/m2/yr
- Thermal energy demand intensity (TEDI) 30 kWh/m2/yr
- Domestic hot water (DHW) 15 kWh/m2/yr

The best approach to limit embodied carbon is to limit the amount of material required. This design approach fits with the program, where exposed structure and services will limit the amount of wall and ceiling finishes. Furthermore, a Life Cycle Analysis is underway to guantify the elements which are contributing and identifying opportunities for optimizing the concrete mixes, insulation types, and structural steel cross sections to minimize their carbon impacts through materials, manufacturing, transportation.

From an economic perspective, the project judiciously strives to maximize value for future users by creating a durable and flexible building that will last generations. Both material selection and design layout align with this goal.

## Green Building Certification

Sustainability Workshops 1 and 2 were held with various stakeholders, and the following four themes emerged to guide the project design in pursuit of LEED Gold:

#### **Energy and Carbon**

Selecting the best system to support low-carbon operations.

#### Site, Water and Landscape

Weaving together the relationship between the public realm and building to maximize environmental benefit.

#### **Materials**

Sensible approach: measured use of materials and finishes to limit embodied carbon.

#### Social Sustainability


Enhancing accessibility and embedding inclusivity into the building and public realm design.

+ Doumented + Targened L Inder Intergration \$ Cost Item X NO	LEED v4 BD+C: NEW CONSTRUCTION Date Issued: 2021 02 18 Issued for AUDP & DP USGBC Project No.: Not Yet Registered	
66 12 14 18	Project Total	
	Certified 40 to 49 points Silver 50 to 59 points Gold 60 to 79 points Platinum 80 to 110 points	
1	Integrative Process Possible Points: 1	6 2 Materials + Resources Possible Points:
1	IPc1 Integrative Process	Y MRp1 Storage & Collection of Recyclables Y MRp2 Construction and Demolition Waste Management Planning
11 1 2 2	Location + Transportation Possible Points: 16	3 2 # MRc1 Building Life-Cycle Impact Reduction
		1 1 MRo2 Building Product Disclosure & Optimization: Environmental Product Declarations
	LTc1 LEED for Neighborhood Development Location	1 1 # MRc3 Building Product Disclosure & Optimization: Sourcing of Raw Materials
1 #	LTc2 Sensitive Land Protection	1 1 MRo4 Building Product Disclosure & Optimization: Material Ingredients
2	LTc3 High Priority Site	2 # MRc5 Construction & Demolition Waste Management
5 #	LTc4 Surrounding Density and Diverse Uses	
5 #	LTc5 Access to Quality Transit	9 1 6 Indoor Environmental Quality Possible Points:
1 #	LTC6 Bicycle Facilities	
1	LTc7 Reduced Parking Footprint	IEQp1 Minimum IAQ Performance
1	LTC8 Green Vehicles	IEQp2 Environmental Tobacco Smoke (ETS) Control
		2 # IEQc1 Enhanced Air Quality Strategies
3 4 3	Sustainable Sites Possible Points: 10	3 # IEQx2 Low-Emitting Materials
		1 # IEQc3 Construction IAQ Management Plan
Y	SSp1 Construction Activity Pollution Prevention	2 # IEQo4 Indoor Air Quality Assessment
1 #	SSc1 Site Assessment	1 # IEQc5 Thermal Comfort
2 #	SSc2 Site Development: Protect or Restore Habitat	1 1 IEQx6 Interior Lighting
1	SSc3 Open Space	3 IEQc7 Daylight
2 1 #	SSc4 Rainwater Management	I IEQc8 Quality Views
2	SSc5 Heat Island Reduction	1 IEQc9 Acoustic Performance
1 #	SSc6 Light Pollution Reduction	
5 2 1 3	Water Efficiency Possible Points: 11	6 Possible Points:
Y	WEp1 Outdoor Water Use Reduction: 30%	1 # IDc1.1 Innovation: Occupant Comfort Survey
Y	WEp2 Indoor Water Use Reduction: 20%	1 # IDc1.2 Innovation: To Be Determined, related to Accessibility / Equity
Y	WEp3 Building-Level Water Metering	1 # IDc1.3 Innovation Pilot: All Gender Washrooms / LEED O+M Starter Kit
1 #	WEc1 Outdoor Water Use Reduction	1 # IDc1.4 Exemplary Performance: Access to Quality Transit
1 2 1 2 #	WEc2 Indoor Water Use Reduction	1 # IDc1.5 Exemplary Performance: Construction Waste Management
2 #	WEc3 Cooling Tower Water Use	1 # IDc2 LEED™ Accredited Professional
1	WEc4 Water Metering	
<b>22</b> 5 <b>1</b> 5	Energy + Atmosphere Possible Points: 33	3 1 Regional Priority Credits Possible Points:
Y	EAp1 Fundamental Commissioning and Verification	1 # RPc1.1 Regional Priority: Optimize Energy (10 pts)
Y	EAp2 Minimum Energy Performance	1 # RPct.2 Regional Priority: Enhanced Commissioning (5 pts)
Y	EAp3 Building-Level Energy Metering	1 # RPct.3 Regional Priority: Building Life-Cycle Impact Reduction (3 pts)
Y	EAp4 Fundamental Refrigerant Management	1 # RPc1.4 Regional Priority: Rainwater Management - 2 Pts
6 #	EAc1 Enhanced Commissioning	
14 3 1 #	EAc2 Optimize Energy Performance:	Energy & Carbon Pillar
1 #	EAc3 Advanced Energy Metering	Site Water & Landscape Pillar
1 1 #	EAc4 Demand Response	Matetrials Pillar
1 2 #	EAc5 Renewable Energy Production	Social Sustainability Pillar
1 #	EAc6 Enhanced Refrigerant Management	# = Credit Tied to UBC Implementation Guide
2	EAc7 Green Power and Carbon Offsets	

UBC Rec North: GOLD-level Checklist LEED v4 BD+C: NEW CONSTRUCTION

	Materia	als + Resources	Possible Points:	13			
	MRp1	Storage & Collection of Recyclables					
	MRp2	Construction and Demolition Waste Management Planning					
#	MRc1	Building Life-Cycle Impact Reduction					
	MRc2	Building Product Disclosure & Optimization: Environmental P	roduct Declarations				
#	MRc3	Building Product Disclosure & Optimization: Sourcing of Raw Materials					
	MRc4	Building Product Disclosure & Optimization: Material Ingredients					
#	MRc5	Construction & Demolition Waste Management					
	Indoor	Environmental Quality	Possible Points:	16			
	IEQp1	Minimum IAQ Performance					
	IEQp2	Environmental Tobacco Smoke (ETS) Control					
#	IEQc1	Enhanced Air Quality Strategies					
#	IEQc2	Low-Emitting Materials					
#	IEQc3	Construction IAQ Management Plan					
#	IEQc4	Indoor Air Quality Assessment					
#	IEQc5	Thermal Comfort					
	IEQc6	Interior Lighting					
	IEQc7	Daylight					
	IEQc8	Quality Views					
	IEQc9	Acoustic Performance					
	Innova	tion + Design Process	Possible Points:	6			
#	IDc1.1	Innovation: Occupant Comfort Survey					

### Weather Protection

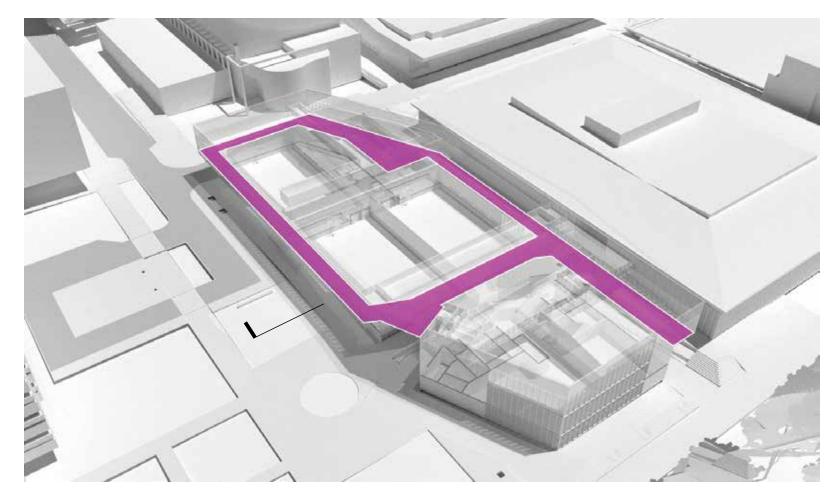

#### **Continuous Soffit**

The running track that wraps the three gymnasia integrates a covered walkway into the massing of the building along the north and south elevations, creating a weather protected zone that is continuous between all building entrances.





**North Elevation** The main pedestrian route along Student Union Boulevard offers weather protection integrated into the massing of the building, with seating below and views into the recreational spaces within.

Looking east along the north elevation, which continues the pedestrian connection along Student Union Boulevard and offers weather protection, seating, and views into the gymnasia

8

100.00

1000




## Solar Access



#### **Recreation Gallery**

Both the horizontal and vertical dimensions and proportions of the space between the Life Building and the New Recreation Centre were carefully considered to maximize solar access along it's length. The massing steps back on this level to further liberate the public realm, while also providing solar protection to the heating-dominated fitness and gymnasia spaces that front this Recreation Gallery.

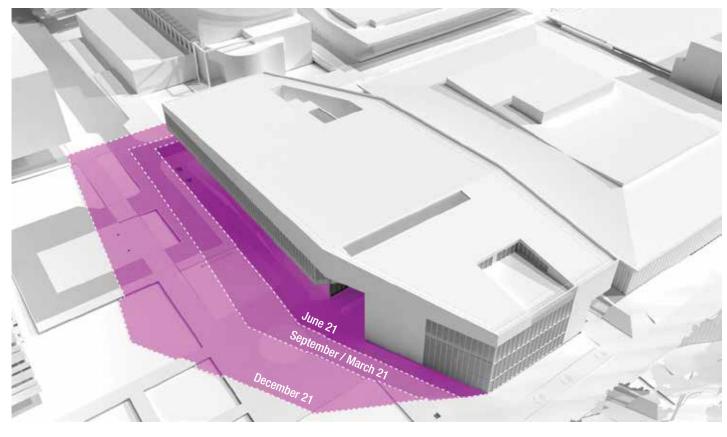

#### The Green

To maximize solar access to the north public realm, the massing slopes down significantly to the west. The above diagram illustrates shadowing at noon on the summer and winter solstices and both equinox.

 $\leftarrow$ 



Looking south along the bosque, illustrating the alignment of the Life and Rec building faces and the transparent facade facing north and west


4

## Space Between


#### **Recreation Gallery**


The proportion, materiality, alignment, colour, transparency and shape were all carefully considered when designing the space between the existing Life Building and the New Rec Building along it's entire experience. The space serves to orient pedestrians to the adjacent facilities, but also to the larger campus through the recognizable wayfinding elements of the Bosque and Athlete's Way.

With buildings on both the north and south, the space is sheltered, with it's own micro-climate. Covered space wraps the south edge, offering rain protection, shading for the heat-dominated gymnasia, while still allowing sunshine to fill this edge and, along with views into the gymnasia, encourage dwelling. Light-coloured cladding will reflect light into the shaded north edge of Life, further illuminating the space. All these elements come together to offer a comfortable place to pause.

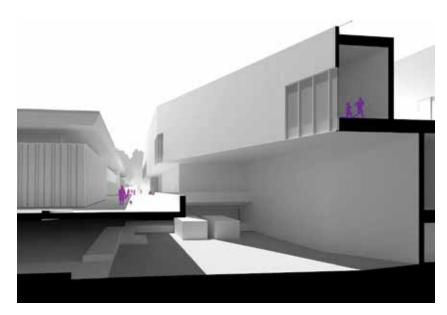


The expanded walkway at the loading bay, with views into the running track above

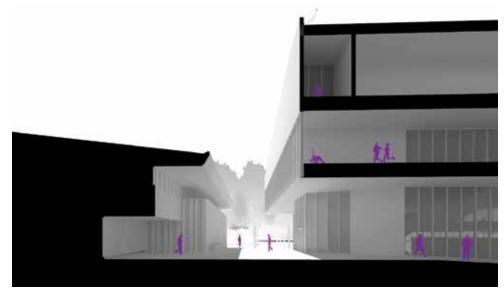


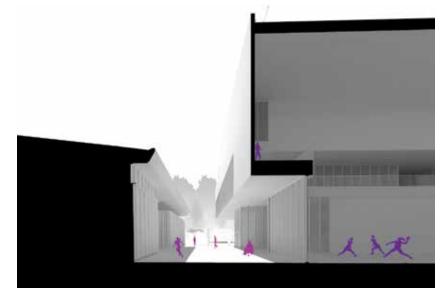

Tall glazed sections offer views into the large gymnasia spaces

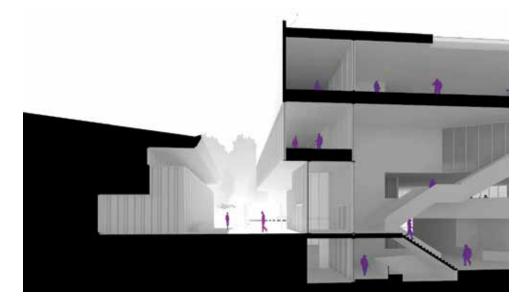

aligns with the entrance to Life

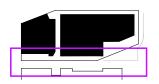

The new exterior sloped walkway aligns with the main north entrance to the Life Building, accessibly extending the student services spine through and into the New Recreation Centre

The South Entrance vestibule to the New Recreation Centre also

Looking west toward the bosque from between UBC Life and Rec buildings, with views into the gym and the south entrance vestibule


ļ




# Access and Loading

#### Access and Loading

The existing loading bay located at the northeast edge of the Life Building, creates significant constraints on the building position and massing, as well as the pedestrian connections through the site in both the north-south and east-west direction. The project proposes to expand the east-west connection to address this significant pinch point - refer to the following pages.

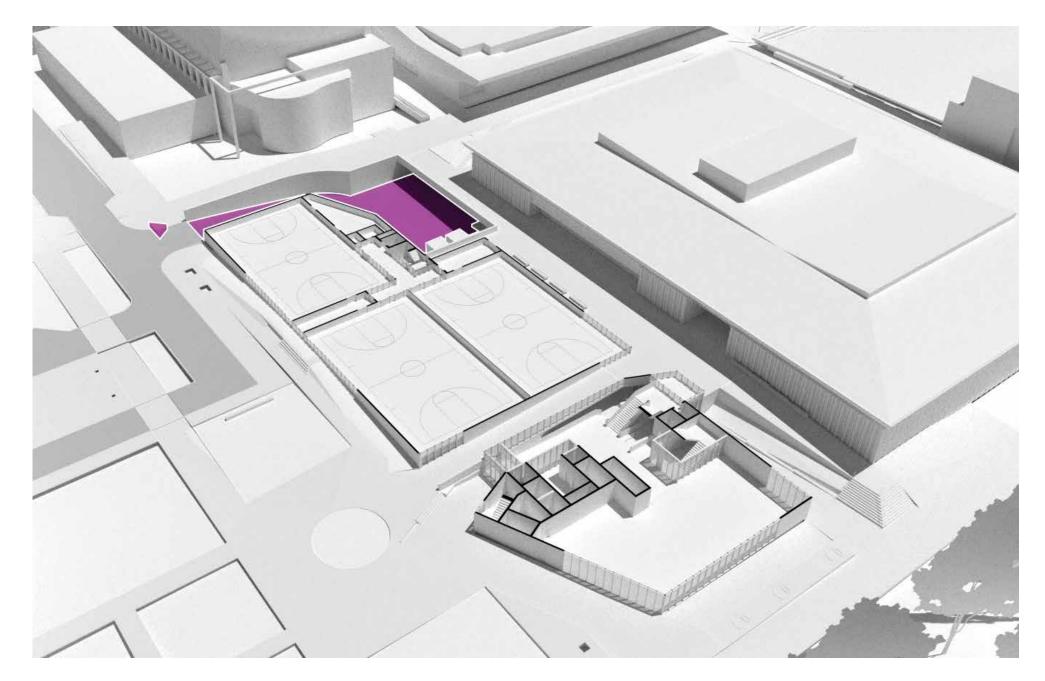



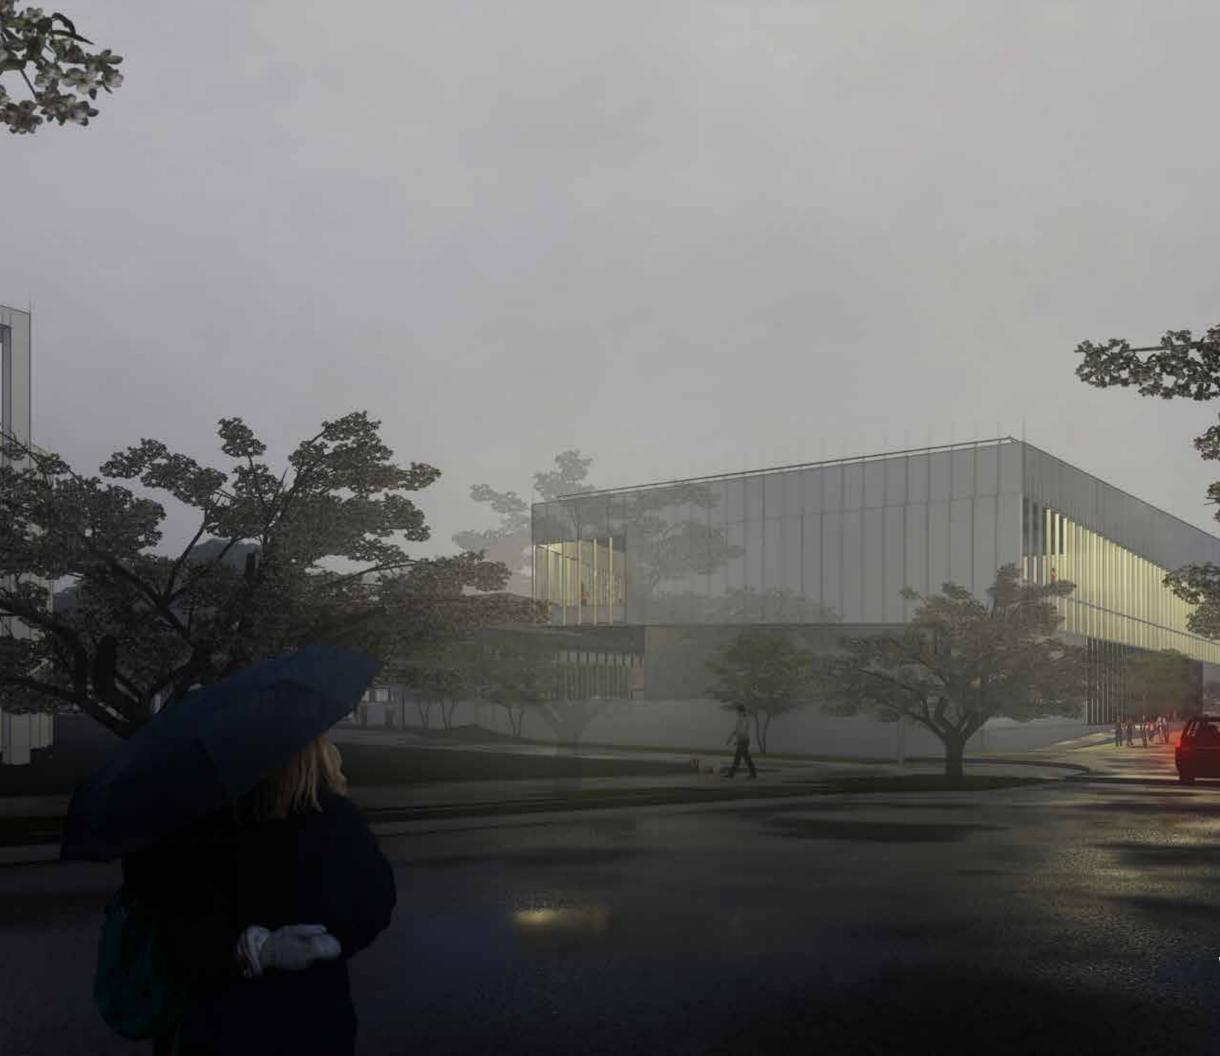

Looking to the west along Student Union Boulevard, with the existing loading bay entrance in the foreground, as the interior glows with light and activity.

# Loading Bay and Walkway

#### Existing Loading Bay and Walkway



Looking north along west dock apron



Looking south along west dock apron towards Life



Looking west along Life Building and upper loading bay wall




Looking north-east to loading bay entrance ramp



Looking south-east to loading bay compactors and south dock apron




Looking north-west towards Life Building and upper loading bay wall

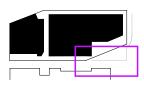

#### Existing Walkway Wall Remains

Significant pedestrian pinch point to south of Life Building




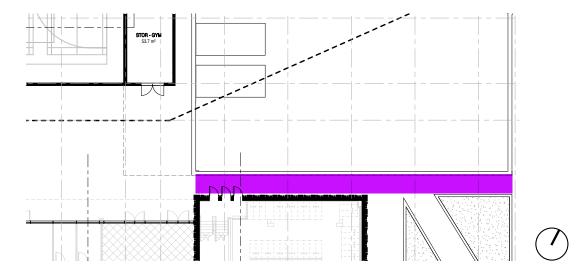


## Walkway Wall Relocated North

Expanded public realm to south of Life Building



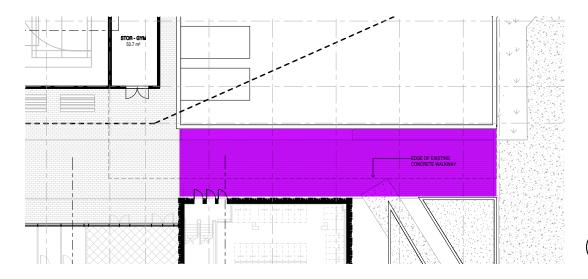



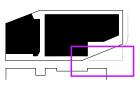

# West Entrance and Stairs


#### Existing Loading Bay and Walkway



Looking south along between Life and the Bosque



Looking north-east from the Bosque towards Life

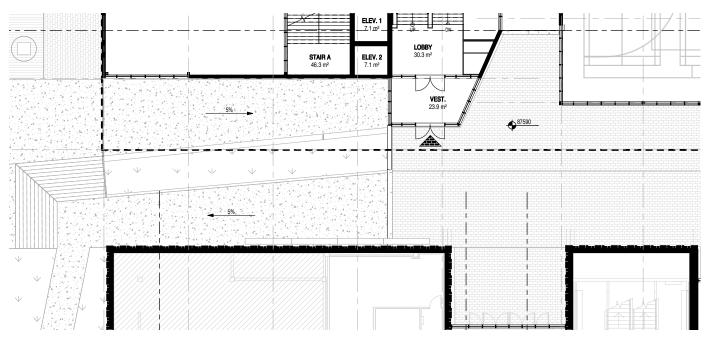




Looking south-east towards L0 and L1 Life Building entrances



Looking south-east towards Life stairs up to L1



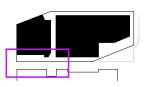



Looking east toward the West Entrance, with the new ramp and stair connection from the existing Life L1 level to grade along the Bosque


# Material Approach

#### Robust, Honest, Minimal

With a number of new Athletics facilities in this precinct over the last several years, a clear design language has emerged that represents the 'Contemporary District' with a lightness and optimism to the material palette. The intent for the New Recreation Centre is to take inspiration from this material palette, while contextualizing it to the fitness program within.

For the interior, a durable, cost-effective and minimal material palette is most appropriate. This includes concrete floors, exposed ceiling services, and exposed structure. The exterior continues this approach, with a unitized curtainwall and metal cladding system with metal bar grate layered in specific locations. A metal bar grate soffit extends this language as a layered, semi-transparent experience that unifies horizontal and vertical planes.


This minimal, monochromatic material palette, along with a similar approach to detailing, assists to descale the overall building mass by simplifying it's expression.

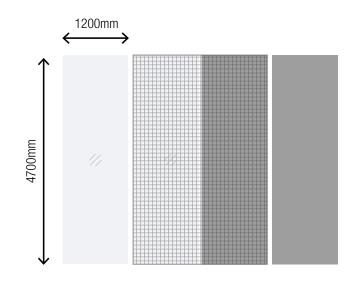

A standard cladding module was chosen to stretch the budget and condense the construction schedule. This system allows larger panels to be lifted into place as a single complete envelope element; thus simplifying the process and result. There are four elements: glazed; glazed with bar grate; solid with bar grate; solid.



Irving K Barber Learning Centre (left) and the UBC Aquatic Centre (right) are both in the Contemporary District and utilize a light coloured cladding material and abundant glazing

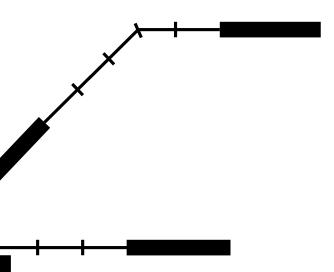

Plan diagram of the 'rules' for locating solid and transparent elements within the unitized system at both a perpendicular and obtuse corner.






Looking east approaching the weatherprotected West Entrance, with views into the adjacent fitness levels


# **Elevation Strategy**

The interior program was diagrammed to understand moments of intense occupation; glazing was placed at these locations following the previously outlined rules.

#### East Elevation


Locating glazing on both faces of each corner of the running track allows users to always have a view to the exterior in front of them, helping to locate themselves in the larger campus.

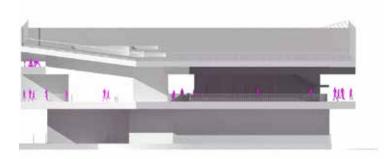

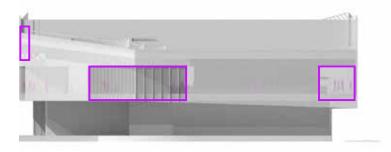


#### South Elevation


Glazing is located along the approach to the west entrance, offering views into the fitness. The south entrance vestibule and south gym wall are transparent to activate the space between Life and Rec.

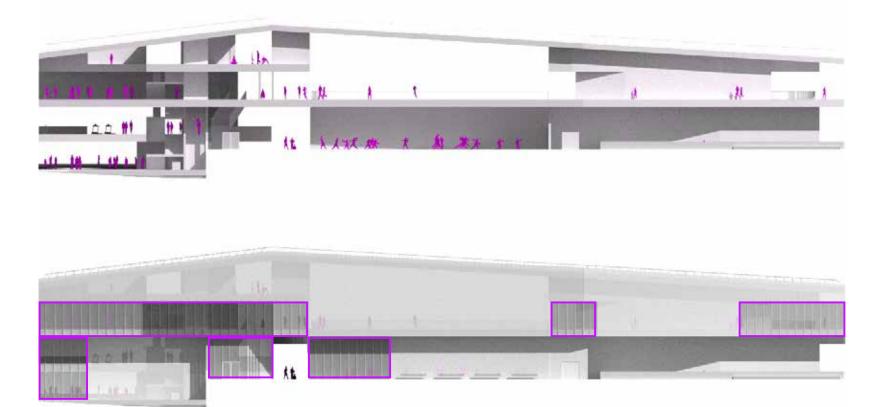

#### West Elevation


Four levels of fitness face directly to the bosque to the west and the new public realm to the north; glazing was maximized at these edges to animate the plaza and create a strong connection to the immediate trees. An outdoor fitness area on the upper level amplifies this connection; sweating in the treetops.

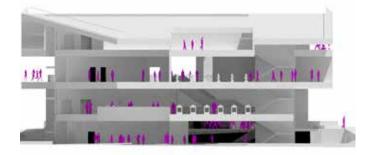


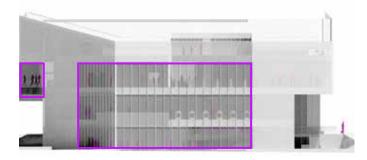

#### North Elevation

As the most visible face of the New Recreation Centre, it has an important relationship to the new public realm. Glazing along the entire length of the running track will animate the plaza below, both day and night, and offer a unique experience to those exercising. The lowerlevel gymnasia also have a visual connection, offering views through the building to the space between Life and Rec.

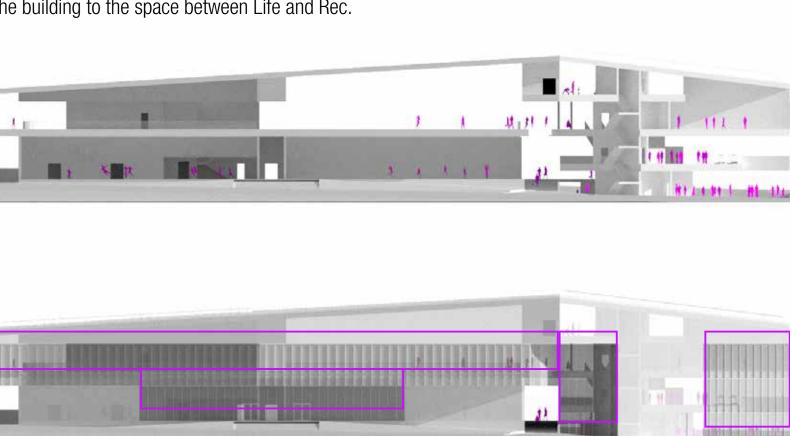

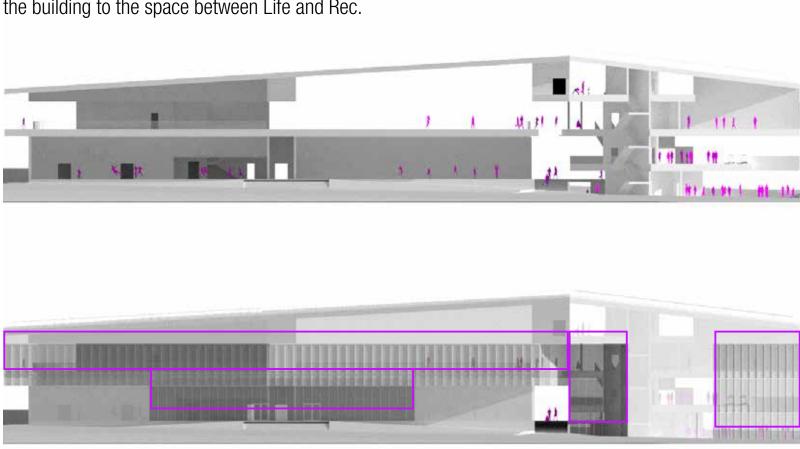

# Universal Design

#### **Designing for Everyone**

Inclusive design can and should be seen as a means for creative design thinking - as a springboard for innovation - not simply an application of building code and regulations. Inclusive design should be invisible in a way - designed so that people are not even aware that they are using an accessibility feature.

#### **Rick Hansen Foundation Accessibility** Certification

We will be working with the Rick Hansen Foundation Accessibility Certification<sup>™</sup> (RHFAC) rating survey as a framework to organize our process, and we will expand on this by engaging in ongoing research and precedence studies as well as a review of other similar facilities on campus.

The project is targeting RHF Accessibility Certified Gold, and the design team is working with Kuno Architecture to facilitate this process.

#### **Universal Design**

Creating universal and accessible change and washroom facilities can help ensure the protection of an individual's privacy, dignity and security while accommodating a much wider user group. This facility includes both universal and genderspecific washroom options, with universal washrooms available on all levels.

Ongoing dialogue between the design team, stakeholder group, the UBC Equity and Diversity Office as well as the UBC Centre for Accessibility have been a productive method for iteratively developing changeroom layouts that address many nuanced considerations.

Key considerations have been the relationship between the gendered and universal washrooms; balancing sight lines for privacy and surveillance; creating an intuitive layout for the various user 'change' sequences; ensuring primary pathways are dimensionally appropriate.

#### Universal washroom design evolution through stakeholder workshops

#### **January 5 2021**

Early designs had the gendered changerooms access through the universal changerooms, however this tended to 'gender' each side of the universal area.

X	
🗖	
X	
- 🗵	
Â.	
<u> </u>	


#### January 20 2021

The gendered changerooms were relocated to be accessed directly from the main circulation; universal layouts varied based on locker and stall configurations.



#### February 2 2021


Refinement of the universal changeroom layout, with a vertical division of lockers and stalls preferred; investigations of corridor furniture ongoing.

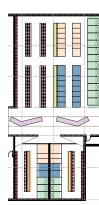








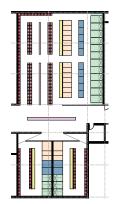

48 Development Permit Application **UBC Recreation Centre North** March 2021

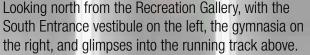



# Extending the Public Realm






The main north-south exterior walkway through the

# 

# Drawing Requirements

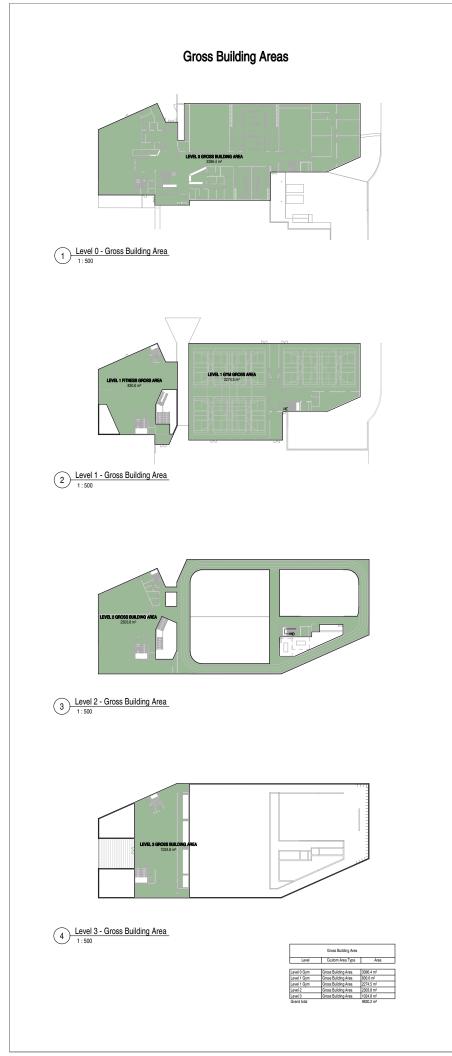






#### UBC Recreation Centre North : Project Data

CIVIC ADDRESS:	UBC RECREATION CENTRE NORTH 
MAJOR OCCUPANCY: NUMBER OF STORIES:	9830 m2 A-2 (Article 3.2.2.24) UP TO 6 STOREYS YES

Symbols Legend

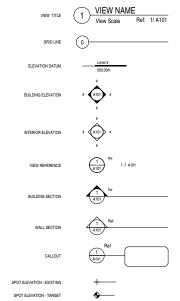


£

CENTRE LINE



#### 534 WEST PENDER STREET VANCOUVER, BC CANADA V6B 1V8

TEL: (604) 687-4457 EMAIL: info@ shapearchitecture.ca WEB: www.shapearchitecture.ca

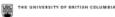

GENERAL NOTES:

SPRINKLERED:	YES
CONSTRUCTION TYPE:	NON-COMBUSTIBLE

AREA TAG	NAME NAME 150m2
CEILING TAG	1t 1000 AFF
CURTAIN PANEL TAG	GLØ
DETAIL ITEM	TYPE NAME
DOOR TAG	DIII
FLOOR TAG	F1.a
FLOOR FINISH TAG	FFB
KEYNOTE TAG	?
MATERIAL TAG	?
CASEWORK TAG	11
PARKING TAG	11
PLUMBING FIXTURE TAG	0
REVISION TAG	<u>an</u>
ROOF TAG	R1.a
ROOM TAG	NAME NAME NAME RI01 RI01
SPECIALTY EQUIPMENT TAG	150 m2
STAIR TAG	20 R @180mm STAIR #1
WALL TAG	(Em.)
WINDOW TAG	<pre>wx&gt;</pre>

STAMP

ISSUED / REVISIONS

DESCRIPTION DATE Issued for Development Permit 210301 NO 1

#### **Recreation Centre North**

6140 Student Union Blvd.

#### Project Data + Notes

DATE	
DRAWN BY	
CHECKED BY	
SCALE	
JOB NUMBER	



1 March 2021 MBH/JW NS/AT

2008




DATE	
DRAWN BY	
CHECKED BY	
SCALE	
JOB NUMBER	

A1.01



55

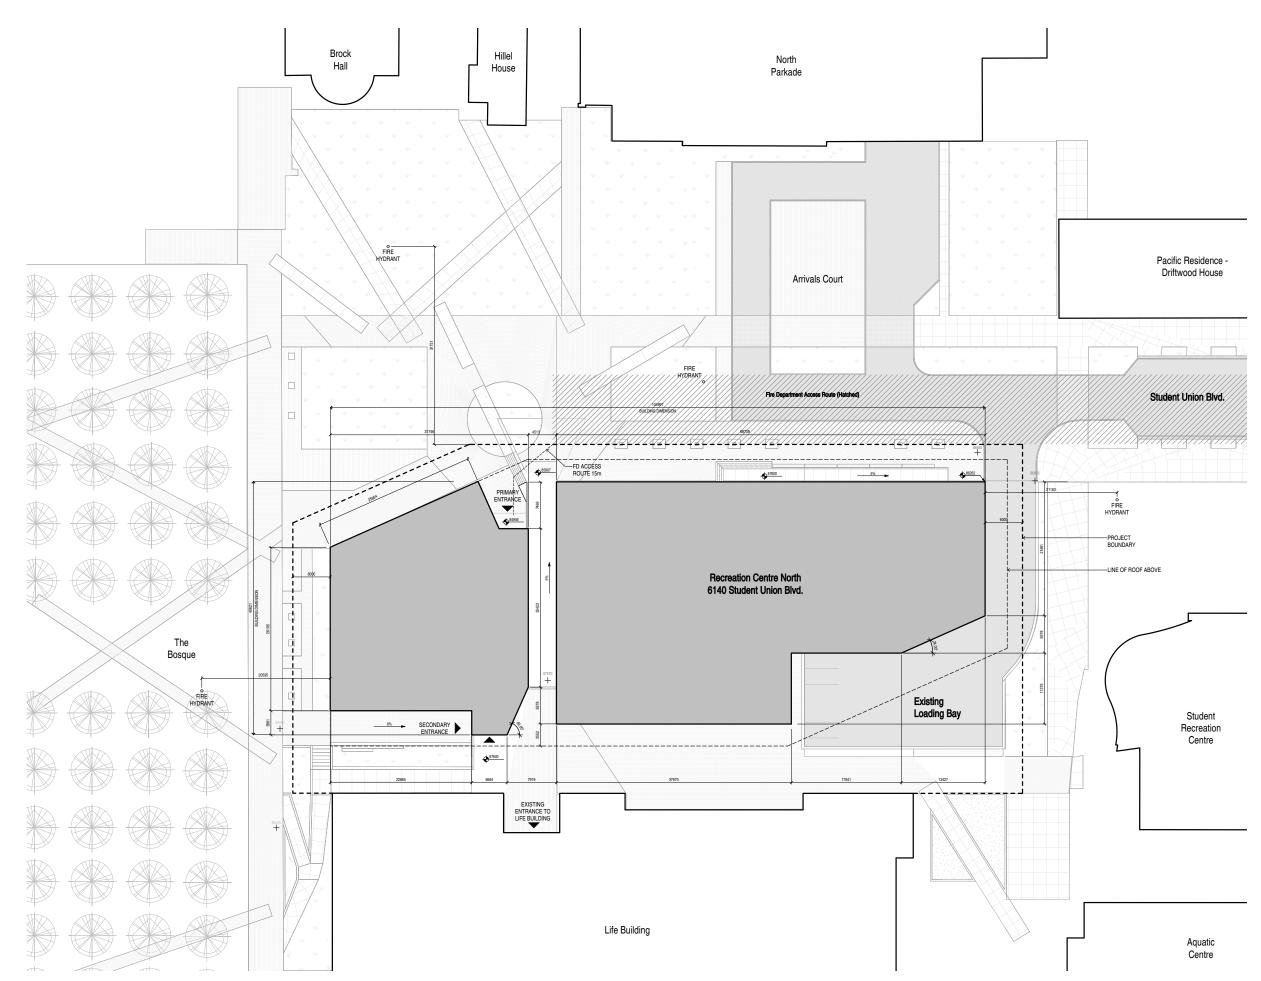





STAMP

ISSUED / REVISIONS NO DESCRIPTION DATE 1 Issued for Development Permit 210301

#### **Recreation Centre North**

6140 Student Union Blvd.


#### Site Plan

DATE DRAWN BY CHECKED BY SCALE JOB NUMBER 1 March 2021 MBHUW NS/AT As indicated 2008

A1.02

eation Centre North March 2021

**UBC Recr** 

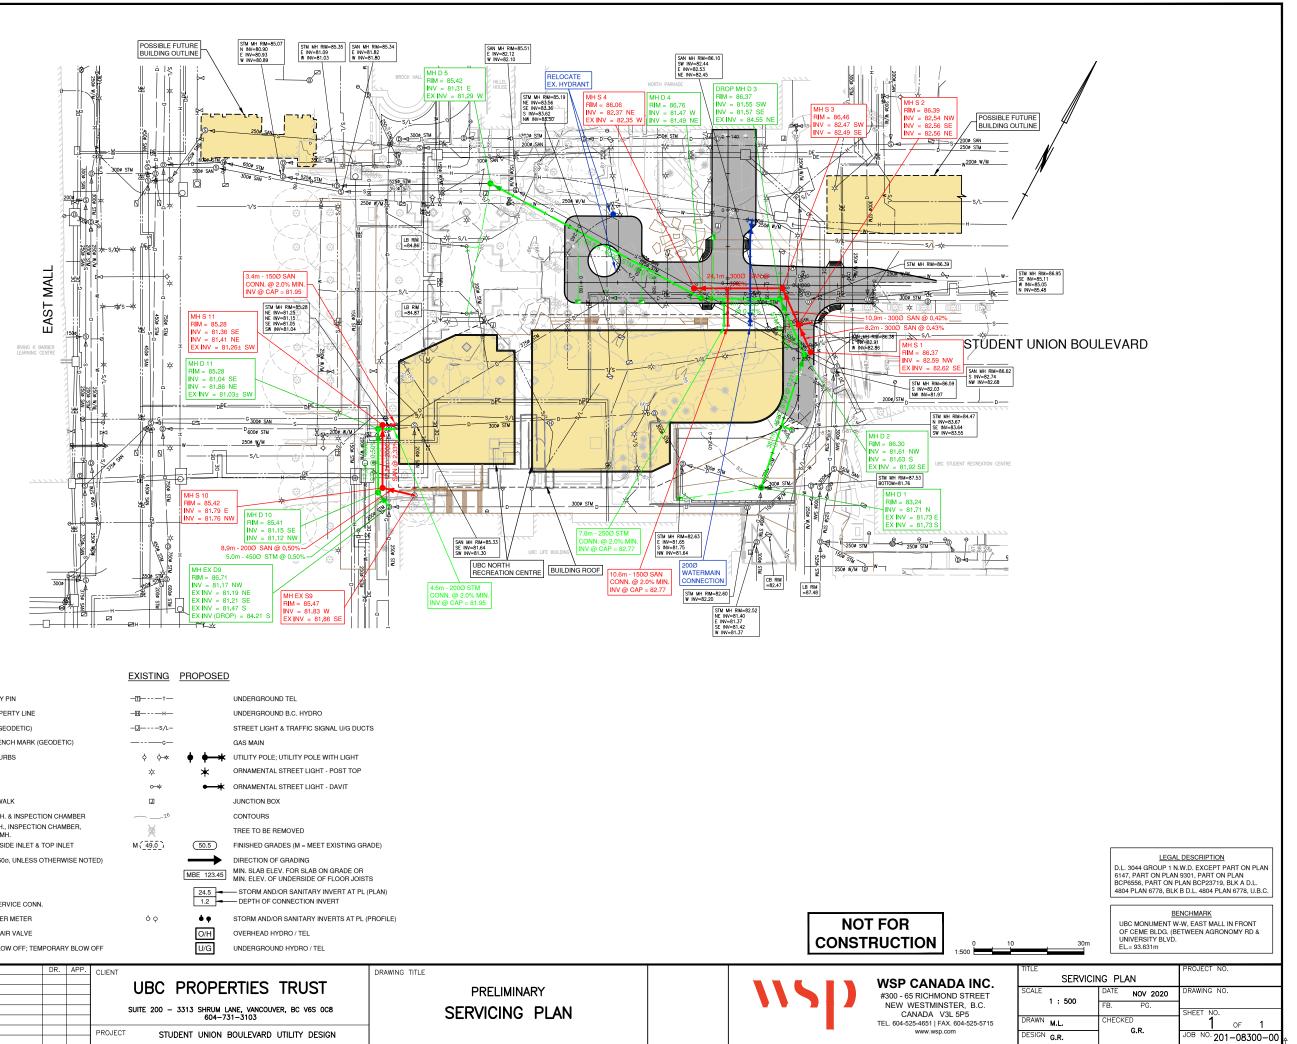


#### LEGEND OF SYMBOLS


#### EXISTING PROPOSED IRON PROPERTY PIN REMOVED PROPERTY LINE G BENCH MARK (GEODETIC) TEMPORARY BENCH MARK (GEODETIC) PAVEMENT & CURBS ---- GRAVEL SIDEWALK ASPHALT SIDEWALK \_\_\_\_\_ ل\_ی⊲\_ - SAN. SEWER, MH. & INSPECTION CHAMBER STM SEWER, MH., INSPECTION CHAMBER, & SLOTTED LID MH. -**⊳**@-0 CATCH BASIN - SIDE INLET & TOP INLET . LAWN BASIN (450ø, UNLESS OTHERWISE NOTED) DITCH $\sim \sim$ $\sim$ SWALE WATERMAIN; SERVICE CONN. HYDRANT; WATER METER -0-WATER VALVE; AIR VALVE PERMANENT BLOW OFF; TEMPORARY BLOW OFF DATE

2021 eation Centre North March Recr UBC

57

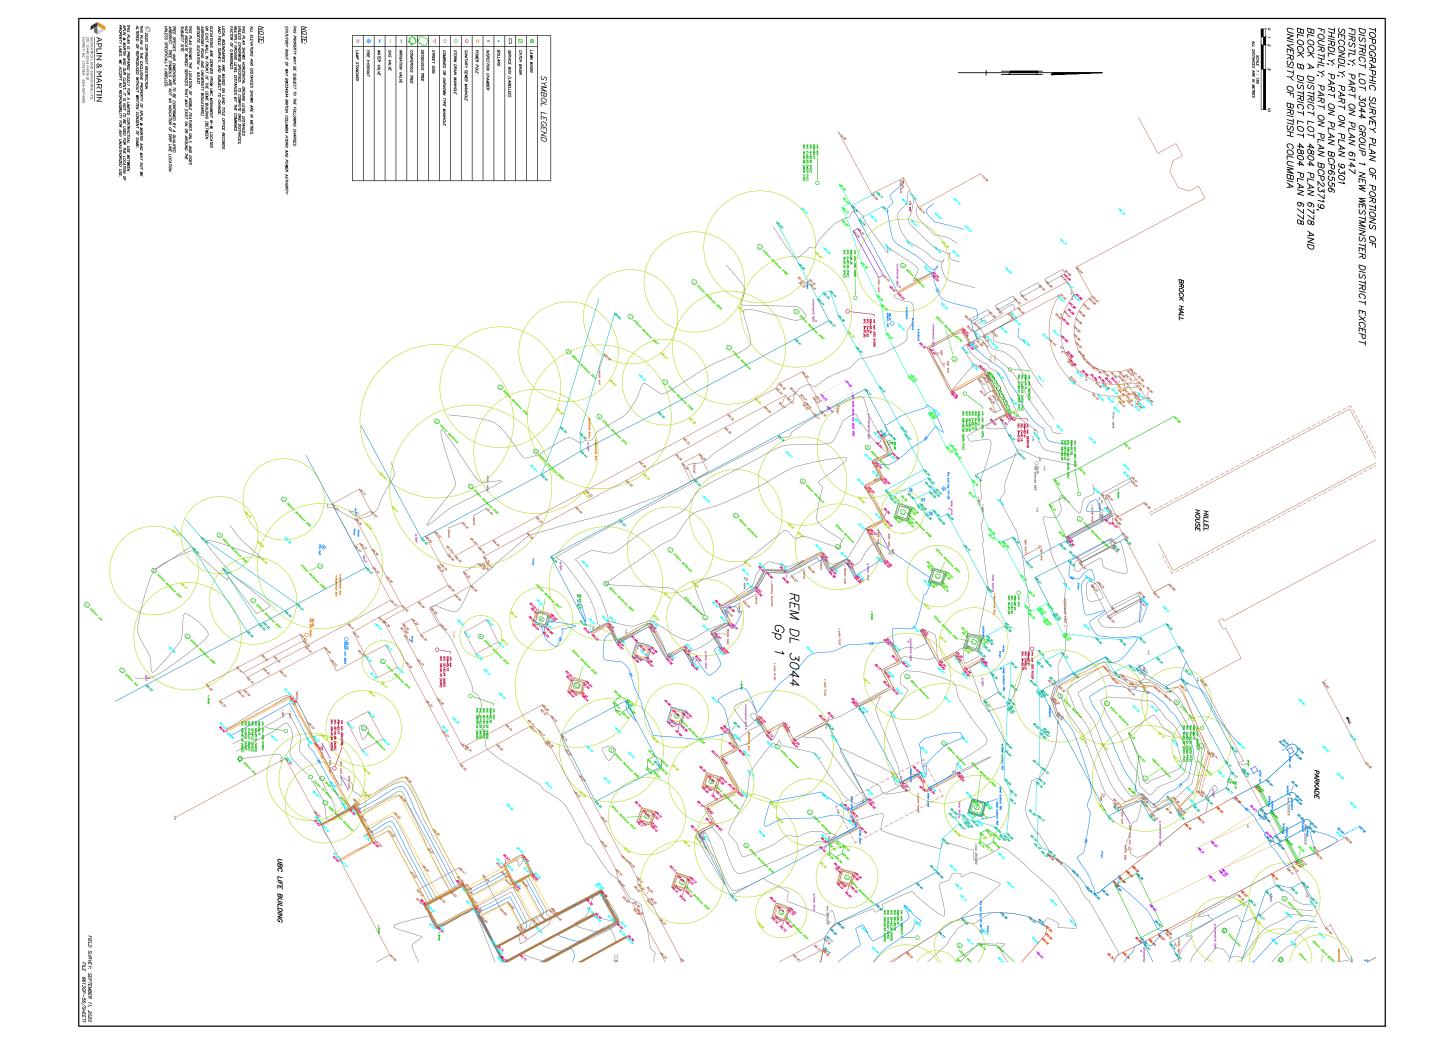




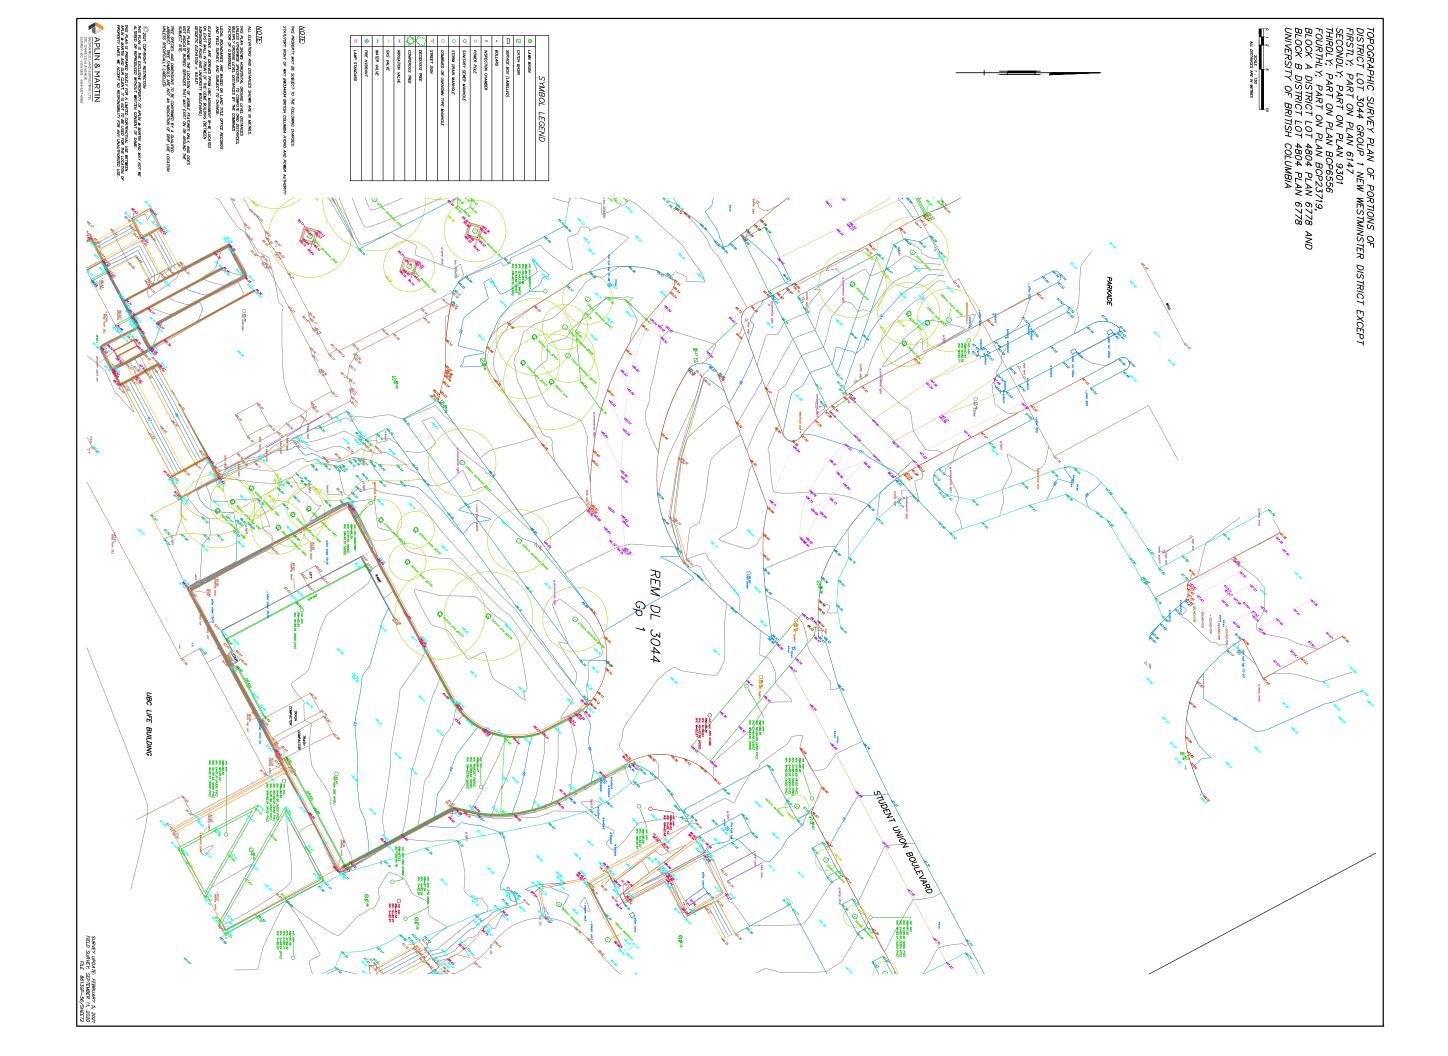



Development Permit Application UBC Recreation Centre North March 2021





Development Permit Application UBC Recreation Centre North March 2021

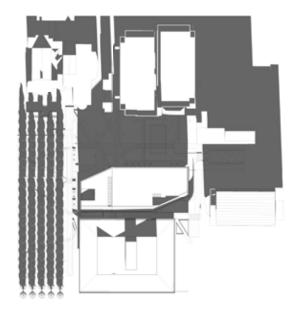

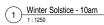

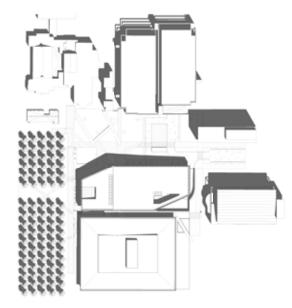


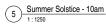

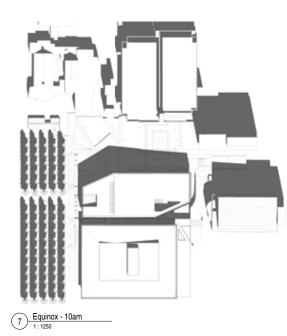




2 Winter Solstice - 12pm 1 : 1250

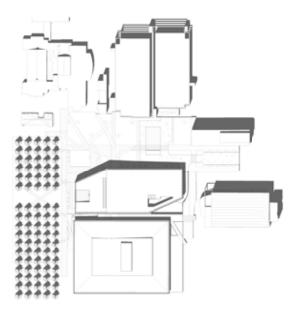


6 Summer Solstice - 12pm 1:1250

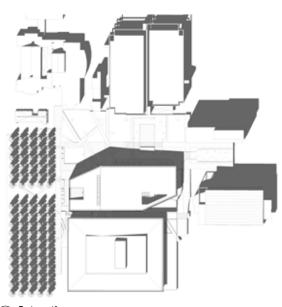


8 Equinox - 12pm



3 Winter Solstice - 2pm 1:1250

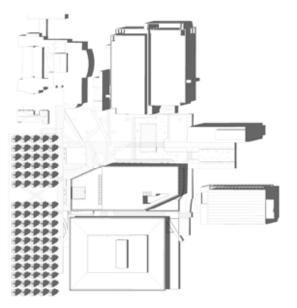

4 Summer Solstice - 2pm 1 : 1250

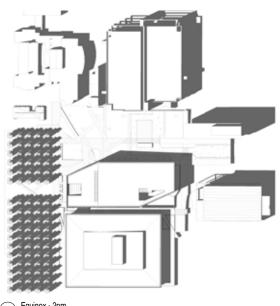

9 Equinox - 2pm 1 : 1250



#### 534 WEST PENDER STREET VANCOUVER, BC CANADA V6B 1/V8

TEL: (604) 687-4457 EMAIL: info@shapearchitecture.ca WEB: www.shapearchitecture.ca

EERICE, THIS DRIVING ME DESIGN ARE MID AT ALL TIMES REMAIN THE EXCLUSIVE PR INSCTURE INC. AND MAY NOT BE USED OR REPRODUCED WITHOUT THEIR WRITTEN COM

THE UNIVERSITY OF BRITISH COLUMBIA

GENERAL NOTES:

STAMP

ISSUED / REVISIONS NO DESCRIPTION

DATE


#### **Recreation Centre North**

6140 Student Union Blvd.

#### Solar Studies

DATE	1 March 2021
DRAWN BY	MBH/JW
CHECKED BY	NS/AT
SCALE	
JOB NUMBER	2008

A0.04

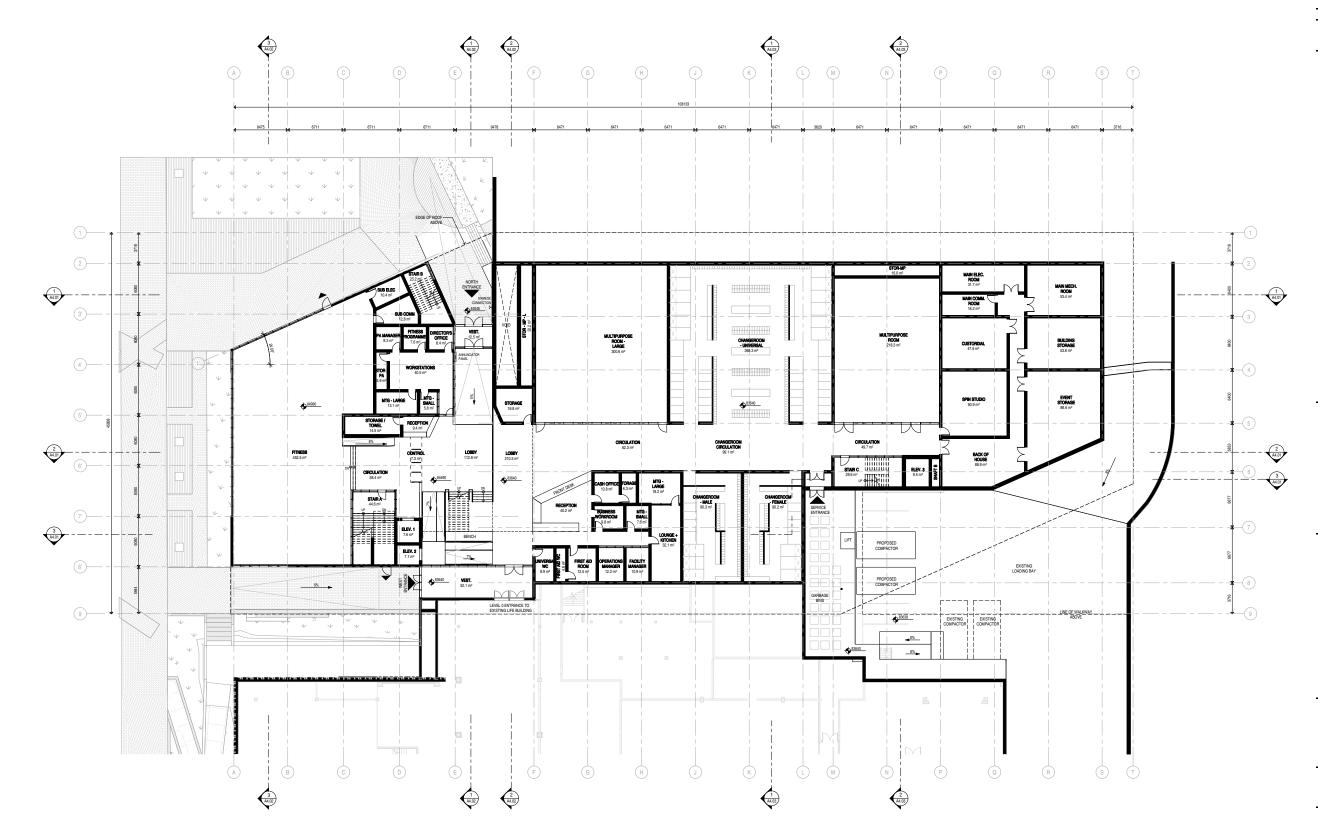

1 Level 0











GENERAL NOTES:

#### STAMP

ISSUED / REVISIONS NO DESCRIPTION DATE 1 Issued for Development Permit 210301

#### **Recreation Centre North**

6140 Student Union Blvd.

#### Level 0 Plan

- /


DATE	
DRAWN BY	
CHECKED BY	
SCALE	
JOB NUMBER	

1 March 2021 MBHJW NS/AT As indicated 2008

A2.01

UBC Recreation Centre North March 2021 De



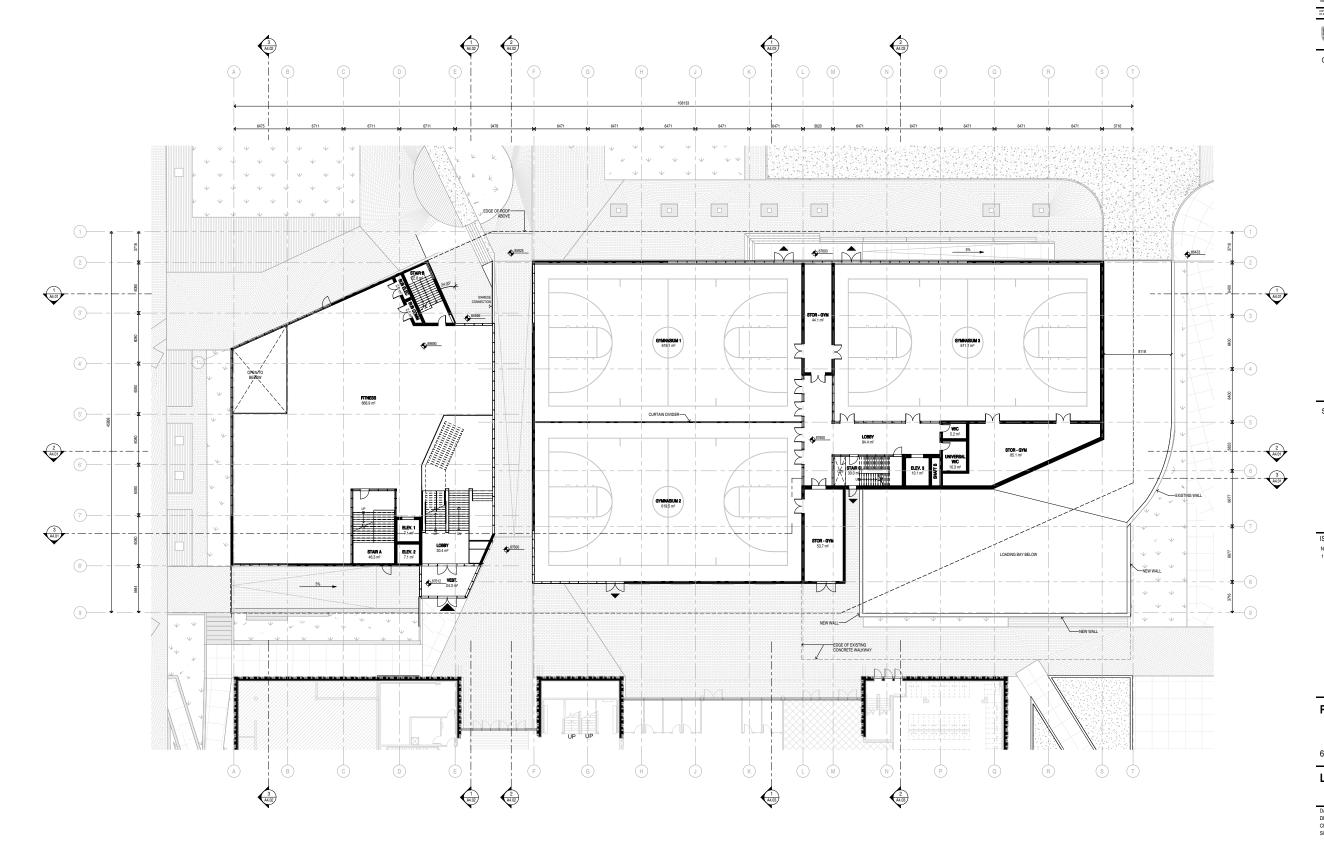

1 Level 1 1:150









GENERAL NOTES:

STAMP

ISSUED / REVISIONS NO DESCRIPTION DATE 1 Issued for Development Permit 210301

#### **Recreation Centre North**

6140 Student Union Blvd.


#### Level 1 Plan

1 March 2021
MBH/JW
NS/AT
As indicated
2008

A2.02

UBC Recreation Centre North March 2021 De



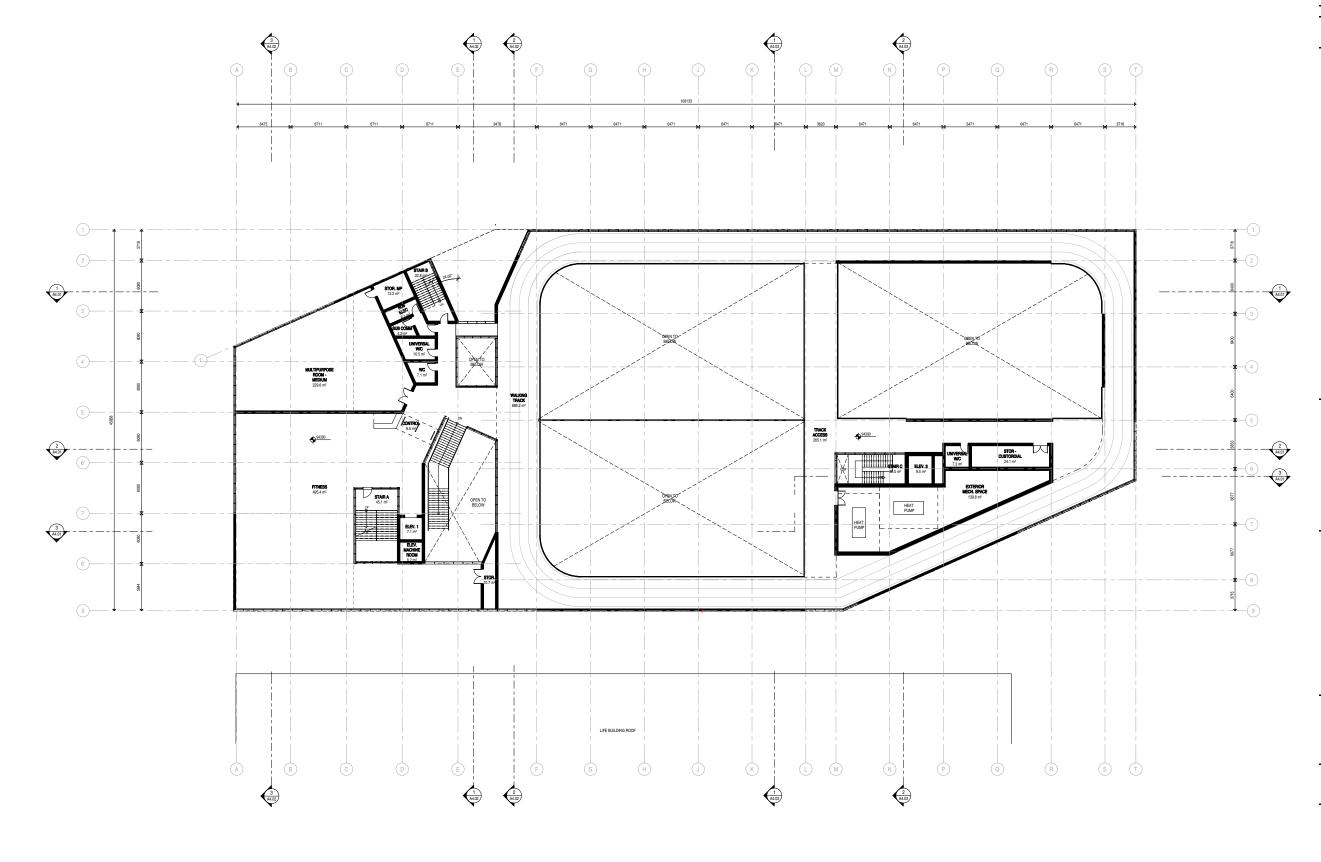

1 Level 2











GENERAL NOTES:

STAMP

ISSUED / REVISIONS NO DESCRIPTION DATE 1 Issued for Development Permit 210301

#### **Recreation Centre North**


6140 Student Union Blvd.

#### Level 2 Plan

DATE	1 March 2021
DRAWN BY	MBH/JW
CHECKED BY	NS/AT
SCALE	As indicated
JOB NUMBER	2008





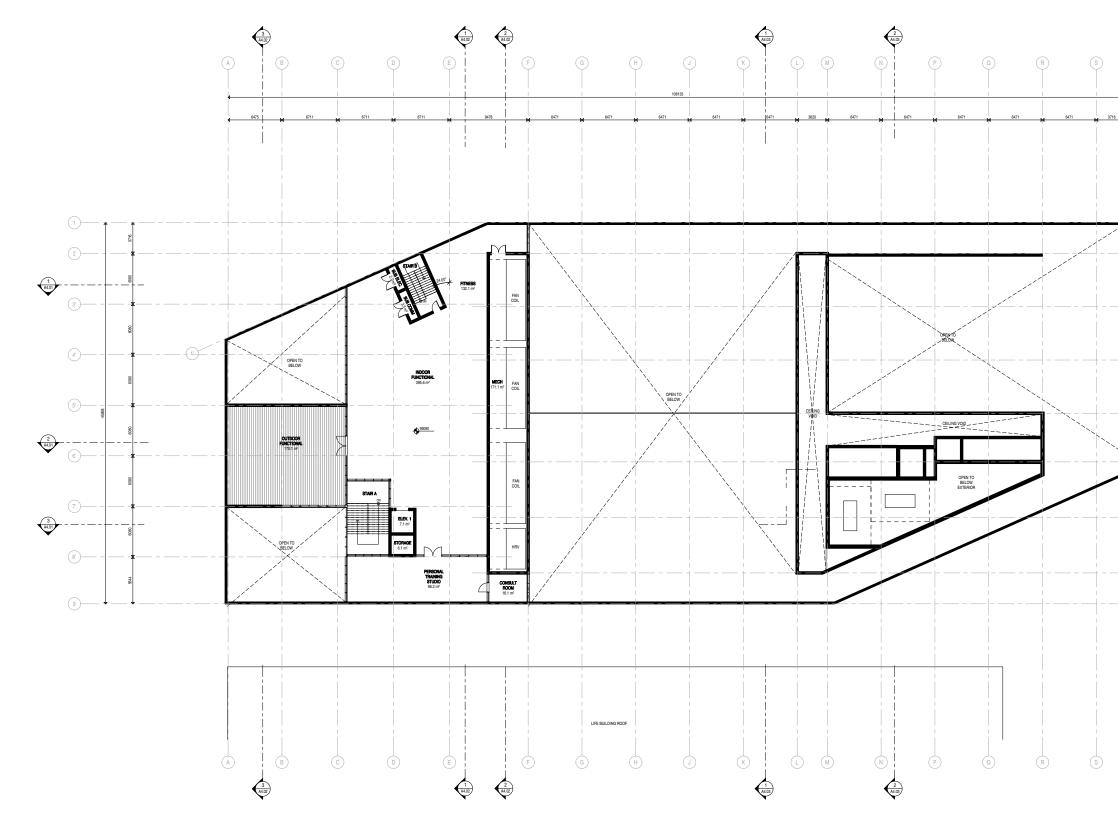

1 Level 3






TEL: (604) 687-4457 EMAL: into 8 shapearchitecture.ca WEB: www.shapearchitecture.ca

HE UNIVERSITY OF BRITISH COLUMBIA

GENERAL NOTES:

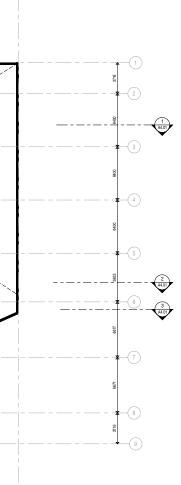

STAMP

ISSUED / REVISIONS NO DESCRIPTION DATE 1 Issued for Development Permit 210301

#### **Recreation Centre North**

6140 Student Union Blvd.


#### Level 3 Plan

DATE	1 March 2021
DRAWN BY	MBH/JW
CHECKED BY	NS/AT
SCALE	As indicated
JOB NUMBER	2008



- /



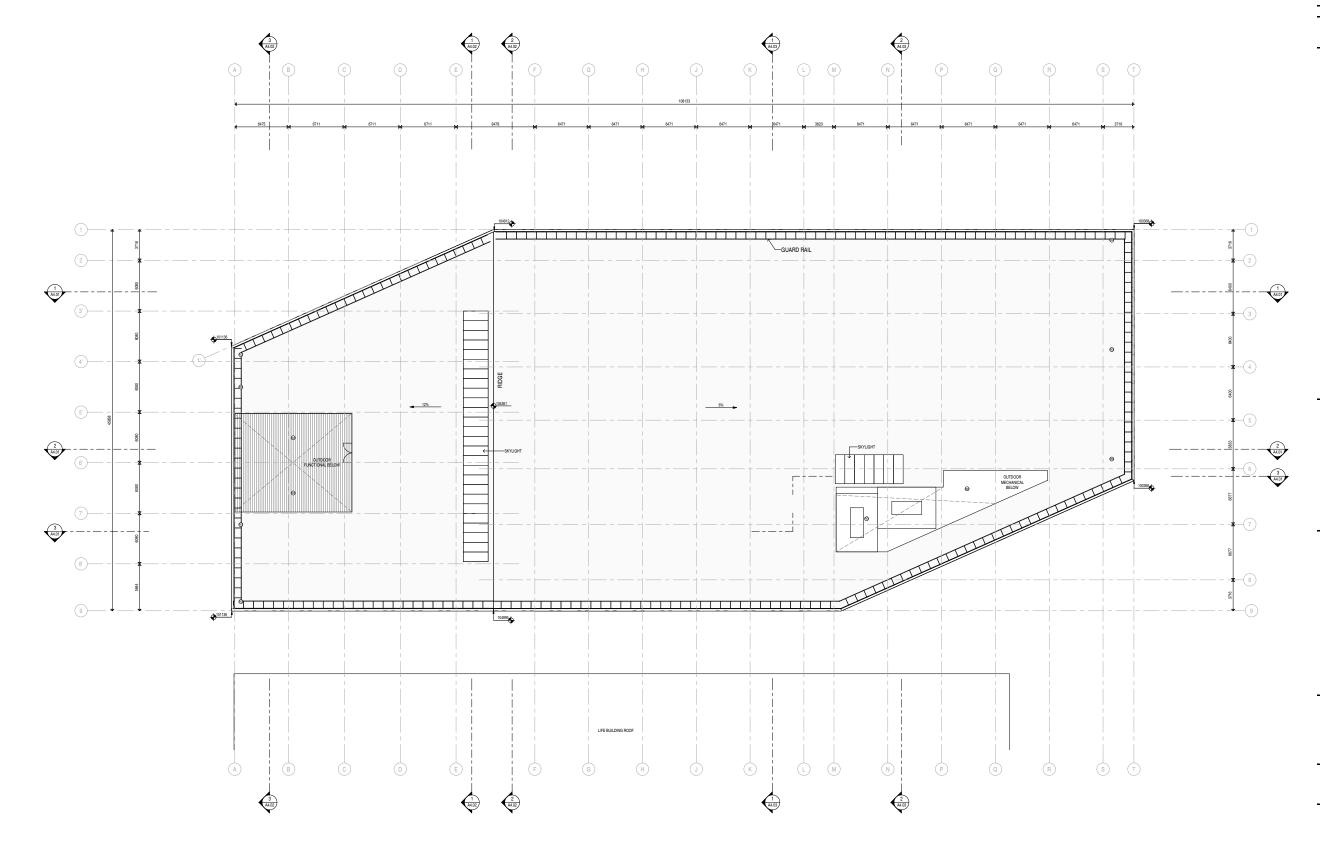

1 Roof 1:150









GENERAL NOTES:

STAMP

ISSUED / REVISIONS NO DESCRIPTION DATE 1 Issued for Development Permit 210301

#### **Recreation Centre North**

6140 Student Union Blvd.

#### Roof Plan


DATE	1
DRAWN BY	
CHECKED BY	
SCALE	
JOB NUMBER	

1 March 2021 MBH/JW NS/AT As indicated 2008







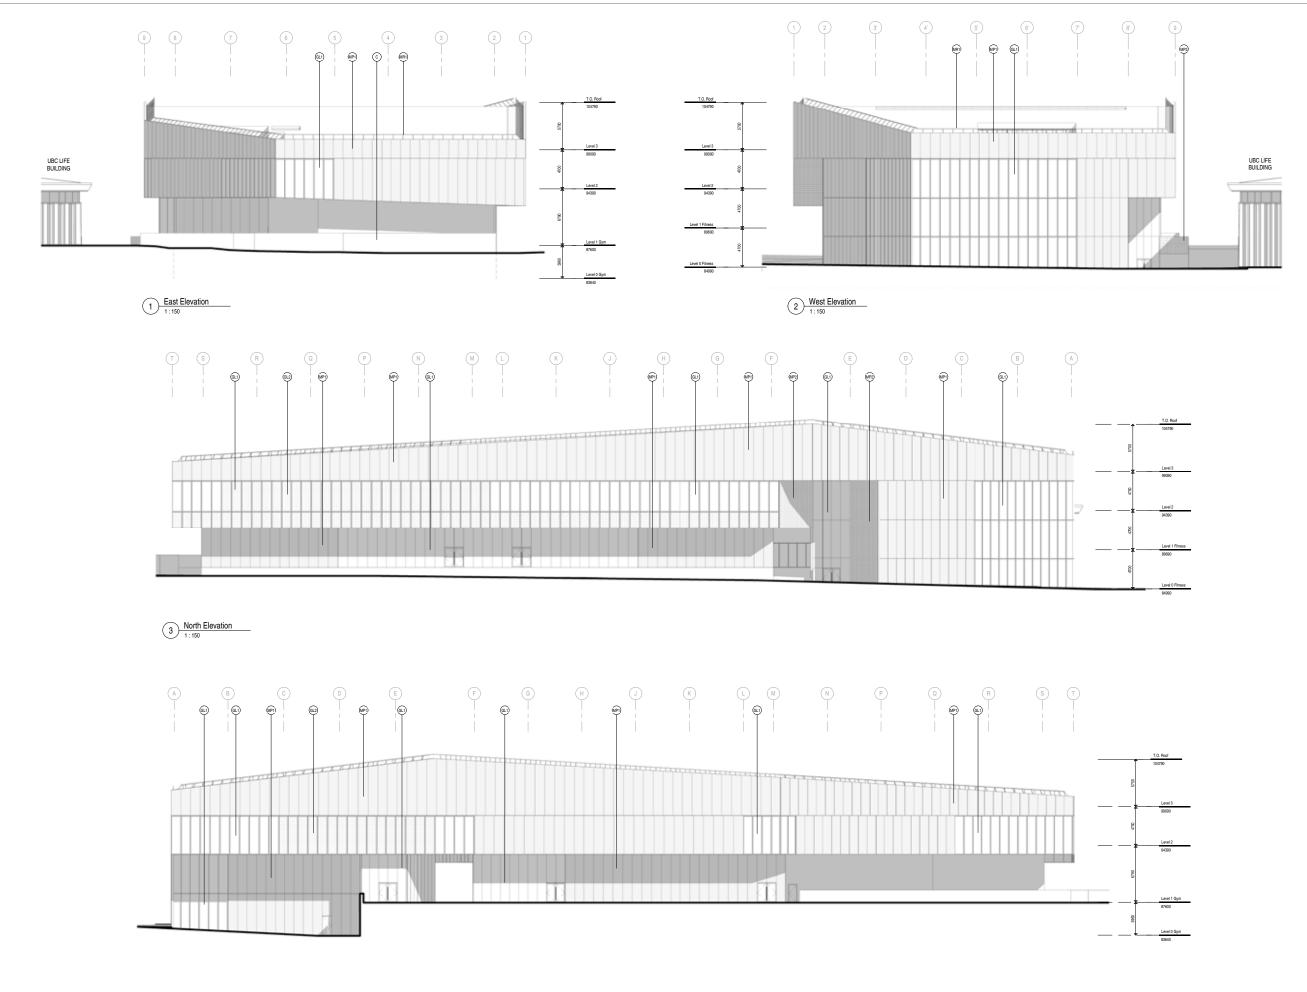

4 South Elevation



#### 534 WEST PENDER STREET VANCOUVER, BC CANADA V6B 1V8

TEL: (804) 687-4457 EMAIL: info@shapearchitecture.ca WEB: www.shapearchitecture.ca

I RESERVED. THIS DEVANIS AND DESIGN ARE AND AT ALL TAKES REMAY THE EXCLUSIVE PROPERTY. REHITECTURE NO, AND MAY NOT BE USED OR REPRODUCED WITHOUT THEIR WRITTEN CONSENT.

THE UNIVERSITY OF BRITISH COLUMNIA

#### GENERAL NOTES:

	Material Legend	
	Material	
С	CONCRETE	
GL1	TRANSPARENT GLAZING	
GL2	TRANSLUCENT GLAZING	
MP1	METAL PANEL	
MP2	METAL GRATE	
MR1	METAL RAILING	



ISSUED / REVISIONS NO DESCRIPTION


IPTION DATE


#### **Recreation Centre North**

6140 Student Union Blvd.


#### **Building Elevations**


MBH/JW
NS/AT
1:150

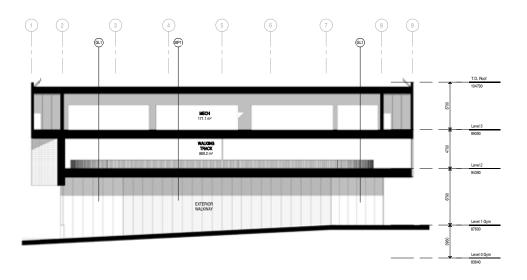


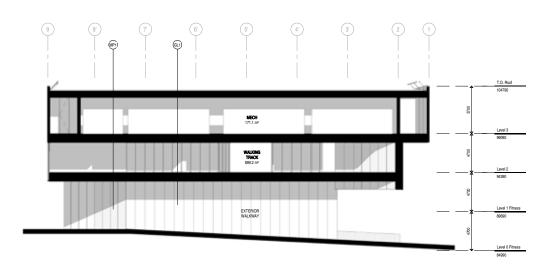

2 East Elevation - North South Walkway Cut 1:150

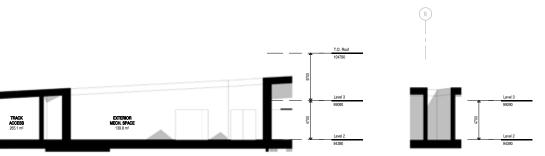

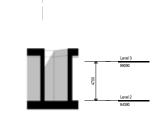

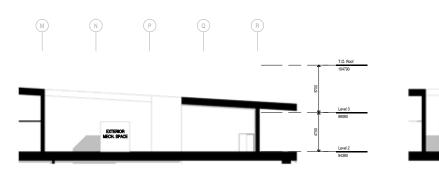



3 Northeast Elevation - Mech

1 West Elevation - North South Walkway Cut

8 West Elevation - Mech

4 South Elevation - Mech

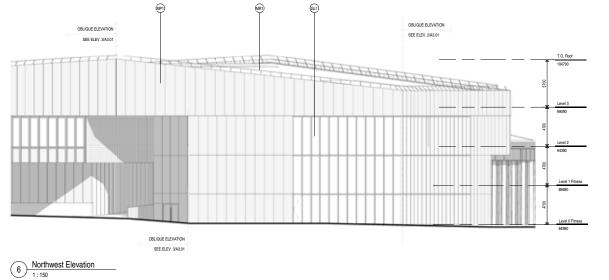

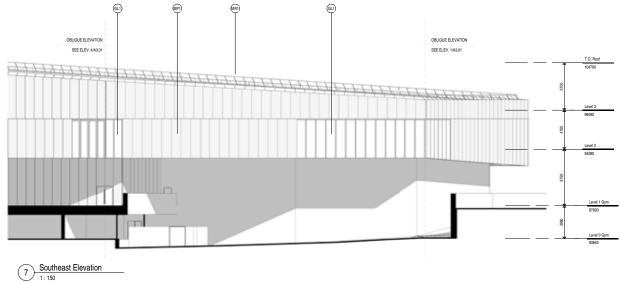

#### SHAPE Architecture Inc


#### 534 WEST PENDER STREET VANCOUVER, BC CANADA V6B 1V8

TEL: (604) 687-4457 EMAIL: info@ shapearchitecture.ca WEB: www.shapearchitecture.ca

THE UNIVERSITY OF BRITISH COLUMBIA

#### GENERAL NOTES:

	Material Legend	
1	Material	
С	CONCRETE	
GL1	TRANSPARENT GLAZING	
GL2	TRANSLUCENT GLAZING	
MP1	METAL PANEL	
MP2	METAL GRATE	
MR1	METAL RAILING	

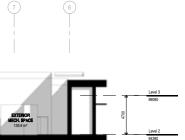

#### 5 East Elevation - Mech

#### STAMP

ISSUED / REVISIONS NO DESCRIPTION

DATE

#### **Recreation Centre North**


6140 Student Union Blvd.

#### **Partial Elevations**


DATE	
DRAWN BY	
CHECKED BY	
SCALE	
JOB NUMBER	


March 2021 MBH/JW NS/AT 2008



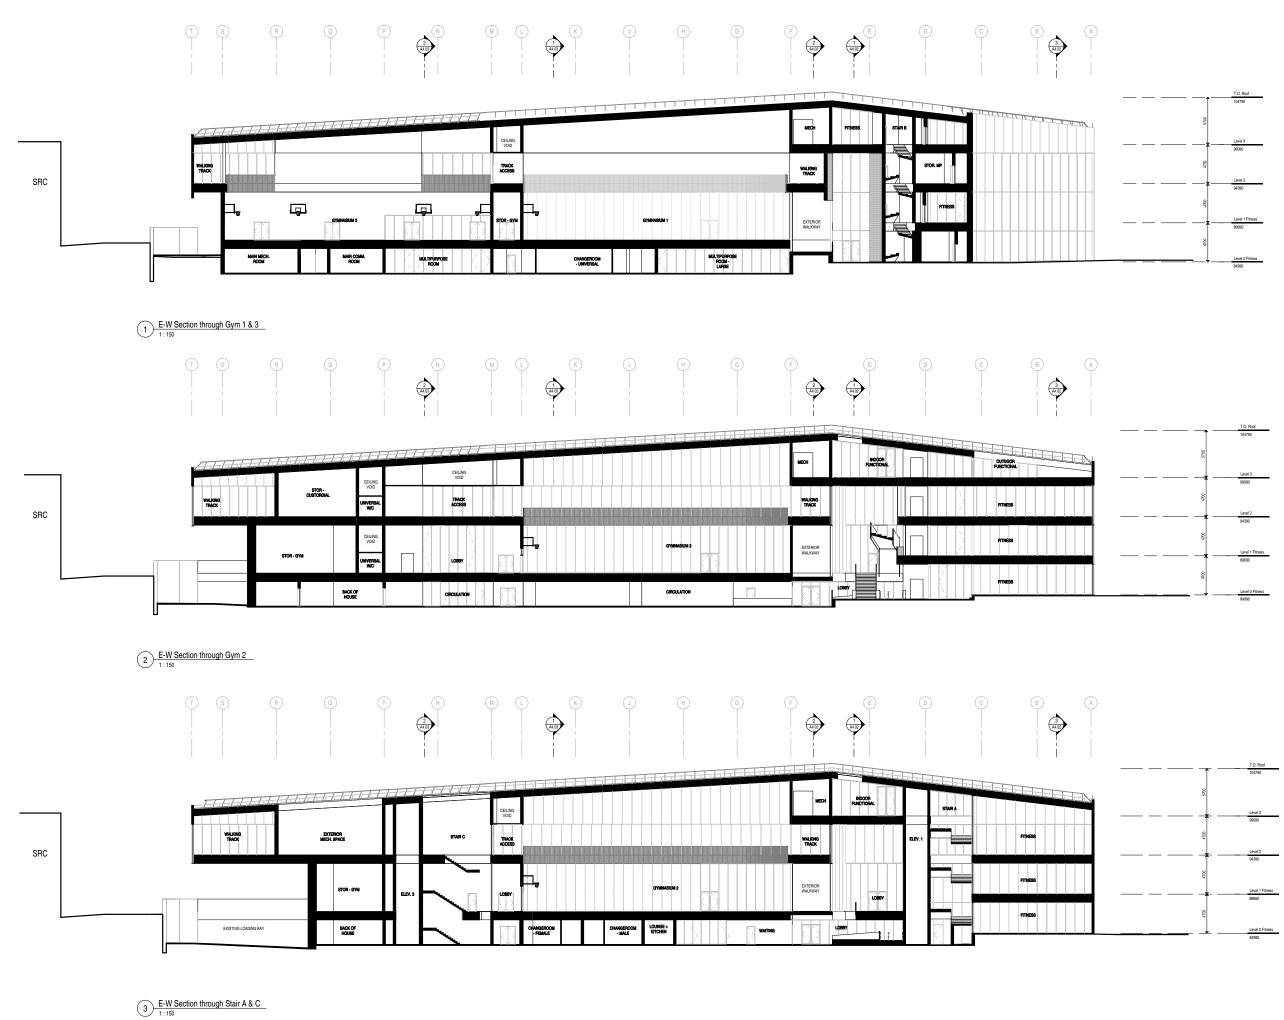



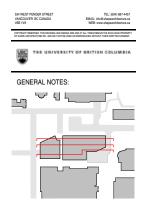

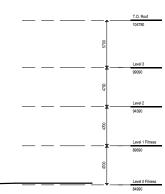



ISSUED / REVISIONS NO DESCRIPTION

DATE


#### **Recreation Centre North**

6140 Student Union Blvd.

#### Sections E-W

DATE	1 March 202
DRAWN BY	MBH/J
CHECKED BY	NS/A
SCALE	
JOB NUMBER	200

A4.01

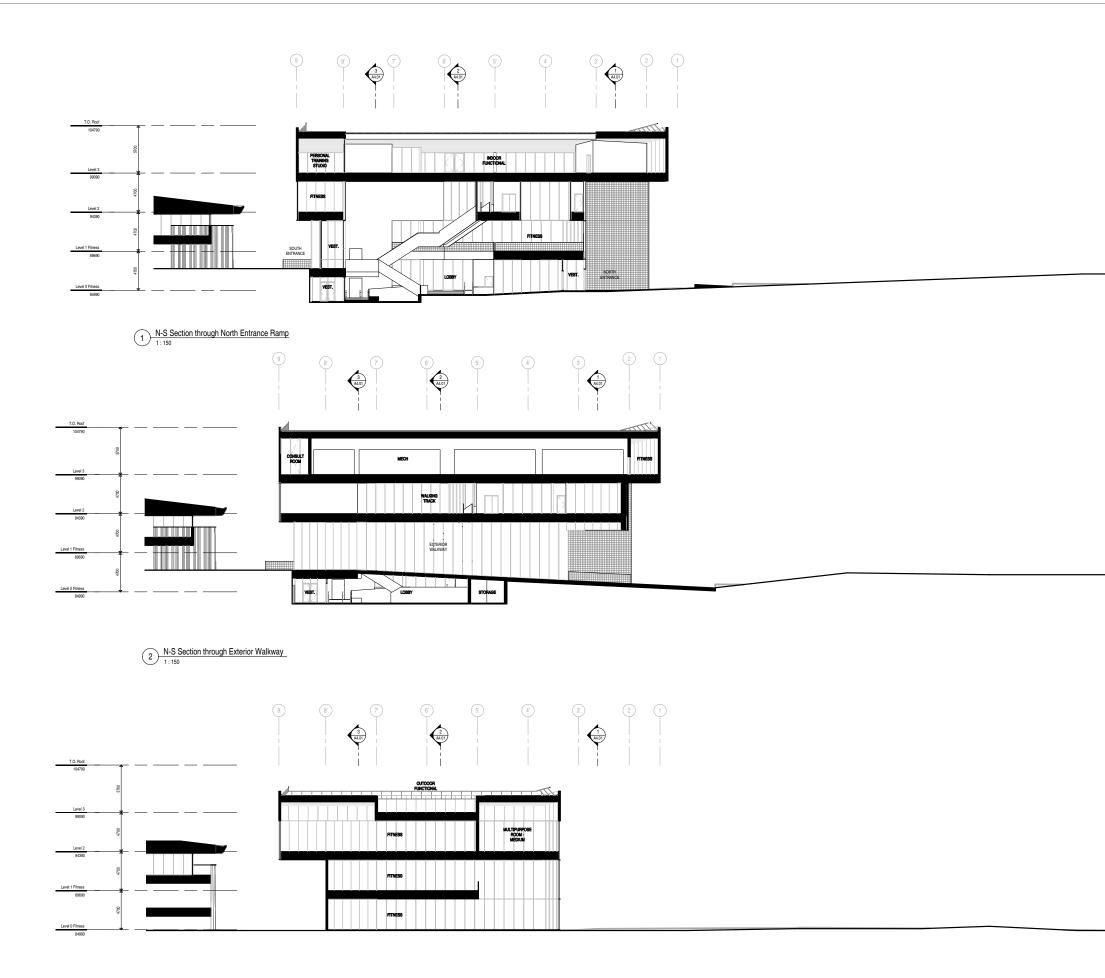

3 N-S Section through Fitness Block





HILLEL HOUSE

> HILLEL HOUSE

STAMP

ISSUED / REVISIONS NO DESCRIPTION

DN DATE

HILLEL

#### **Recreation Centre North**

6140 Student Union Blvd.

#### Sections N-S

DATE	1 March 2021
DRAWN BY	MBH/JW
CHECKED BY SCALE	NS/AT
00.00000	0000
JOB NUMBER	2008





2 N-S Section through Gym 3 & Loading Bay 1:150





STAMP

NORTH PARKAD

ISSUED / REVISIONS NO DESCRIPTION

DATE

#### **Recreation Centre North**

6140 Student Union Blvd.

#### Sections N-S

DATE	1 March 2021
DRAWN BY	MBH/JW
CHECKED BY	NS/AT
SCALE	As indicated

A4.03

UBC Recreation Centre North March 2021 loi ent De





#### UBC PROPERTIES TRUST DIALOG®

#### **UNIVERSITY OF BRITISH COLUMBIA** NORTH RECREATION CETRE


LANDSCAPE ARCHITECTURE ISSUED FOR DEVELOPMENT PERMIT

FEBRUARY 26, 2021

#### DRAWING LIST - LANDSCAPE ARCHITECTURE Sheet Number Sheet Name

L0.00	COVER SHEET
L0.01	DEMOLITION & TREE MANAGEMENT PLAN
L1.00	LANDSCAPE CONTEXT PLAN
L1.01	OVERALL SITE LANDSCAPE PLAN
L2.00	OVERALL SITE GRADING PLAN
L3.00	OVERALL SITE CONCEPT LIGHTING PLAN
L4.00	CONCEPT SITE PLANTING PLAN
L4.01	CONCEPT SITE IRRIGATION PLAN
L5.00	SITE SECTIONS & ELEVATIONS
L5.01	PERSPECTIVE VIEWS



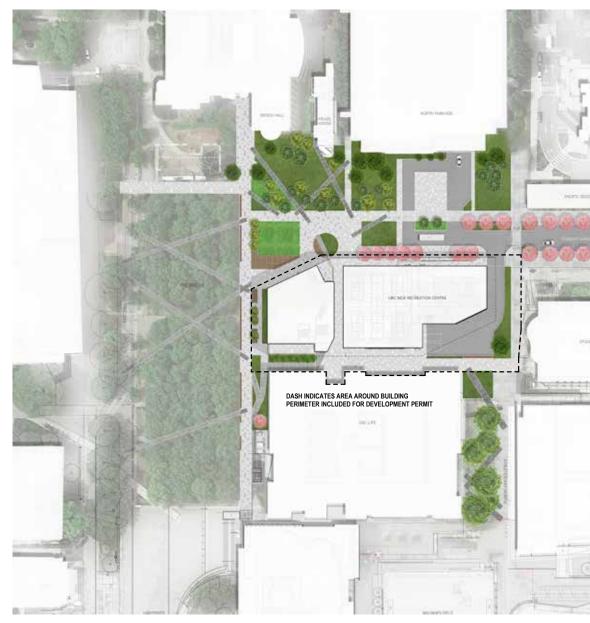



### DIALOG®

#### ISSUED FOR

2021-02-26 Issue for Development Permit

#### METRIC

THIS DRAWING IS COPYRIGHTED AND MUST NOT BE USED REPRODUCED, OR REVISED WITHOUT WRITTEN PERMISS ALL DIMENSIONS ARE IN MILL NOTED. VERIFY DIMENSIONS. DO NOT SCALE THIS DRAWING

REPORT INCONSISTENCIES FOR CLARIFICATION BEFOR

ARCHITECT & PRIME CONS SHAPE Architecture Inc. 534 West Pender Street Vancouver, BC V6B 1V8 Tel: (604) 687-4457 Fax: CIVIL ENGINEER WSP

WSP 840 Howe Street, #1000 Vancouver, BC V6Z 2M1 Tel: (604) 685-9381 Fax: 
 The information of the infor

PBX Engineering Ltd. 300-131 Water Street Vancouver BC, V6B 4M3 Tel: (604)408-7222




UBC NORTH RECREATION CENTRE

COVER SHEET

DRAWN: Author CHECKED: Checker PLOT DATE: 2/26/2021 10:27:38 AM

L0.00

BC100067 - 2002698 C:RevifiLocal Files/DLG\_BC100067\_LA\_UBC RECREATION CENTRE\_jgodwinAUSRD.rvt

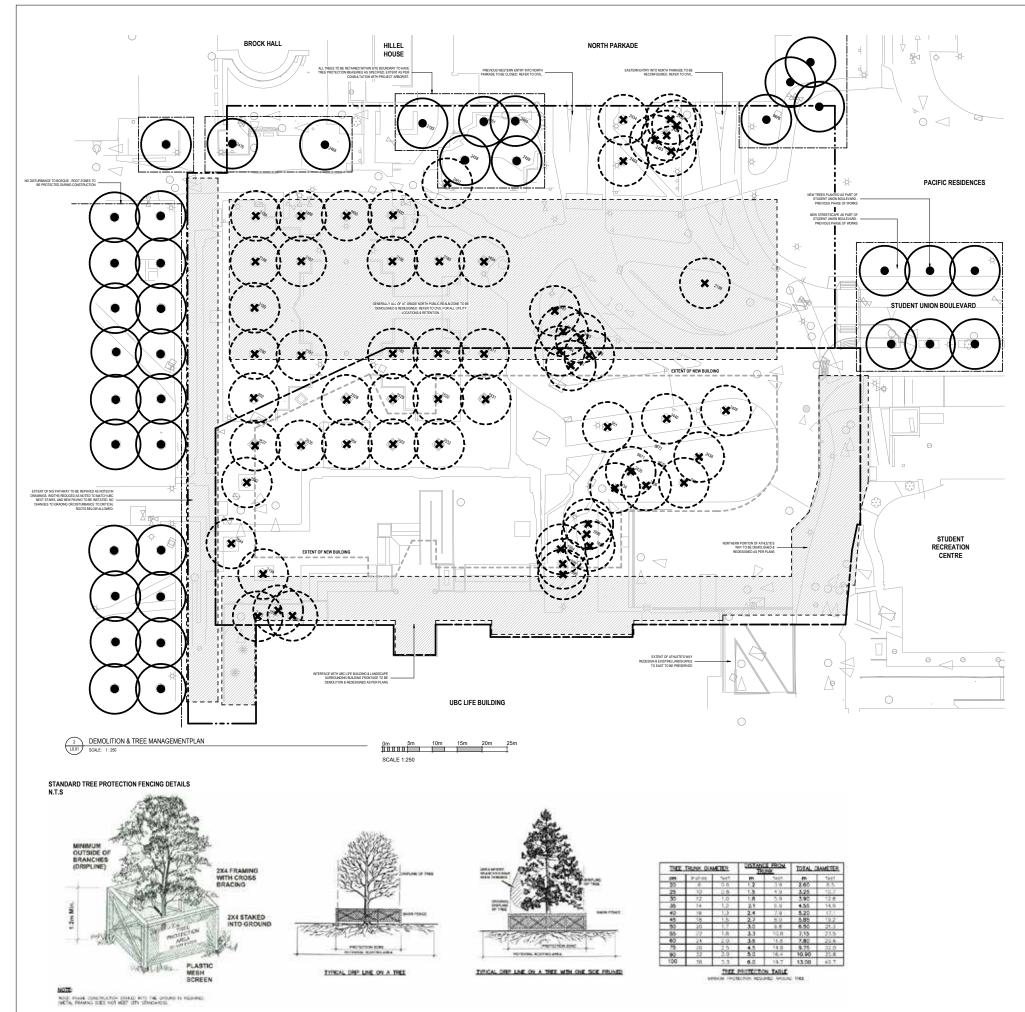



#### LEGEND

PROJECT TRUE SCOPE OF WORK AROUND BUILDING LINE FOR DEVELOPMENT PERMIT

PROJECT SITE BOUNDARY LINE EXCLUDED IN CURRENT DEVELOPMENT PERMIT EXTENTS OF NEW BUILDING LINE × •



EXISTING TREE TO REMAIN AND BE PROTECTED

PROTECTION F COORDINATED WITH UBC TRE

APPROXIMATE LOCATION OF AREAS TO BE DEMOLISHED AND REDESIGNED PER LANDSCAPE DESIGN.

#### DEMOLITION NOTES

- CONTRACTOR TO VERIFY LOCATIONS OF ALL AT-GRADE ELEMENTS LOCATIONS SHOWN ARE INDICATIVE ONLY BASED ON SUPPLIED SURVEY.
- CONTRACTOR TO VERIFY LOCATIONS OF ALL BELOW GRADE SERVICES. REFER TO CIVIL FOR PLAN INDICATING REMOVALS AND RETENTION'S OF ALL EXISTING CIVIL FOR PLAN INDIC/ SERVICING IN AREA.
- CONTRACTOR TO VERIFY AND PROTECT ALL ELEMENTS NOTED AS TO BE RETAINED ANY DAMAGE DURING CONSTRUCTION TO BE REMEDIATED
- ALL DEMOLITIONS WORK TO BE DONE ADJACENT TO TREES INDICATED AS TO BE RETAINED TO BE CONDUCTED IN CONCERT WITH PROJECT ARBORIST.
- DURING DEMOLITION, CONTRACTOR TO VERIFY WITH ARCHITECT ALL REQUIRED STRUCTURES TO BE RETAINED AS RELATED TO ADJACENT, RETAINED BUILDINGS
- ALL ELEMENTS MARKED FOR REMOVAL TO BE SALVAGED OR DISPOSED OFF SITE, UNLESS NOTED OTHERWISE.
- ALL ELEMENTS TO REMAIN ARE TO BE PROTECTED. DAMAGE TO EXISTING SITE ELEMENTS TO BE CORRECTED TO THE SATISFACTION OF THE OWNER AT THE SOLE EXPENSE OF THE CONTRACTOR.
- REMOVAL OF SURFACE ELEMENTS TO INCLUDE COMPLETE ASSEMBLIES AND B. MATERIALS, AND TO MEET DESIGN SUBGRADE, UNLESS NOTED OTHERWISE WI REMOVAL OF COMPLETE ASSEMBLIES FALLS BELOW DESIGN SUBGRADE, BACK TO RESTORE DESIGN SUBGRADE.
- PROTECT AND MAINTAIN EXISTING FIRE HYDRANT(S ACCESSIBLE FOR USE THROUGHOUT ENTIRE DURAT PROJECT, INCLUDING FIRE ACCESS.
- ALL ITEMS NOT DESIGNATED TO BE REMOVED INCLUDING THOSE NOT PROTECTED BY TREE SPECIFICALLY NOTED AS PROTECT IN PLACE

#### TREE PROTECTION NOTES

- TREE PROTECTION FENCING MUST BE BUILT TO STANDARDS SHOWN HERE, OR AS LISTED IN THE ARBORIST REPORT. THE DIMENSIONS SHOWN ARE FROM THE OUTER EDGE OF THE STEM OF THE TREE.
- IN ZONE SHOWN IS A GRAPH CRITCL. ROY CONTRACTOR. STORY IS A UNIVERTIC REPRESENT AT LND OF THE CRITCL. ROY ZONE, MEASURED FROM THE OUTER EDGE OF THE STEM TREE (12 THE TREES DAMETER WAS ADDED TO THE GRAPHICAL TREE PROTECTION CRICLES TO ACCOMMODATE THE SURVEY POINT BEING THE CENTER OF THE TREE). MEASUREMENTS AS PER THE ARBORIST REPORT.
- ANY CONSTRUCTION ACTIVITIES OR GRADE CHANGES WITHIN OR ADJACENT TO THE ROOT PROTECTION ZONE MUST BE APPROVED BY THE PROJECT ARBORIST:
- WILL BE REFINED FURTH

SSUED FOR

2021-02-26 Issue for Development Permit

#### METRIC

THIS DRAWING IS COPYRIGHTED AND MUST NOT BE USED, REPRODUCED, OR REVISED WITHOUT WRITTEN PERMISSION ALL DIMENSIONS ARE IN MILLIMETERS UNLESS O NOTED. VERIFY DIMENSIONS. DO NOT SCALE THIS DRAWING.

REPORT INCONSISTENCIES AND OMISSIONS TO THE CONSUL FOR CLARIFICATION BEFORE COMMENCING WITH THE WORK DEVIATIONS FROM THE CONTRACT DOCUMENTS WITHOUT WRITTEN APPROVAL FROM THE CONSULTANT ARE SUBJECT T CORRECTION AT THE CONTRACTOR'S EXPENSE

ARCHITECT & PRIME CONSULTANT SHAPE Architecture Inc. 534 West Pender Street Vancouver, BC V6B 1V8 Tel: (604) 687-4457

Eav CIVIL ENGINEER WSP 840 Howe Street, #1000 Vancouver, BC V6Z 2M1 Tel: (604) 685-9381 Fax:

LANDSCAPE ARCHITECT DIALOG BC Architecture Engineering Interior 406 -611 Alexander Street Vancouver, BC, V6A 1E1 Tel: (604) 255-1169 Fao: STRUCTURAL ENGINEER VISP 840 Howe Street, #1000 Vancouver, BC V6Z 2M1 Tel: (604)685-9381 Fax:

MECHANICAL ENGINEER 200 – 638 Smithe Street Vancouver, BC V6B 1E3 Tel: (604)684-5995 Fax: ELECTRICAL ENGINEER PBX Engineering Ltd. 300-131 Water Street Vancouver BC, V6B 4M3 Tel: (604)408-7222 KEYPLAN


UBC NORTH RECREATION CENTRE

### DEMOLITION & TREE MANAGEMENT PLAN


DRAWN: Author CHECKED: Checker PLOT DATE: 2/26/2021 10:27:46 AM

## L0.01

BC100067 - 2002698 C:\RevifLocal Files/DLG\_BC100067\_LA\_UBC RECREATION CENTRE\_jgodwinAU5RD.nt 2021 UBC Recreation Centre North March

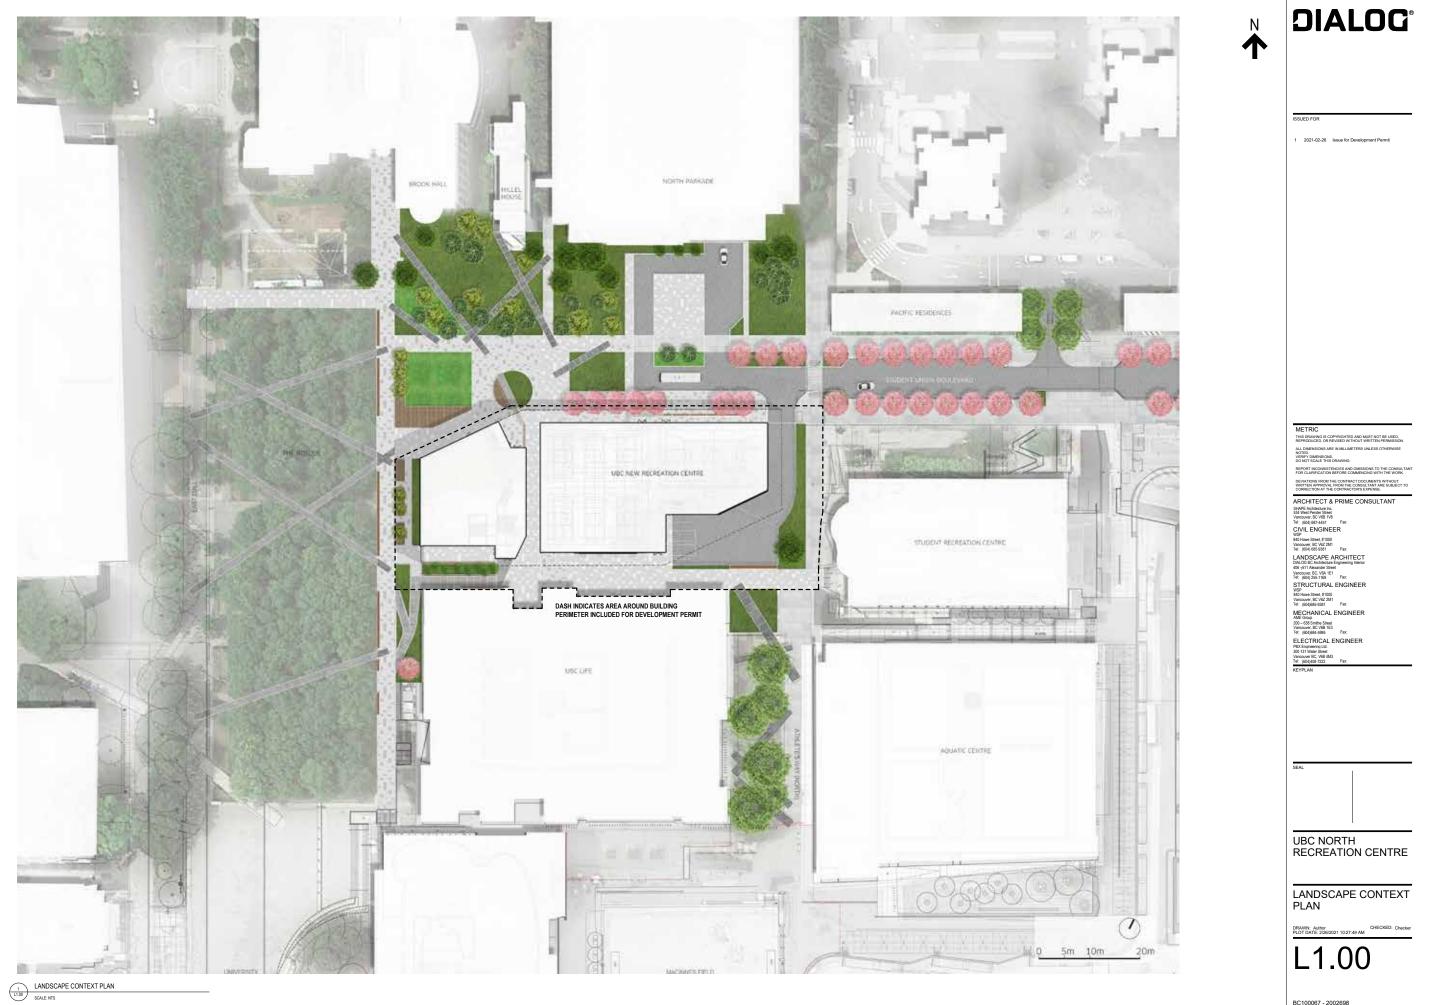

BC100067 - 2002698 C:\RevifLocal Files/DLG\_BC100067\_LA\_UBC RECREATION CENTRE\_igodwinAUSRD.nt

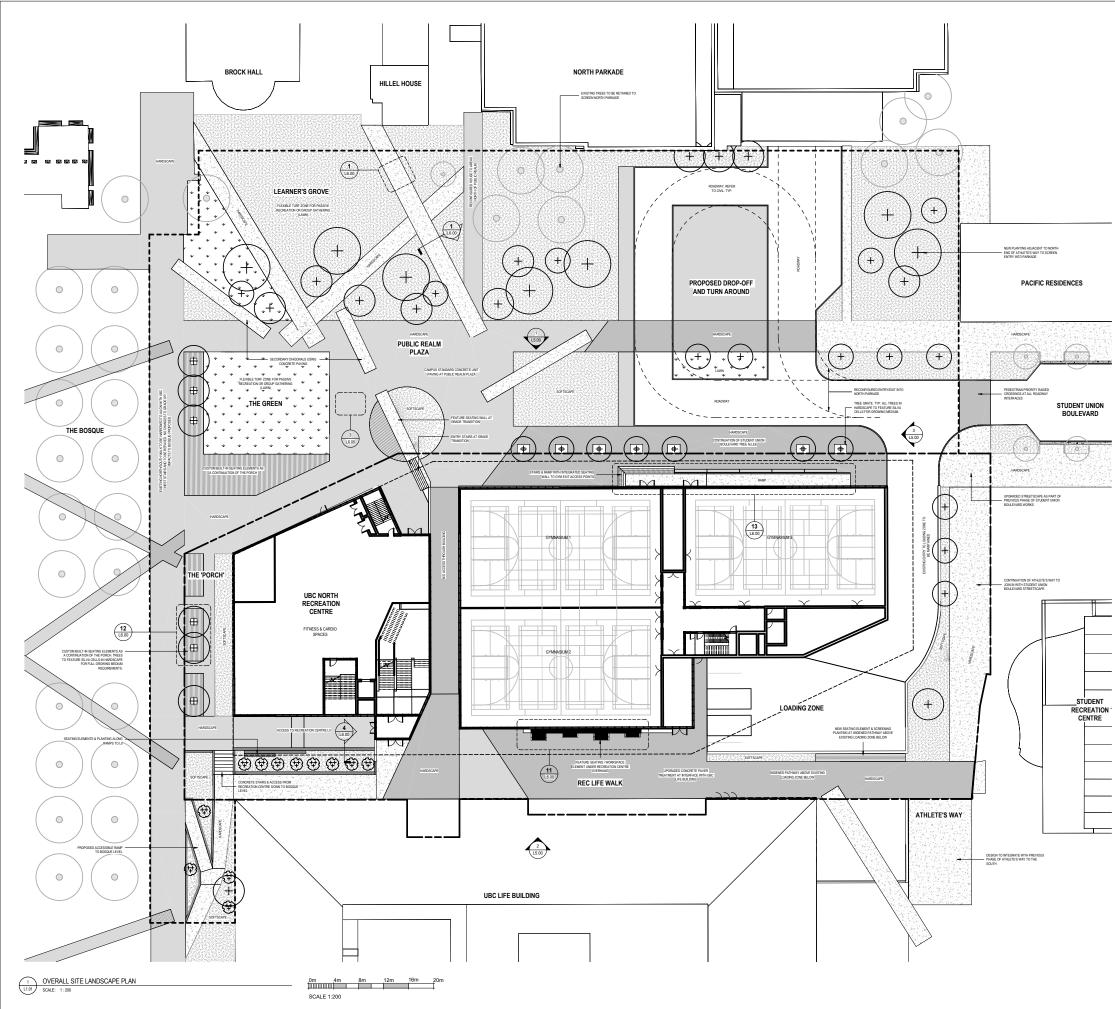





#### LEGEND

PROJECT TRUE SCOPE OF WORK AROUND BUILDING LINE FOR DEVELOPMENT PERMIT

PROJECT SITE BOUNDARY LINE EXTENTS OF NEW BUILDING ROOF ABOVE







UBC CAMPUS STANDARD CONCRETE UNIT PAVING HARDSCAPE AREAS

CONCRETE WALK HARDSCAPE AREAS

EXISTING TREE TO REMAIN AND BE PROTECTED

SOFTSCAPE SURFACE AREAS

CUSTOM BUILT-IN SEATING WOOD SURFACED ELEMENTS

\* \* \* \* \* \* \* \* \*

UBC CAMPUS STANDARD CONCRETE UNIT PAVING TYPE 2 HARDSCAPE AREAS

LAWN SURFACE AREAS

#### SSUED FOR

2021-02-26 Issue for Development Permit

#### METRIC

THIS DRAWING IS COPYRIGHTED AND MUST NOT BE USED, REPRODUCED, OR REVISED WITHOUT WRITTEN PERMISSION ALL DIMENSIONS ARE IN MILLIMETERS UNLESS NOTED. VERIFY DIMENSIONS. DO NOT SCALE THIS DRAWING.

REPORT INCONSISTENCIES AND OMISSIONS TO THE CONSUL FOR CLARIFICATION BEFORE COMMENCING WITH THE WORK DEVIATIONS FROM THE CONTRACT DOCUMENTS WITHOUT WRITTEN APPROVAL FROM THE CONSULTANT ARE SUBJECT TO CORRECTION AT THE CONTRACTOR'S EXPENSE.

ARCHITECT & PRIME CONSULTANT 
 SHAPE Architecture Inc.

 S34 West Pender Street

 Vancouver, EC V98 1V8

 Tel: (604) 687-4457

 F80: CIVIL ENGINEER

 WSP

 840 Howe Street, #1000

 Vancouver, EC V62 2V8

 Vancouver, EC V62 2V8

 Tel: (604) 685-9381

 Fax:
 LANDSCAPE ARCHITECT DIALOS BC Architecture Engineering Interior 406 -611 Alexander Street Vancouver, BC, V6A 1E1 Tel: (604) 255-1169 Fax: 
 16::
 (604) 255-1169
 Fax:

 STRUCTURAL ENGINEER
 WSP

 840 Howe Street, #1000
 Vancouver, BC V62 2011

 Yancouver, BC V62 2011
 Fax:
 200 – 638 Smithe Street Vancouver, BC V6B 1E3 Tel: (604)684-5995 Fax: ELECTRICAL ENGINEER PBX Engineering Ltd. 300-131 Water Street Vancouver BC, V6B 4M3 Tel: (604)408-7222 KEYPLAN



UBC NORTH RECREATION CENTRE

### OVERALL SITE LANDSCAPE PLAN


DRAWN: Author CHECKED: Checker PLOT DATE: 2/26/2021 10:28:01 AM

L1.01

2021 eation Centre North March Recr UBC |

BC100067 - 2002698 C:RevifLocal Files/DLG\_BC100067\_LA\_UBC RECREATION CENTRE\_godwinAUSRD.nt

# 75

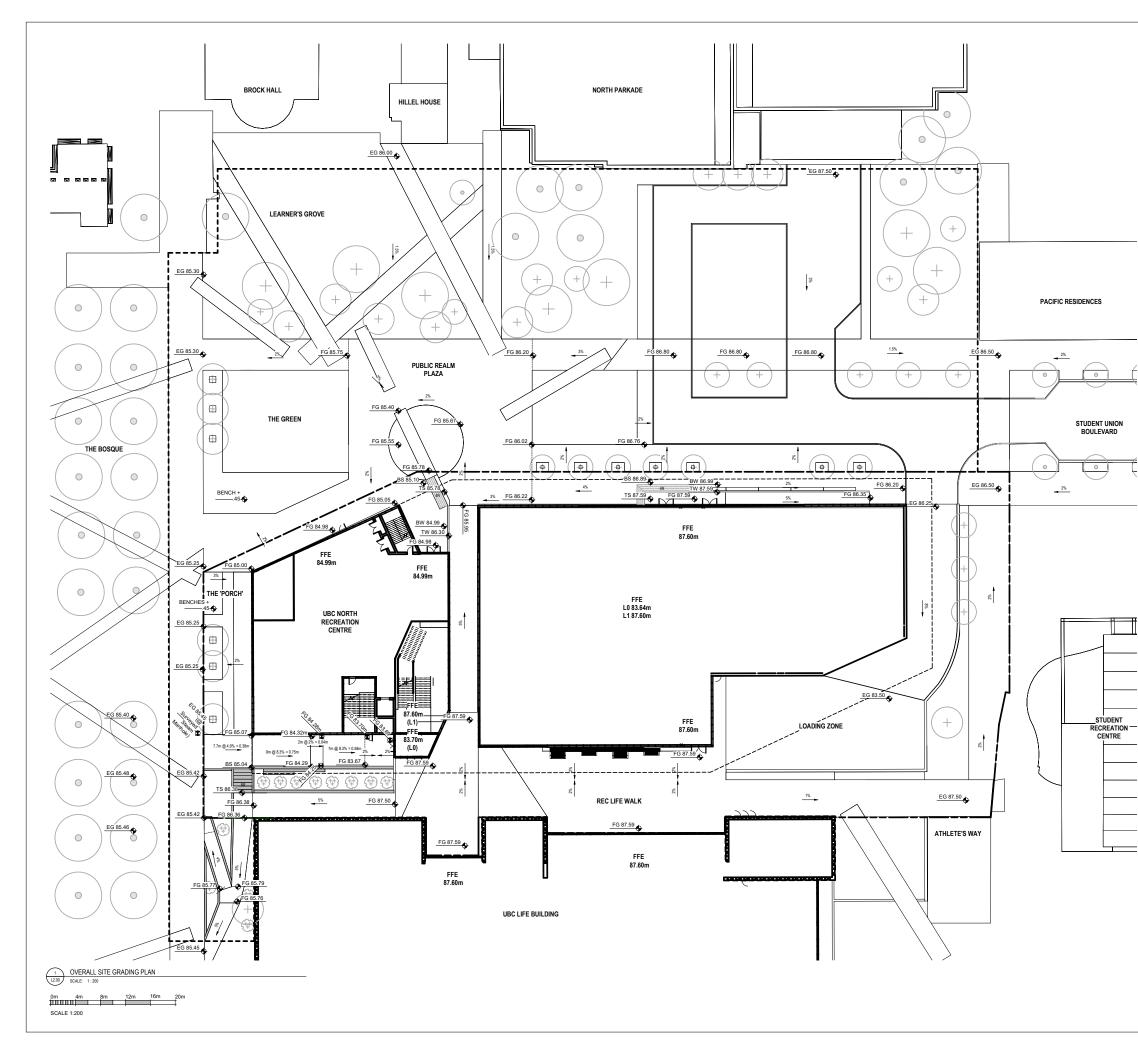



### LEGEND

	-	
	<b></b>	PROJECT TRUE SCOPE OF WORK AROUND BUILDING LINE FOR DEVELOPMENT PERMIT
		PROJECT SITE BOUNDARY LINE EXCLUDED FROM DEVELOPMENT PERMIT
		EXTENTS OF NEW BUILDING ROOF ABOVE
	• EG 60.00	EXISTING GRADE
	◆ <sup>FG 60.00</sup>	PROPOSED FINISHED GRADE
	-	TOP OF CURB
	• <sup>TW 60.00</sup>	TOP OF WALL
	• <sup>BW 60.00</sup>	BOTTOM OF WALL
	◆ <sup>TS 60.00</sup>	TOP OF STAIRS
	•	BOTTOM OF STAIRS
	2%	SLOPE
,	FFE 133.80m	FINISHED FLOOR ELEVATION
Ę	+++++++++++++++++++++++++++++++++++++++	NEW DECIDIOUS TREES

EXISTING TREE TO REMAIN AND BE PROTECTED

 $\bigcirc$ 

## **DIALOG**°

ISSUED FOR

### METRIC

THIS DRAWING IS COPYRIGHTED AND MUST NOT BE USED, REPRODUCED, OR REVISED WITHOUT WRITTEN PERMISSION ALL DIMENSIONS ARE IN MILLIMETERS UNLESS OTHERWISE NOTED. VERRY DMENSIONS. DO NOT SCHLE THIS DRAWING.

DO NOT SCALE THIS DRAWING. REPORT INCONSISTENCIES AND OMISSIONS TO THE CONSULTA FOR CLARIFICATION BEFORE COMMENCING WITH THE WORK. DEVIATIONS FROM THE CONTRACT DOCUMENTS WITHOUT WRITTEN APPROVAL FROM THE CONSULTANT ARE SUBJECT TO CORRECTION AT THE CONTRACTOR'S EXPENSE.

 ARCHITECT & PRIME CONSULTANT

 BUYER Architecto Bits

 Verscover, EC. VIS 10

 <tr




UBC NORTH RECREATION CENTRE

### OVERALL SITE GRADING PLAN

DRAWN: Author CHECKED: Checker PLOT DATE: 2/26/2021 10:28:08 AM

L2.00


### 76

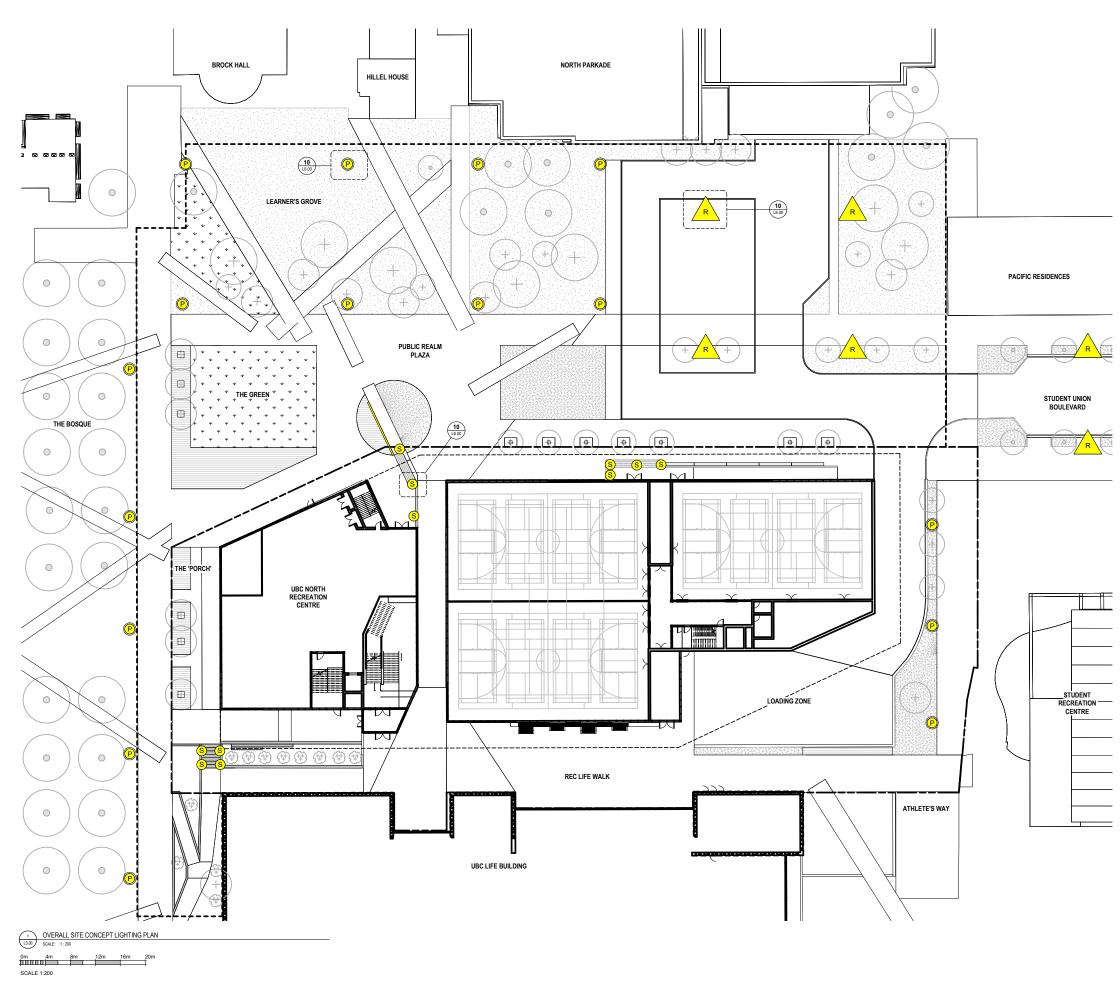

## Ν $\mathbf{\uparrow}$

## **DIALOG**°

#### LEGEND

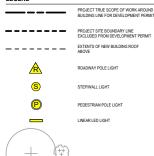



NEW DECIDUOUS TREES

PROJECT SITE BOUNDARY LINE EXCLUDED FROM DEVELOPMENT PERMIT EXTENTS OF NEW BUILDING ROOF ABOVE

ROADWAY POLE LIGHT

PEDESTRIAN POLE LIGHT

STEP/WALL LIGHT

LINEAR LED LIGHT

EXISTING TREE TO REMAIN AND BE PROTECTED

### NOTES

REFER TO ARCHITECTURE FOR ALL BUILDING LIGHTING AND DOWN LIGHTS IN OVERHANG ZORES. THIS PLAN TO BE READ AS A CONCEPT LIGHTING PLAN ONLY, REFER TO ELECTRICAL FOR LIGHTING PLAN. BEEL AND SCAPE ARCHITECTURAL DETALSIMAGES FOR INFORMATION ON INTEGRATING LIGHTING INTO AND SCAPE FEATURE ELEMENTS.

SSUED FOR

2021-02-26 Issue for Development Permit

### METRIC

THIS DRAWING IS COPYRIGHTED AND MUST NOT BE USED, REPRODUCED, OR REVISED WITHOUT WRITTEN PERMISSION REPRODUCED, OR REVISED WITHOUT WRITTEN PE ALL DIMENSIONS ARE IN MILLIMETERS UNLESS OT NOTED. VERIFY DIMENSIONS. DO NOT SCALE THIS DRAWING.

REPORT INCONSISTENCIES AND OMISSIONS TO THE CONSULT FOR CLARIFICATION BEFORE COMMENCING WITH THE WORK. DEVIATIONS FROM THE CONTRACT DOCUMENTS WITHOUT WRITTEN APPROVAL FROM THE CONSULTANT ARE SUBJECT TO CORRECTION AT THE CONTRACTOR'S EXPENSE.

ARCHITECT & PRIME CONSULTANT 
 SHAPE Architecture Inc.

 S34 West Pender Street

 Vancouver, EC V98 1V8

 Tel: (604) 687-4457

 F80: CIVIL ENGINEER

 WSP

 840 Howe Street, #1000

 Vancouver, EC V62 2V8

 Vancouver, EC V62 2V8

 Tel: (604) 685-9381

 Fax:
 LANDSCAPE ARCHITECT DIALOG BC Architecture Engineering Interior 406 -611 Alexander Street Vancouver, BC, V6A 1E1 Tel: (604) 255-1169 Fax: 
 Tel:
 (604) 255-1169
 Fax:

 STRUCTURAL ENGINEER
 WSP

 840 Howe Street, #1000
 Vancouver, BC V62 2011

 Yancouver, BC V62 2011
 Fax:
 MECHANICAL ENGINEER Anic Group 200 – 638 Smithe Street Vancouver, BC V6B 1E3 Tel: (604)684-5995 Fax: ELECTRICAL ENGINEER PBX Engineering Ltd. 300-131 Water Street Vancouver BC, V6B 4M3 Tel: (604)408-7222 KEYPLAN




UBC NORTH RECREATION CENTRE

OVERALL SITE CONCEPT LIGHTING PLAN DRAWN: Author CHECKED: Checker PLOT DATE: 2/26/2021 10:28:14 AM

L3.00

reation Centre North March 2021 **UBC Recr** 

BC100067 - 2002698 C:RevifLocal Files/DLG\_BC100067\_LA\_UBC RECREATION CENTRE\_godwinAUSRD.nt

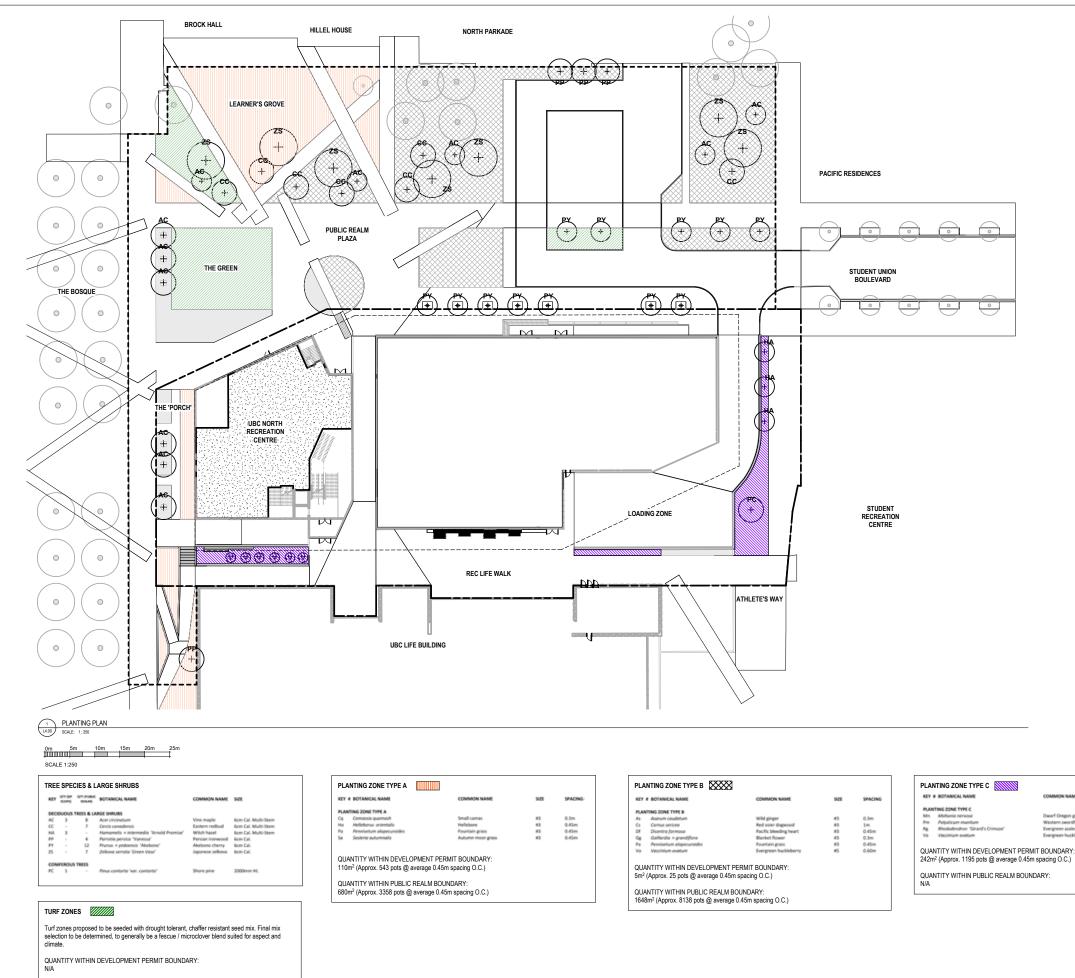

QUANTITY WITHIN PUBLIC REALM BOUNDARY: 558m<sup>2</sup> (To be seeded at manufacturer's density specifications)



## DIALOG

2021-02-26 Issue for Development Permit

#### LEGEND

PROJECT TRUE SCOPE OF WORK AROUND BUILDING LINE FOR DEVELOPMENT PERMIT

PROJECT SITE BOUNDARY LINE EXCLUDED FROM DEVELOPMENT PERMIT

EXTENTS OF NEW BUILDING ROOF ABOVE

+(ŦŦ) +  $\bigcirc$ 

EXISTING TREE TO REMAIN AND BE PROTECTED

#### NOTES

1) CONTRACTOR TO ORGANIZE A PROJECT PRE-CONSTRUCTION MEETING PRIOR TO ANY LANDSCAPE CONSTRUCTION WORK. MEETING TO INCLUDE THE PROJECT LANDSCAPE CONTRACTOR. THE PROJECT LANDSCAPE ARCHITECT. AND CLIENT REPRESEN

2) ALL PLANT MATERIAL USED IN THIS PROJECT MUST FIRST BE INSPECTEDIAPPROVED BY THE PROJECT LANDSCAPE ARCHITECT AT THE NURSERY BEFORE INSTALLATION.

3) CONTACT PROJECT LANDSCAPE ARCHITECT TO CONFIRM TREE TYPES PRIOR TO PURCHASE.

4) MINIMUM DEPTH FOR ALL SHRUB BEDS TO BE 450MM, GROUNDCOVER AREAS TO BE 300MM, AND TREES TO BE 600MM LARGER THAN ROOTBALL.

5) ALL PLANTING TO BE DONE TO CSLA/BCSLA/BCLNA STANDARDS, LATEST EDITION. THE PROJECT LANDSCAPE ARCHITECT HAS THE RIGHT TO REFUSE AN OR ALL OF THE SELECTED PLANT IMATERIAL IF IT DOES NOT MEET CURRENT CSLARDSLANDLINA STANDARDS.

6) ALL PLANTING BEDS TO HAVE 50MM MULCH AS SPECIFIED

O CONTRACTOR TO SUBMIT A REPRESENTATIVE SAMPLE OF THE PROPOSED TOPOLIC FOR TESTING TO PACIFIC SOL ANALYSIS. CONTRACTOR IS RESPONSIBLE FOR PRAVIDING AND PANEITOR 'SOL ANALYSIS AND AMENAMENTS TO GROWING MEDIUM AS DETERMINED CONTRACTOR SHALL INSTRUCT SOL TESTING AND AND AND AS DETERMINED CONTRACTOR SHALL ANALYSIS IN AN OF A PROVINCI FOR COMMENCIATION FOR OTHER ANALYSIS IN AN OFFICIAL PROCEIDED AND AS DETERMINED AND AS DESIDENT COMMENTICATION FOR TO COMMENCIATION FOR TO COMMENCIAL OFFICIAL ANALYSIS IN AN OFFICIAL PROCEIDED AND AS DESIDENT OF WORK GENERIC ANALYSIS IN AN OFFICIAL PROCEIDED AND AS DESIDENT OF WORK GENERIC

8) CONTRACTOR IS RESPONSIBLE TO OBTAIN AND BE FAMILIAR WITH THE RELEVANT PROJECT SPECIFICATIONS.

9) AS A MINIMAL ACCEPTABLE STANDARD: A) SIZES ON THE PLANT LIST SHALL BE CONSIDERED MINIMUM SIZES. B) ROOT BALLS TO BE FREE OF PERNICIOUS WEEDS.

10) CONTRACTOR TO ENSURE ALL PLANT MATERIAL DELIVERED TO SITE IS FROM NURSERIES CERTIFIED TO BE FREE FROM THE PHYTOPHTHORA RAMORUM VIRUS (SUDDER) CAR DETHY, REMOVAL AND REPLACEDENT OF PLANT MATERIAL FOUND TO CONTAIN THE VIRUS TO BE AT THE CONTRACTOR'S EXPENSE.

11) THE CONTRACTOR SHALL SUPPLY ALL PLANT MATERIALS SHOWN ON ALL DRAWINGS.

12) NO CONTAINER GROWN STOCK WILL BE ACCEPTED IF IT IS ROOT BOUND. AI ROOT WRAPPING MATERIAL MADE OF SYNTHETICS OR PLASTICS SHALL BE REMOVED AT TIME OF PLANTING.

13) CONTAINER GROWN STOCK SHALL HAVE THE CONTAINER REMOVED AND THE ROOTBALL BE CLEANLY SCORED IN TWO VERTICAL LOCATIONS.

14) NEW TOP SOIL SHOULD BE INCORPORATED BY MIXING INTO TOP 300MM OF NATIVE SOIL WHERE APPROPRIATE.

15) CONTRACTOR TO PROVIDE LANDSCAPE ARCHITECT A COPY OF ALL PACKING SLIPS RECEIVED FROM NURSERY LISTING NAMES AND QUANTITIES OF ALL PLANT STOCK SUPPLIED.

16) THE CONTRACTOR SHALL LOCATE AND VERIFY THE EXISTENCE OF ALL UTILITIES PRIOR TO STARTING WORK. 17) ALL PLANTS SHALL BE WATERED THOROUGHLY TWICE DURING THE FIRST HOUR PERIOD AFTER PLANTING. ALL PLANTS SHALL THEN BE WATERED AS NECCESSARY.

18) THE LANDSCAPE CONTRACTOR SHALL REFER TO THE CONTRACT SPECIFICATIONS FOR ADDITIONAL REQUIREMENTS PRIOR TO AND DURING ESTABLISHMENT MAINTENANCE PERIOD.

19) PLANT SEARCH AREA TO INCLUDE BC, WA , OR, & CA AS APPROPRIATE

## 0.3m 0.45m 0.60m 0.60m Western swordfer vergreen azalea

### UBC NORTH RECREATION CENTRE

CONCEPT SITE PLANTING PLAN

DRAWN: Author CHECKED: Checker PLOT DATE: 2/26/2021 10:28:19 AM



#### METRIC

SSUED FOR

THIS DRAWING IS COPYRIGHTED AND MUST NOT BE USED, REPRODUCED, OR REVISED WITHOUT WRITTEN PERMISSION ALL DIMENSIONS ARE IN MILLIMETERS UNLESS OTH NOTED. VERIFY DIMENSIONS. DO NOT SCALE THIS DRAWING.

REPORT INCONSISTENCIES AND OMISSIONS TO THE CONSULT FOR CLARIFICATION BEFORE COMMENCING WITH THE WORK.

DEVIATIONS FROM THE CONTRACT DOCUMENTS WITHOUT WRITTEN APPROVAL FROM THE CONSULTANT ARE SUBJECT TO CORRECTION AT THE CONTRACTOR'S EXPENSE.

ARCHITECT & PRIME CONSULTANT SHAPE Architecture Inc. 534 West Pender Street Vancouver, BC V6B 1V8 Tel: (604) 687-4457 Eav


WSP 840 Howe Street, #1000 Vancouver, BC V6Z 2M1 Tel: (604) 685-9381 Fax: LANDSCAPE ARCHITECT DIALOG BC Architecture Engineering Interior 406 -1611 Alexander Street 406 -1611 Alexander Street Vancouver, BC, V6A 1E1 Tel: (604) 255-1169 Fax: 
 Tel:
 (604) 235-1109
 Fax.

 STRUCTURAL ENGINEER
 WSP
 840 Howe Street, #1000


 Vancouver, BC V62 2M1
 Tel:
 (604)685-9381
 Fax:
 MECHANICAL ENGINEER

200 – 638 Smithe Street Vancouver, BC V6B 1E3 Tel: (604)684-5995 ELECTRICAL ENGINEER PBX Engineering Ltd. 300-131 Water Street Vancouver BC, V6B 4M3 Tel: (604)408-7222 KEYPLAN

BC100067 - 2002698 C:\RevifLocal Files/DLG\_BC100067\_LA\_UBC RECREATION CENTRE\_jgodwinAU5RD.nt

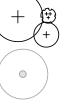



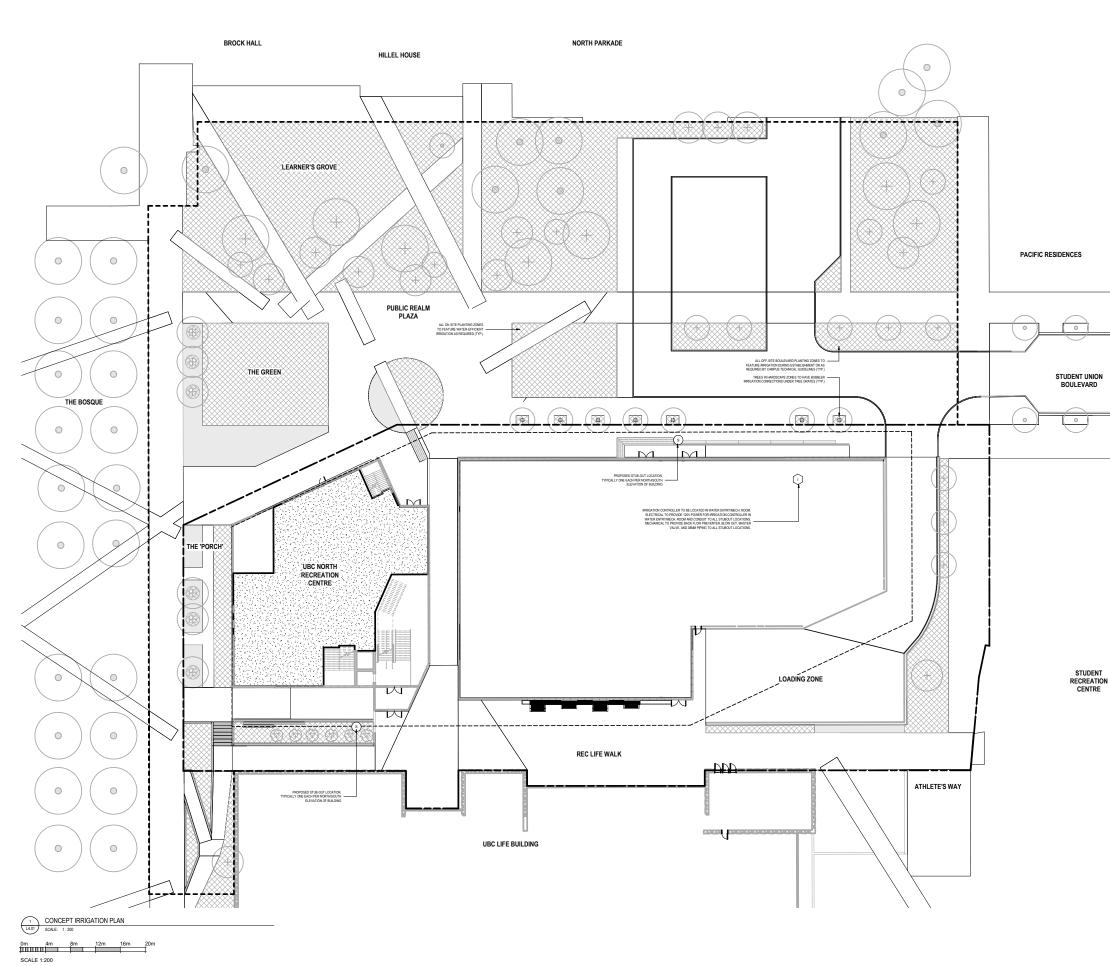



2021-02-26 Issue for Development Permit

#### LEGEND

PROJECT TRUE SCOPE OF WORK AROUND BUILDING LINE FOR DEVELOPMENT PERMIT

PROJECT SITE BOUNDARY LINE EXCLUDED FROM DEVELOPMENT PERM \_\_\_\_ EXTENTS OF NEW BUILDING ROOF 

s



NOTES

1) ON-SITE SYSTEM RELATED TO BUILDING PERIMETER ZONE TO BE ON A SEPARATE CIRCUIT FROM ANY REQUIRED PUBLIC REALM OR OFF-SITE

2) THE IRRIGATION CONTRACTOR SHALL CONFIRM ON SITE THE LOCATIONS O THE STUB-OUTS PROVIDED BY THE MECHANICAL CONTRACTOR. SEE PLANS. 3) THE ELECTRICAL CONTRACTOR SHALL SUPPLY 120V OUTLETS FOR THE CONTROLLERS AND RUN 38MM CONDUITS WITH PULL STRINGS TO ALL STUB-OUT LOCATIONS. SEE PLANS.

4) THE IRRIGATION CONTRACTOR SHALL SUPPLY AND INSTALL THE IRRIGATION CONTROLLERS AND RUN ALL LOW VOLTAGE WIRES TO THE SOLENOID VALVES.

5) THE IRRIGATION CONTRACTOR SHALL COORDINATE ALL SLEEVES, CONDUITS, AND LOCATIONS OF SENSORS WITH THE GENERAL CONTRACTOR. 6) THE IRRIGATION SYSTEM SHALL BE INSTALLED AS PER IIABC STANDARDS OR BETTER.

7) DOUBLE CHECK VALVES, BACK FLOW PREVENTER'S, FILTER AND A BLOW-OUT CONNECTION IN WATER ENTRY ROOMS, AND THE RUNNING OF A 38MM SUPPLY LINE TO ALL STUB OUT LOCATIONS, BY MECHANICAL. SEE PLANS.

8) IRRIGATION CONTRACTOR TO SUPPLY RAIN SENSOR AND DETERMINE LOCATIONS ON SITE 9) NO DRIP IRRIGATION LINLESS OTHERWISE INDICATED OR APPROVED BY OPERATIONS. IF REQUERE DRIP IRRIGATION AREAS TO BE ON SEPARATE COVERINGE FROM OTHER AREAS.

10) IRRIGATION VALVES TO BE LOCATED IN PLANTING BEDS. EACH TO HAVE A FLOW SENSOR FOR PROPER ZONE FLOWS.

11) THE IRRIGATION CONTRACTOR TO SUBMIT SHOP DR PRIOR TO INSTALLATION.

12) THE IRRIGATION CONTRACTOR TO PROVIDE SUBMITTALS FOR ALL IRRIGATION COMPONENTS FOR APPROVAL PRIOR TO INSTALLATION.

13) THE IRRIGATION CONTRACTOR TO PROVIDE AS-BUILT DRAV CONSTRUCTION.

14) KEEP ALL IRRIGATION PIPING OUT OF TREE ROOTING ZONES.

1.5. ALL REGATION COMPOSITION OF THE TRUTTING ZURES. IS ALL REGATION COMPONENTS TO EXAMPLE ACTURED FOR MAINERD OF ECUNVERLY STRAN HEARS TO DE MINIMUM RAAIBED 100 SERES STRAV AND SEREIS STORED OF ECUNVERS. TO ZUZES TO BE HEND FOR FOR EXAMPLE CAPABLE OF APPLY TWO WATER AT OR LESS THAN 13MM PERHOURS BUBBLESS EQUIVALENT. VALVES TO EL MINIMUM RAAIBED DE SERES OR ECUIVALENT. CONTROLLERS TO EL MINIMUM RAAIBED DE SERES OR ECUIVALENT. ECUIVALENT. SENCORS TO BE MINIMUM RAAIBED DE SERES OR ECUIVALENT. ESIDICIÓN CECUIVALENT.

16) USE RISERS IN SHRUB AREAS AND DIRECT SPRAY AWAY FROM HARD SURFACES AND LAWN EDGES. 17) ALL IRRIGATION AREAS TO BE HEAD TO HEAD COVERAGE

18) IRRIGATION COVERAGE TO BE BROKEN OUT INTO SEPARATE ZONES FOR EACH MAJOR AREA ALLOWING FOR INDIVIDUAL CONTROL AS NECESSARY.

#### METRIC

THIS DRAWING IS COPYRIGHTED AND MUST NOT BE USED, REPRODUCED, OR REVISED WITHOUT WRITTEN PERMISSION.

REPORT INCONSISTENCIES AND OMISSIONS TO THE CONSULT FOR CLARIFICATION BEFORE COMMENCING WITH THE WORK. DEVIATIONS FROM THE CONTRACT DOCUMENTS WITHOUT WRITTEN APPROVAL FROM THE CONSULTANT ARE SUBJECT TO CORRECTION AT THE CONTRACTOR'S EXPENSE.

ARCHITECT & PRIME CONSULTANT SHAPE Architecture Inc. 534 West Pender Street Vancouver, BC V6B 1V8 Tel: (604) 687-4457 Fax:

CIVIL ENGINEER WSP 840 Howe Street, #1000 Vancouver, BC V6Z 2M1 Tel: (604) 685-9381 Fax:

LANDSCAPE ARCHITECT DIALOG BC Architecture Engineering Interior 406 - 611 Alexander Street 406 -1611 Alexander Street Vancouver, BC, V6A 1E1 Tel: (604) 255-1169 Fax: 
 Tel:
 (604) 235-1109
 Fax.

 STRUCTURAL ENGINEER
 WSP
 840 Howe Street, #1000

 Vancouver, BC V&Z 2M1
 Tel:
 (604) 685-9381
 Fax:

MECHANICAL ENGINEER 200 – 638 Smithe Street Vancouver, BC V6B 1E3 Tel: (604)684-5995 Fax: ELECTRICAL ENGINEER PBX Engineering Ltd. 300-131 Water Street Vancouver BC, V6B 4M3 Tel: (604)408-7222 KEYPI AN

UBC NORTH RECREATION CENTRE

### CONCEPT SITE **IRRIGATION PLAN**

DRAWN: Author CHECKED: Checker PLOT DATE: 2/26/2021 10:28:24 AM



BC100067 - 2002698 C:\RevifLocal Files/DLG\_BC100067\_LA\_UBC RECREATION CENTRE\_jgodwinAU5RD.nt

### 79

EXISTING TREE TO REMAIN AND BE PROTECTED

IRRIGATION CONTROLLERS

PROPOSED 38mm STUBOUTS (MIN>50GPM @ 70PSI)

PLANTED AREAS ON SITE PROPOSED TO BE IRRIGATED WITH HIGH EFFICIENCY IRRIGATION SYSTEM

SSUED FOR

REPRODUCED, OR REVISED WITHOUT WATTEN PERMISS ALL DIMENSIONS ARE IN MILLIMETERS UNLESS OTHERWIS NOTED. U REIFY DIMENSIONS. DO NOT SCALE THIS DRAWING.



ISSUED FOR

1 2021-02-26 Issue for Development Permit

#### METRIC

THIS DRAWING IS COPYRIGHTED AND MUST NOT BE USED, REPRODUCED, OR REVISED WITHOUT WRITTEN PERMISSION. ALL DIMENSIONS ARE IN MILIMETERS UNLESS OTHERWISE NOTED. VERIFY DIMENSIONS. DO NOT SCALE THIS DRAWING.

DO NOT SCALE THIS DRAWING. REPORT INCONSISTENCIES AND OMISSIONS TO THE CONSULTA FOR CLARIFICATION BEFORE COMMENCING WITH THE WORK. DEVIATIONS FROM THE CONTRACT DOCUMENTS WITHOUT WRITTEN APPROVAL FROM THE CONSULTANT ARE SUBJECT TO CORRECTION AT THE CONTRACTOR'S EXPENSE.

CORRECTIONALT THE CONTRACTORSE SUPPARE.

ARCCHITECT & A PRIME CONSULTANT

SUPER Available is:

 (a)
 (a)
 (a)
 (b)
 (a)
 (b)
 (b)

UBC NORTH RECREATION CENTRE

## SITE SECTIONS & ELEVATIONS

DRAWN: Author CHECKED: Checker PLOT DATE: 2/26/2021 10:28:27 AM

L5.00

BC100067 - 2002698 C:RevifLocal Files/DLG BC100067\_LA\_UBC RECREATION CENTRE\_jgodwinAUSRD.vt Development Permit Application UBC Recreation Centre North March 2021





2 INNER CORRIDOR PERSPECTIVE VIEW 1501 SCALE: NTS

1 MAIN ENTRANCE PERSPECTIVE VIEW LOOKING SE SCALE: NTS



3 MAIN ENTRANCE PERSPECTIVE VIEW LOOKING SW SCALE: NTS



4 SOUTH WEST ENTRANCE RAMP PERSPECTIVE VIEW SCALE: 1:10

#### ISSUED FOR

1 2021-02-26 Issue for Development Permit

### METRIC

THIS DRAWING IS COPYRIGHTED AND MUST NOT BE USED, REPRODUCED, OR REVISED WITHOUT WRITTEN PERMISSION ALL DIMENSIONS ARE IN MILLIMETERS UNLESS OTHERWISE NOTED. VERRY DMENSIONS. DO NOT SCHLE THIS DRAWING.

DO NOT SCALE THIS DRAWING. REPORT INCONSISTENCIES AND OMISSIONS TO THE CONS FOR CLARIFICATION BEFORE COMMENCING WITH THE WO

 DBVANCHS FROM THE CONTRACT DOCUMENT WATER OF THE CONTRACT DOCUMENT OF THE




UBC NORTH RECREATION CENTRE

### PERSPECTIVE VIEWS

DRAWN: Author CHECKED: Checker PLOT DATE: 2/26/2021 10:28:28 AM

L5.01

BC100067 - 2002698 C:RevifLocal Files/DLG\_BC100067\_LA\_UBC RECREATION CENTRE\_joodwinAUSRD.vt

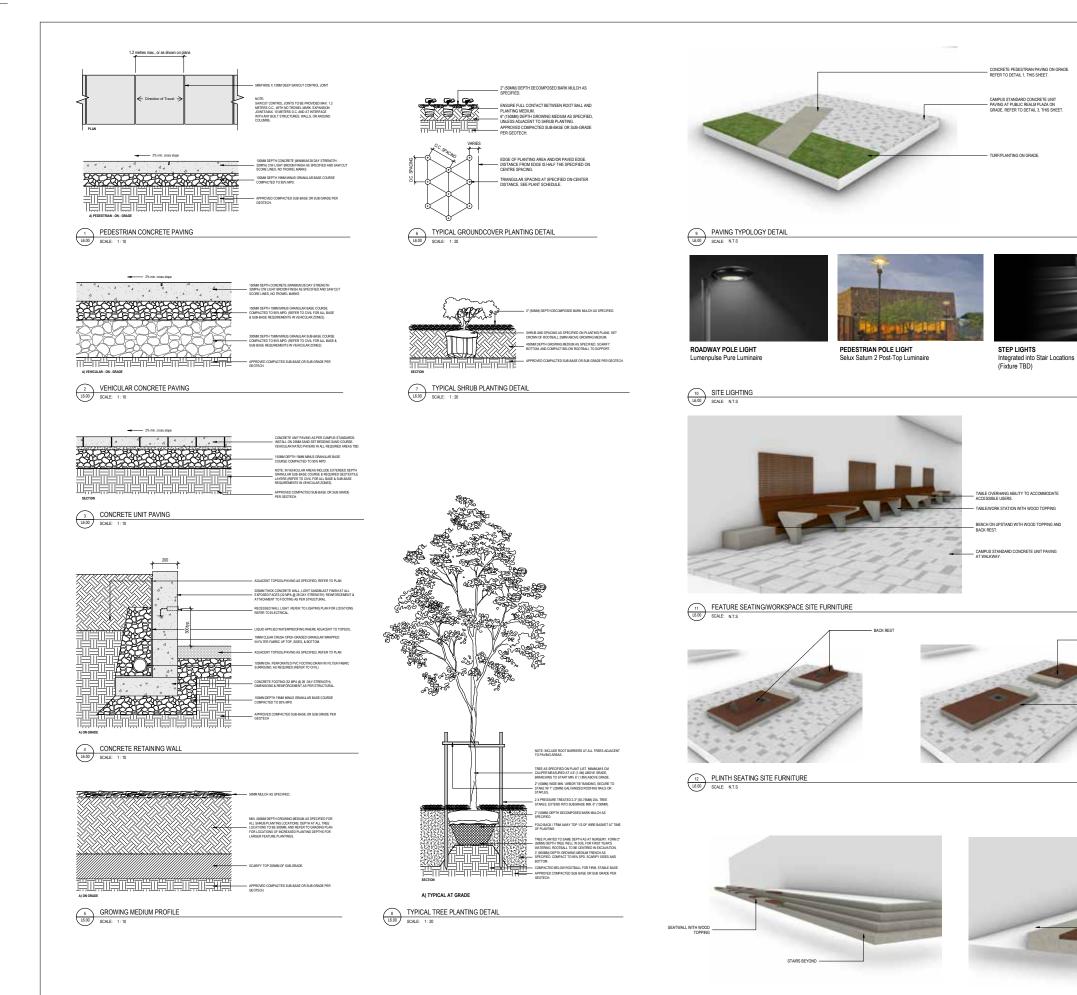

13 SEATWALL WITH STAIR SITE FEATURE 16.00 SCALE: N.T.S

## **DIALOG**°

ISSUED FOR

METRIC

THIS DRAWING IS COPYRIGHTED AND MUST NOT BE USED, REPRODUCED, OR REVISED WITHOUT WRITTEN PERMISSION ALL DIMENSIONS ARE IN MILLIMETERS UNLESS NOTED. VERIFY DIMENSIONS. DO NOT SCALE THIS DRAWING.

REPORT INCONSISTENCIES AND OMISSIONS TO THE CONSUL FOR CLARIFICATION BEFORE COMMENCING WITH THE WORK DEVIATIONS FROM THE CONTRACT DOCUMENTS WITHOUT WRITTEN APPROVAL FROM THE CONSULTANT ARE SUBJECT TO CORRECTION AT THE CONTRACTOR'S EXPENSE.

ARCHITECT & PRIME CONSULTANT

 SHAPE Architecture Inc.
 SM West Pender Street

 Vancouver, BC V68 1V8
 Vest Pender Street

 Vancouver, BC V68 1V8
 Fax:

 CIVIL ENGINEER
 WSP

 840 Honer Street, #1000
 Vancouver, BC V62 204

 Vancouver, BC V62 204
 Tei: (604) 685-9381

LANDSCAPE ARCHITECT DIALOG BC Architecture Engineering Interior 406 -611 Alexander Street Vancouver, BC, V6A 1E1 Tel: (604) 255-1169 Fax:

 1et: (604) 255-1169
 Fax:

 STRUCTURAL ENGINEER
 WSP

 840 Howe Street, #1000
 Vancouver, BC V62 2011

 Tet: (604)685-9381
 Fax:

200 – 638 Smithe Street Vancouver, BC V6B 1E3 Tel: (604)684-5995 Fax: ELECTRICAL ENGINEER PBX Engineering Ltd. 300-131 Water Street Vancouver BC, V6B 4M3 Tel: (604)408-7222

2021-02-26 Issue for Development Permit

OPENING IN PLINTH FOR TRE PLANTING.

CAMPUS STANDAF PAVING ON GRADE

## UBC NORTH RECREATION CENTRE


PRELIMINARY DETAILS

DRAWN: Author CHECKED: Checker PLOT DATE: 2/26/2021 10:28:41 AM

L6.00

BC100067 - 2002698 C:\RevifLocal Files/DLG\_BC100067\_LA\_UBC RECREATION CENTRE\_jgodwinAUSRD.rvt

# Lighting Plan

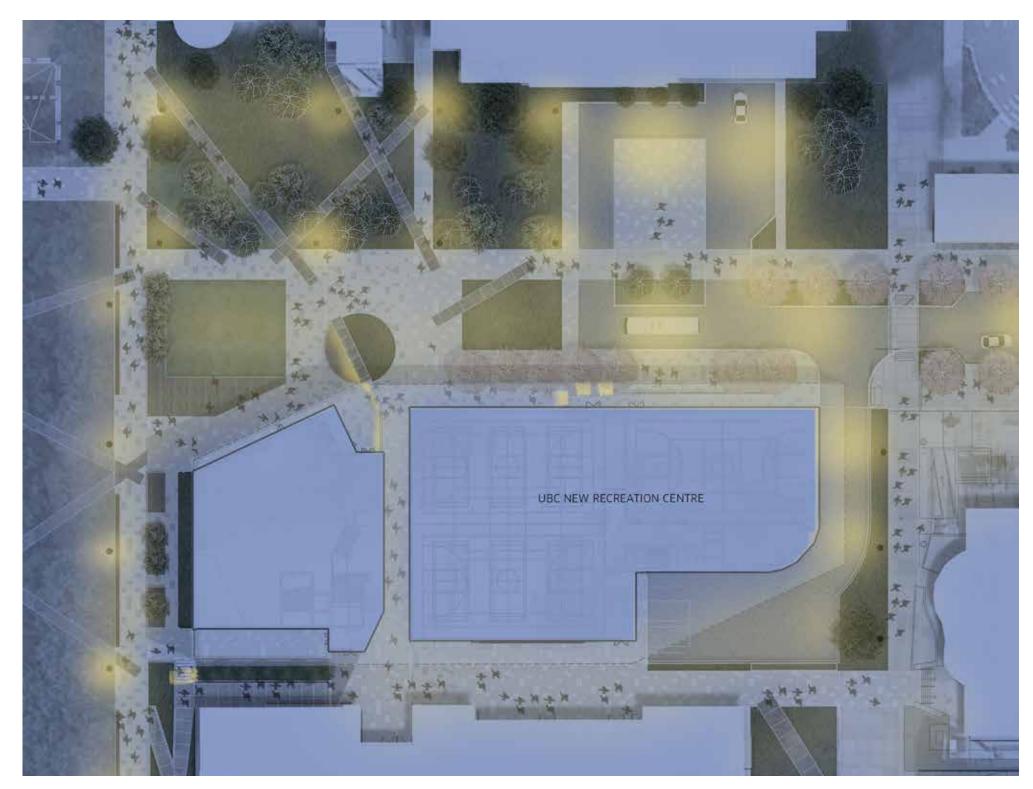

By DIALOG