

PROJECT DATA BUILDING NAME: FIRST NATIONS HOUSE OF LEARNING EXPANSION PROJECT

CIVIC ADDRESS: 1985 WEST MALL, VANCOUVER, BC V6T 1Z2

PROJECT TEAM UBC PROJECT MANAGER: CONTACT: KAREN KOYAMA TEL: 604-341-3370

ARCHITECT: ART CADER ARCHITECT INC. 212-1807 MARITIME MEWS VANCOUVER, BC V6H 3W7 CONTACT: ART CADER TEL: 604-558-2782

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MECHANICAL CONSULTANT: ROCKY POINT ENGINEERING LTD 302-2425 QUEBEC ST VANCOUVER, BC V5T 4L6 CONTACT: MARK YEUNG TEL: 604-559-8807

BUILDING ENVELOPE CONSULTANT: RJC LTD. 1285 WEST BROADWAY, SUITE 300 VANCOUVER, BC V6H 3X8 CONTACT: DENNIS HODKINSON TEL: 604-739-6268

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NO

ELECTRICAL CONSULTANT: WSP CANADA INC. #1000 - 840 HOWE ST, VANCOUVER, BC V6Z 2M1 CONTACT: ANDY TASHIRO

TEL: 604-685-9381 andy.tashiro@wsp.com STRUCTURAL CONSULTANT CWMM CONSULTING ENGINEERS LTD. #200 - 1412 W 7th AVE., VANCOUVER, BC V6H 1C1 CONTACT: DAVID MACKINNON TEL: 604-731-6584 EXT. 135

LIST OF DRAWINGS

ARCHITECTURAL A001 COVER SHEET A011 EXISTING SITE PLAN A012 SITE PLAN A013 OVERALL SITE 3D A014 PLAN A014.2 PLAN-OPEN DOOR A015 OVERHEAD CUT-AWAY VIEW A016 OVERALL ELEVATIONS A016.2 ELEVATIONS & MATERIALS A017 BIRD'S EYE DETAIL VIEWS A018 EYE LEVEL VIGNETTES

A019 INTERIOR VIEWS

A020 LIBRARY RAILING

A1.60 CONTEXT PHOTOS A2.00 SCHEDULES A3.00 SITE PLAN A3.10 OVERALL FLOOR PLAN & ROOF PLAN A3.20 FLOOR PLAN A3.40 FLOOR PLAN - FFE A3.60 PARTIAL ROOF PLAN

		[]]
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MAR 12, 2021	ISSUED FOR 50%	
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A0.01 COVER SHEET A1.00 EXISTING SITE PLAN A1.10 EXISTING OVERALL FLOOR PLAN & ROOF PLAN A1.20 EXISTING PARTIAL PLAN/DEMOLITION A1.30 EXISTING PARTIAL ROOF PLAN A1.40 EXISTING ELEVATIONS/SECTIONS 1 A1.41 EXISTING ELEVATIONS/SECTIONS 2

A4.00 PROPOSED ELEVATIONS/SECTIONS A4.01 PROPOSED ELEVATIONS/SECTIONS A4.10 CROSS SECTIONS A4.11 LONGITUDINAL SECTIONS A4.20 ELEVATIONS 1-50 A5.01 WALL SECTIONS A5.02 WALL SECTIONS A5.03 WALL SECTIONS A6.01 INTERIOR ELEVATIONS 1 A6.02 INTERIOR ELEVATIONS 2

STRUCTURAL S101 GENERAL NOTES S102 TYPICAL DETAILS S201 PLANS & BUILDING SECTION S301 SECTIONS & DETAILS - SHEET 1 S302 SECTIONS & DETAILS - SHEET 2

- LANDSCAPE L1.0 TREE MANAGEMENT PLAN AND ACCESS ROUTE L2.0 LANDSCAPE CONCEPT PLAN L3.0 LANDSCAPE PLANTING DETAILS
- L3.1 LANDSCAPE PAVING DETAILS

MECHANICAL M0.00 COVER SHEET & SITE PLAN M1.00 FOUNDATION MECHANICAL DEMOLITION PLAN M2.00 NEW FOUNDATION MECHANICAL PLAN M3.00 ABOVE GRADE PLUMBING FLOOR PLAN M3.01 FIRE PROTECTION FLOOR PLAN M3.02 HVAC FLOOR PLAN


M4.00 DETAILS, SCHEMATICS, & SCHEDULES


<u>ELECTRICAL</u> E-01 SITE PLAN, LEGEND & DRAWING LIST E-11 OVERALL PLAN - DEMOLITION ELECTRICAL E-12 OVERALL PLAN - PROPOSED ELECTRICAL E-21A PROPOSED FLOOR PLAN - LIGHTING E-121B PROPOSED FLOOR PLAN - POWER & LOW TENSION E-31 SINGLE LINE DIAGRAM, SCHEDULES & ELECTRICAL DETAILS




COVER SHEET **UNIVERSITY OF BRITISH COLUMBIA** FIRST NATIONS HOUSE OF LEARNING EXPANSION PROJECT A001 DRAWN SCALE PROJECT DATE 1985 West Mall, Vancouver, BC V6T 1Z2 APR 22, 2021 NTS 20UBC12 RJ


1 FIRST NATIONS LONGHOUSE EXPANSION 3D VIEW.

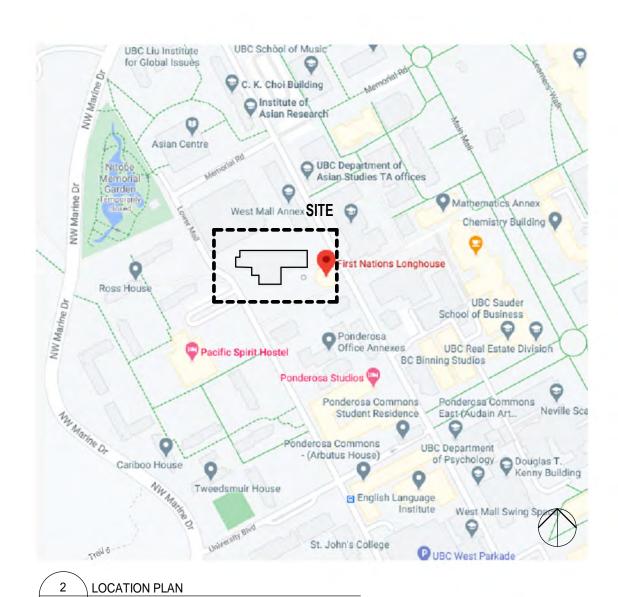

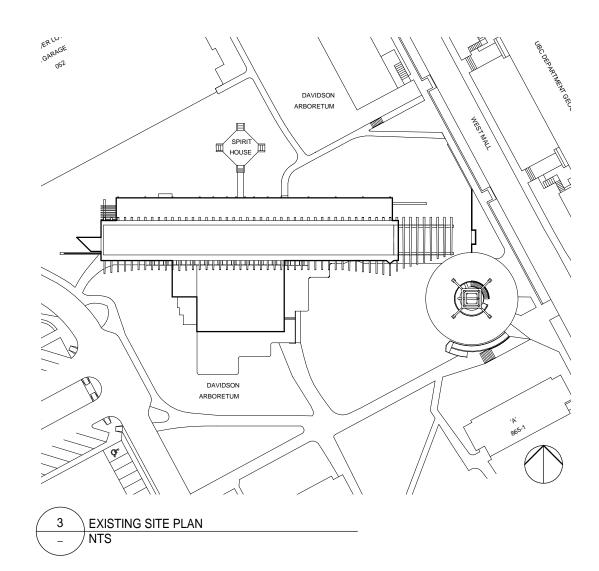

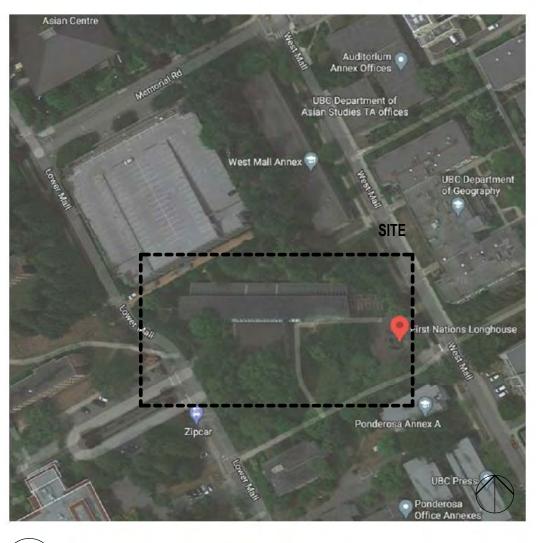

4 KEY PLAN – NTS

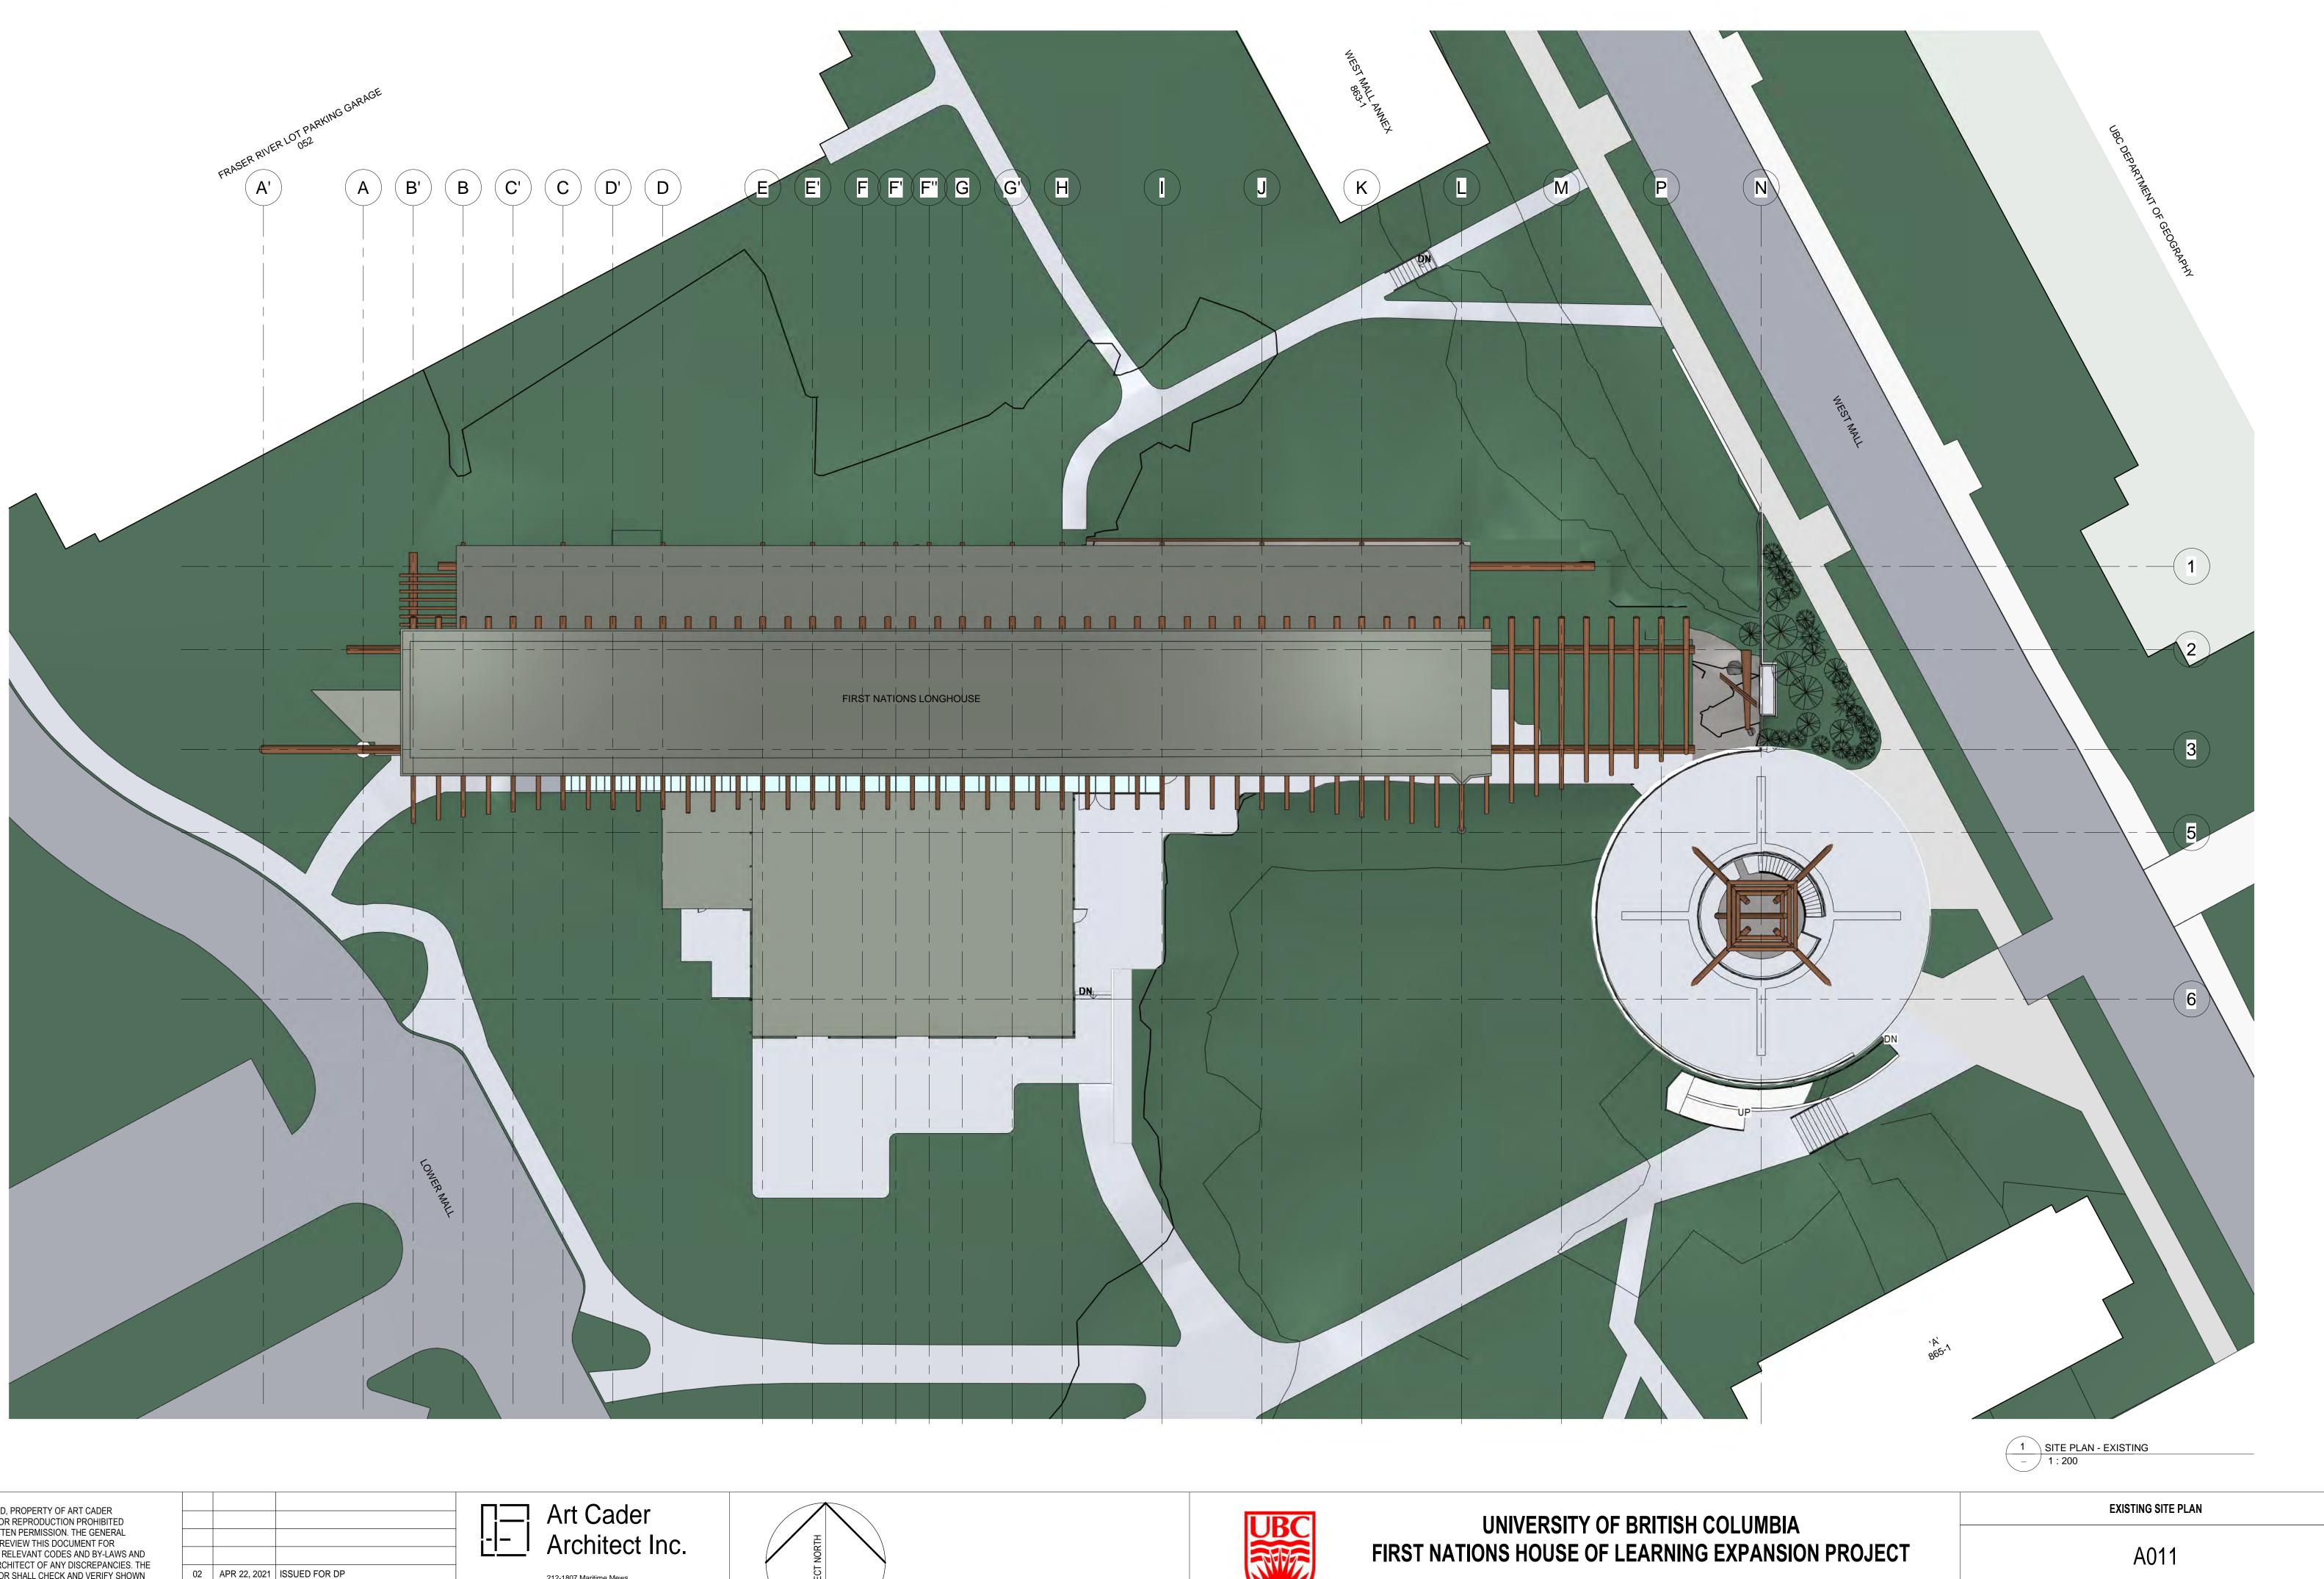


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1985 West Mall, Vancouver, BC V6T 1Z2

DRAWN SCALE PROJECT DATE RJ 1:200 20UBC12

APR 22, 2021


GARAC	3E
INER LOT PARKING	
FRASER RIVER LOT PARKING GARAG) (B') (B) (C') (C) (D') (D)
	JUNER MALL
	LOWIERAMALL
	OMIERAMALL
	OMIER MALL

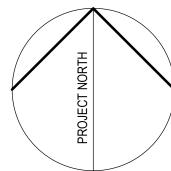
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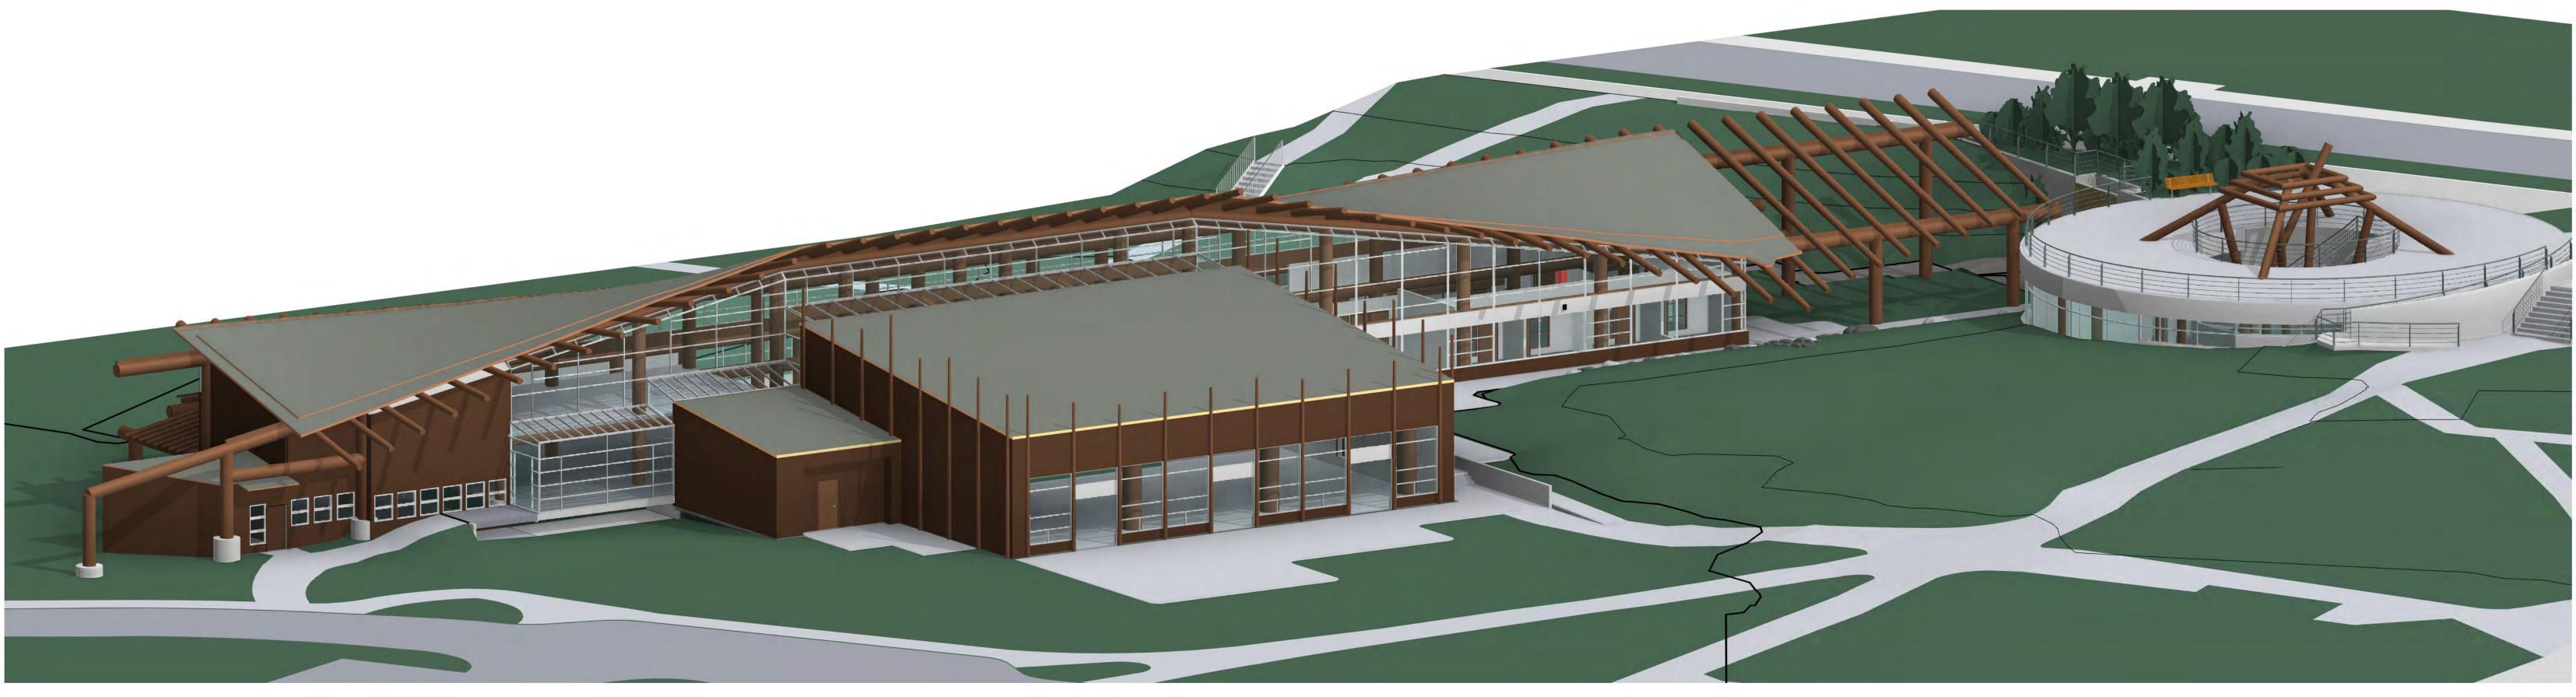



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APR 22, 2021




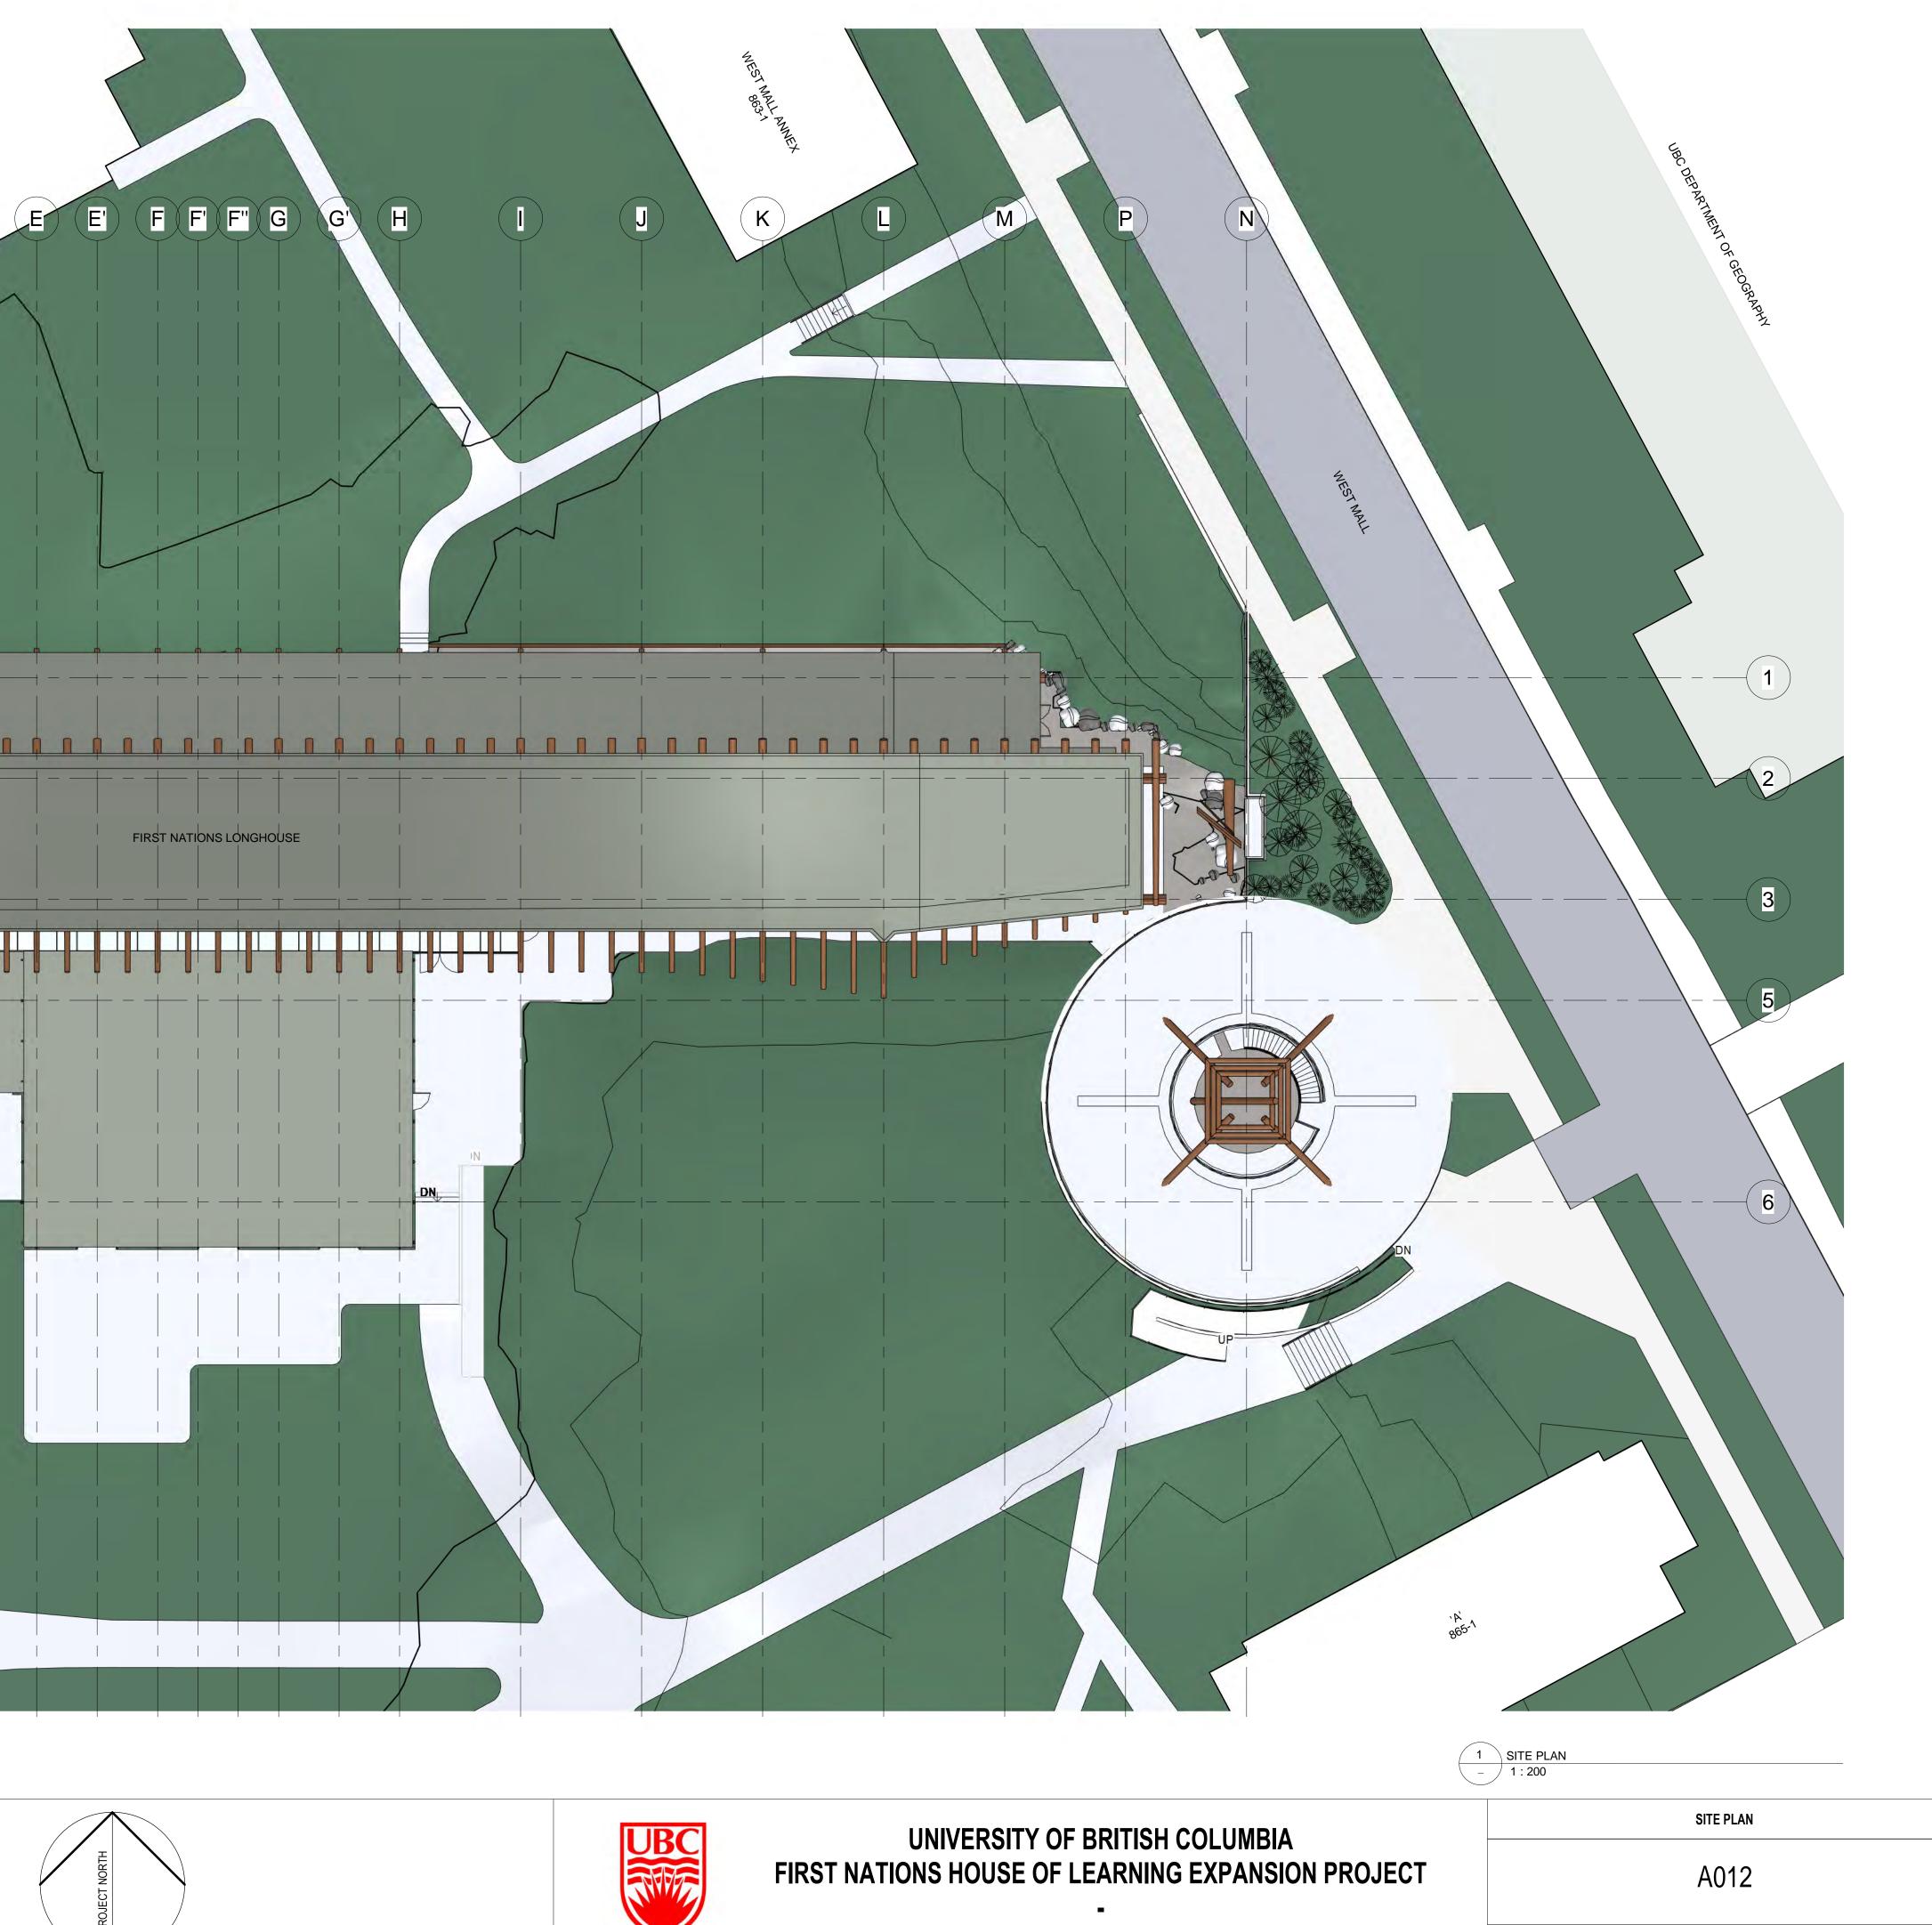

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1 OVERALL VIEW OF EXISTING BUILDING.

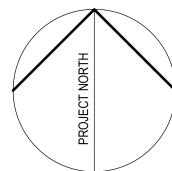2 OVERALL VIEW WITH PROPOSED EXPANSION. - /

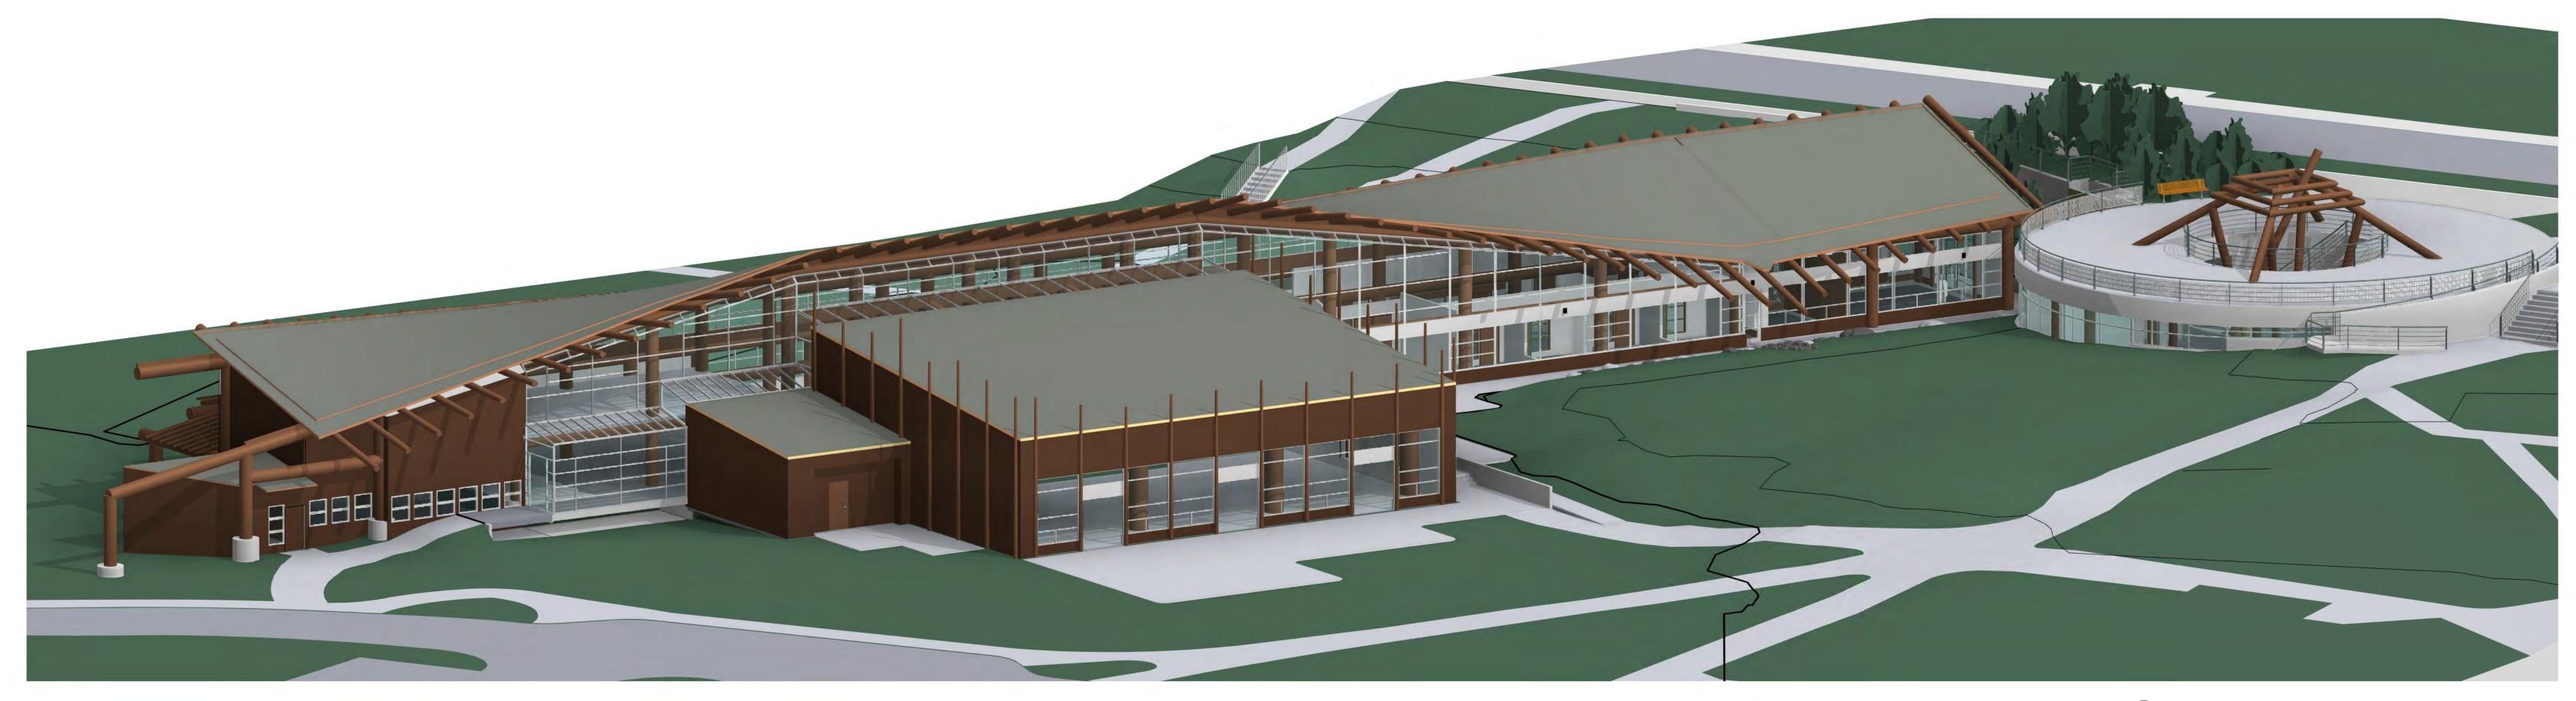UNIVERSITY OF BRITISH COLUMBIA FIRST NATIONS HOUSE OF LEARNING EXPANSION PRO.

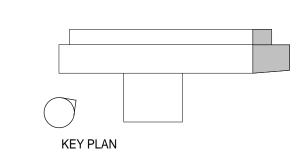DJECT			/	4013	
	DRAWN RJ	SCALE NTS	PROJECT 20UBC12	DATE	APR 22, 2021

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1 PLAN -1:50

UNIVERSITY OF BRITISH COLUMBIA PLAN FIRST NATIONS HOUSE OF LEARNING EXPANSION PROJECT A014 I I 1985 West Mall, Vancouver, BC V6T 122 DRAWN SCALE PROJECT DATE International Scale 11:50 20UBC12 DATE APR 22, 2021




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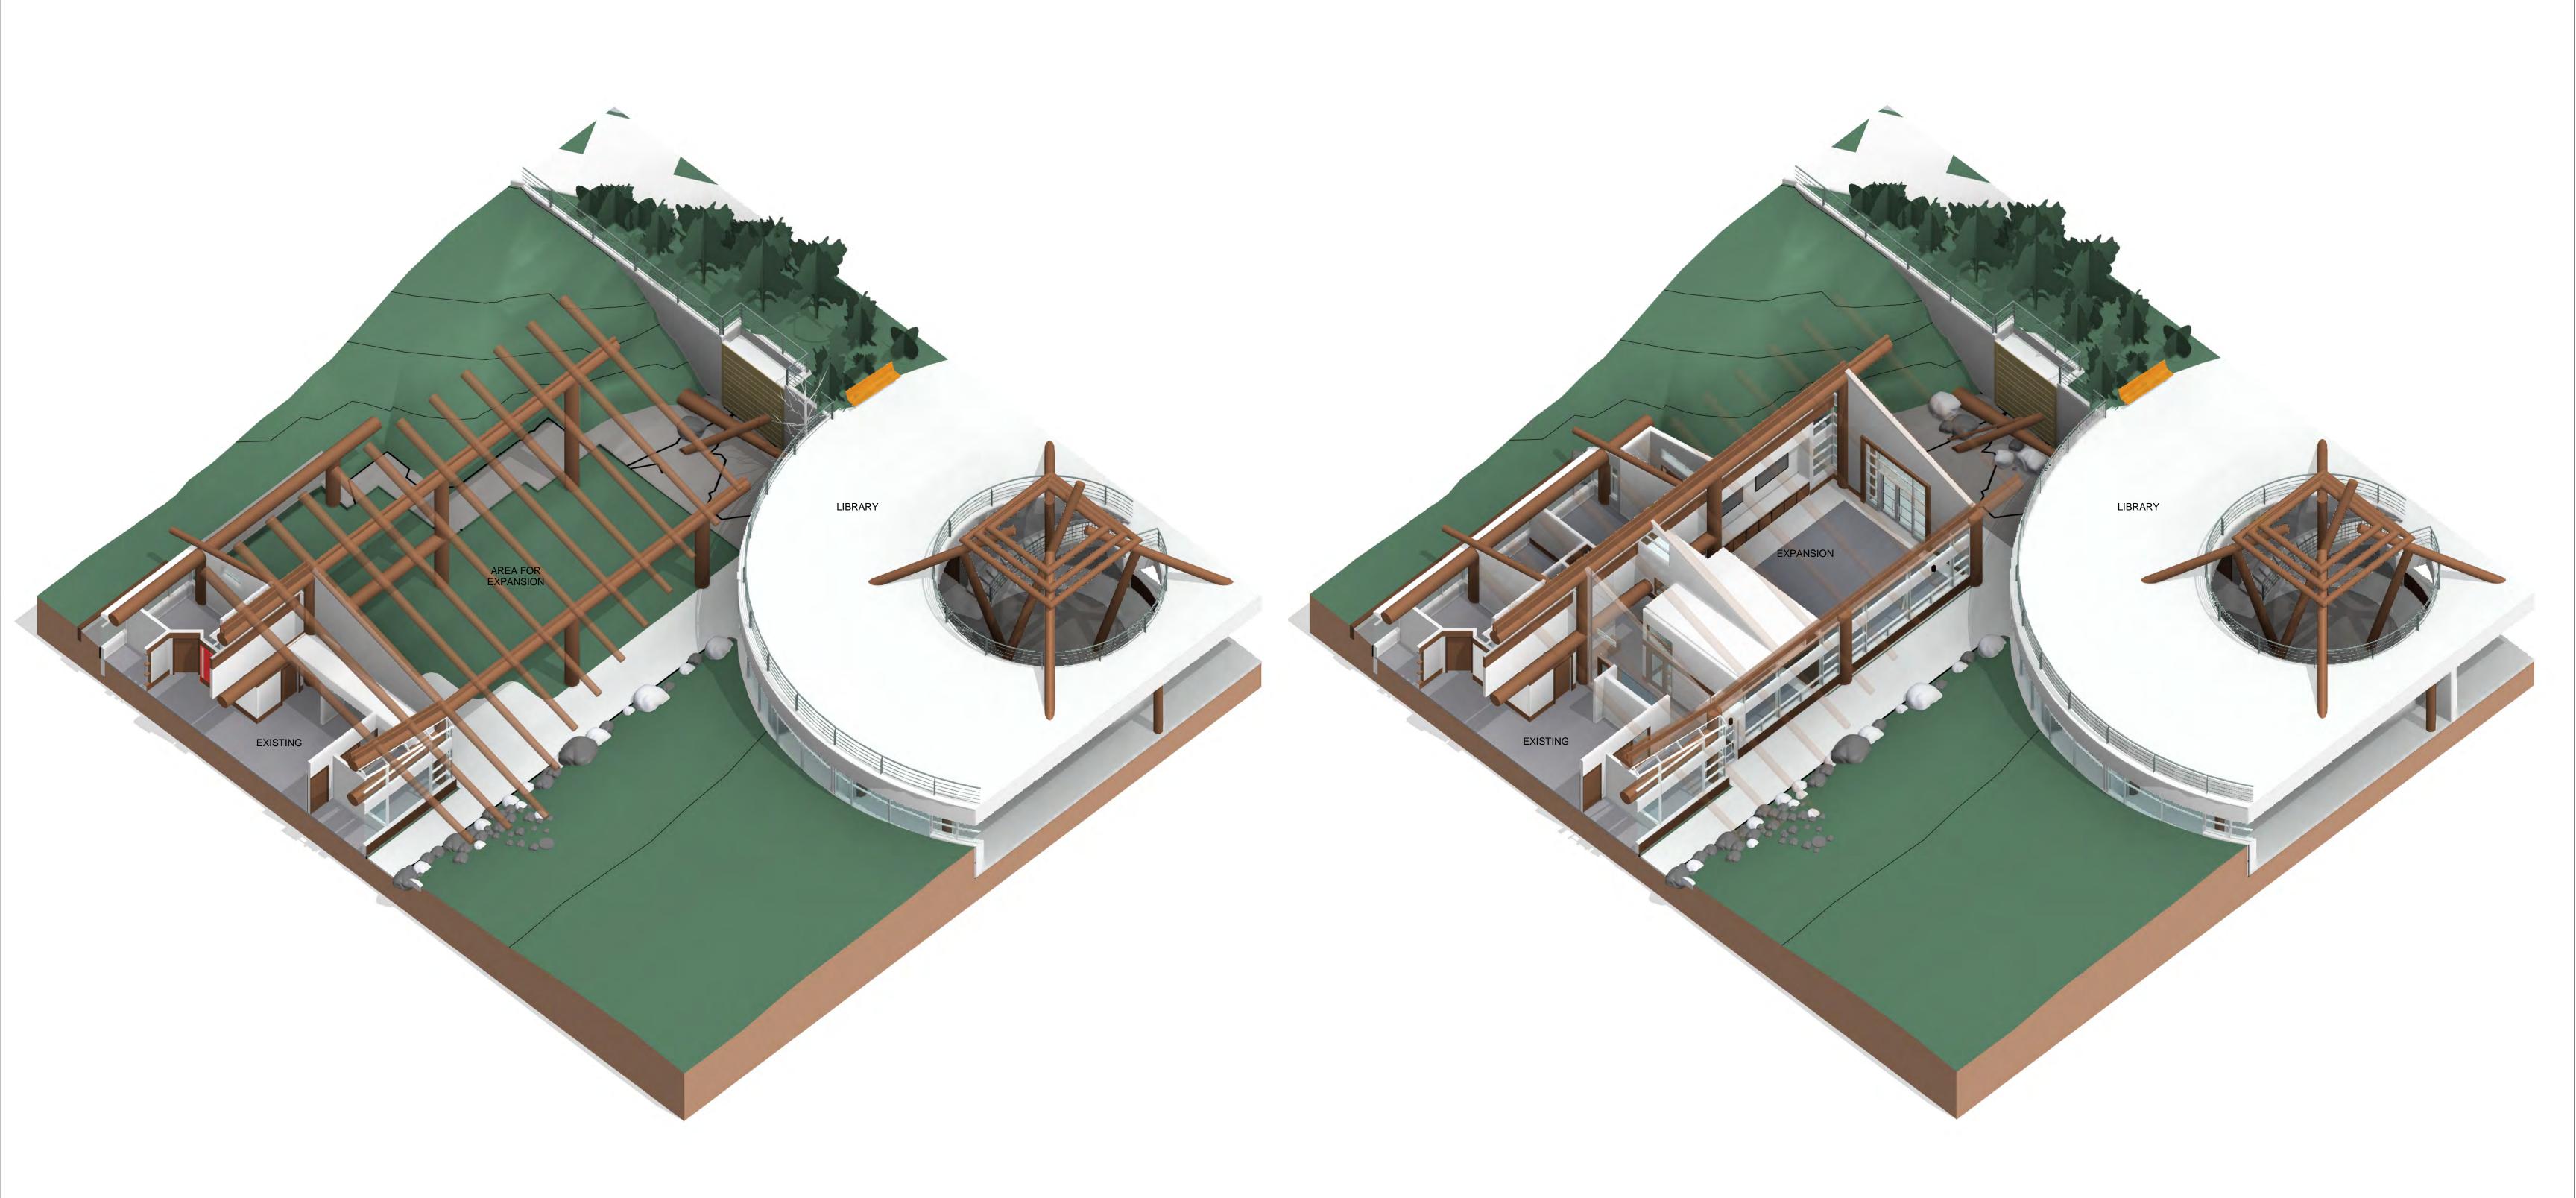








SITY OF BRITISH COLUMBIA	PLAN - OPEN DOOR A014.2					
JSE OF LEARNING EXPANSION PROJECT						
-						
1985 West Mall, Vancouver, BC V6T 1Z2	DRAWN RJ	SCALE 1:50	PROJECT 20UBC12	DATE A	APR 22, 2021	

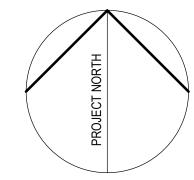

1 OVERHEAD CUT-AWAY VIEW OF EXPANSION AREA (EXISTING).

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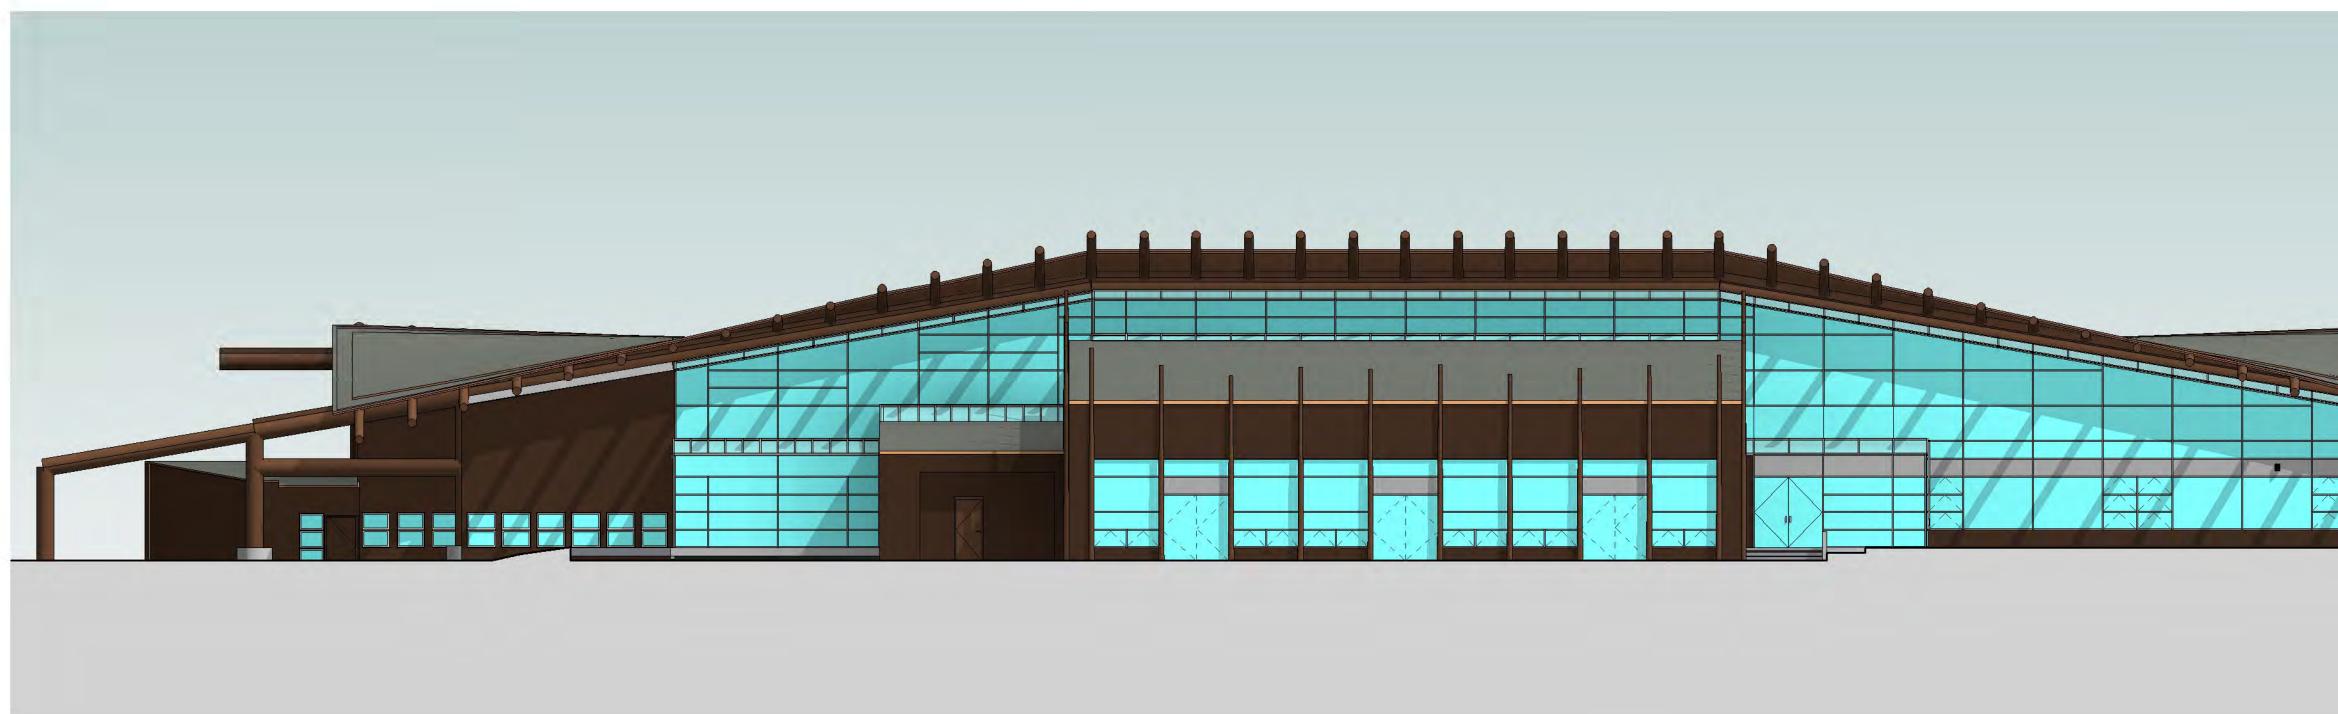
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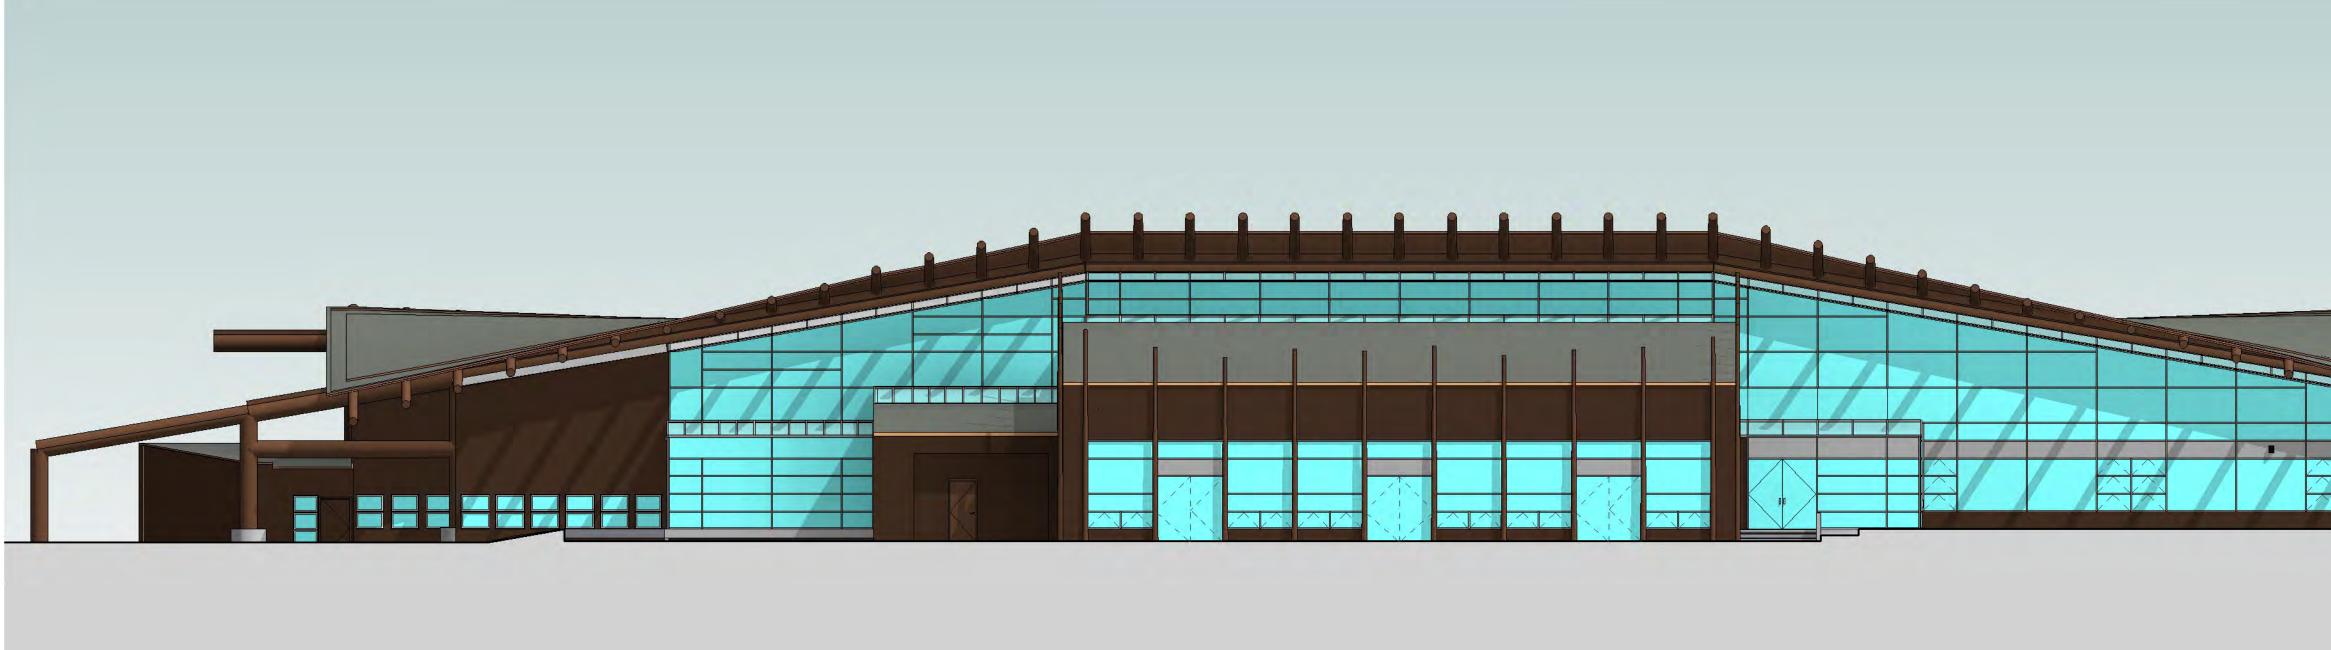






BRITISH COLUMBIA LEARNING EXPANSION PROJECT		OVERHEAD CUT-AWAY VIEW			
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-					
I, Vancouver, BC V6T 1Z2	DRAWN RJ	SCALE NTS	PROJECT 20UBC12	DATE	APR 22, 2021






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F BRITISH COLUMBIA LEARNING EXPANSION PROJECT		OVERALL ELEVATIONS			
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all, Vancouver, BC V6T 1Z2	DRAWN RJ	SCALE 1:130	PROJECT 20UBC12	DATE	APR 22, 2021

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In in Prof		

1 SOUTH ELEVATION - RENDER VIEW 1.50 - 1:75

2 EAST ELEVATION - RENDER VIEW 1.50 - 1:75

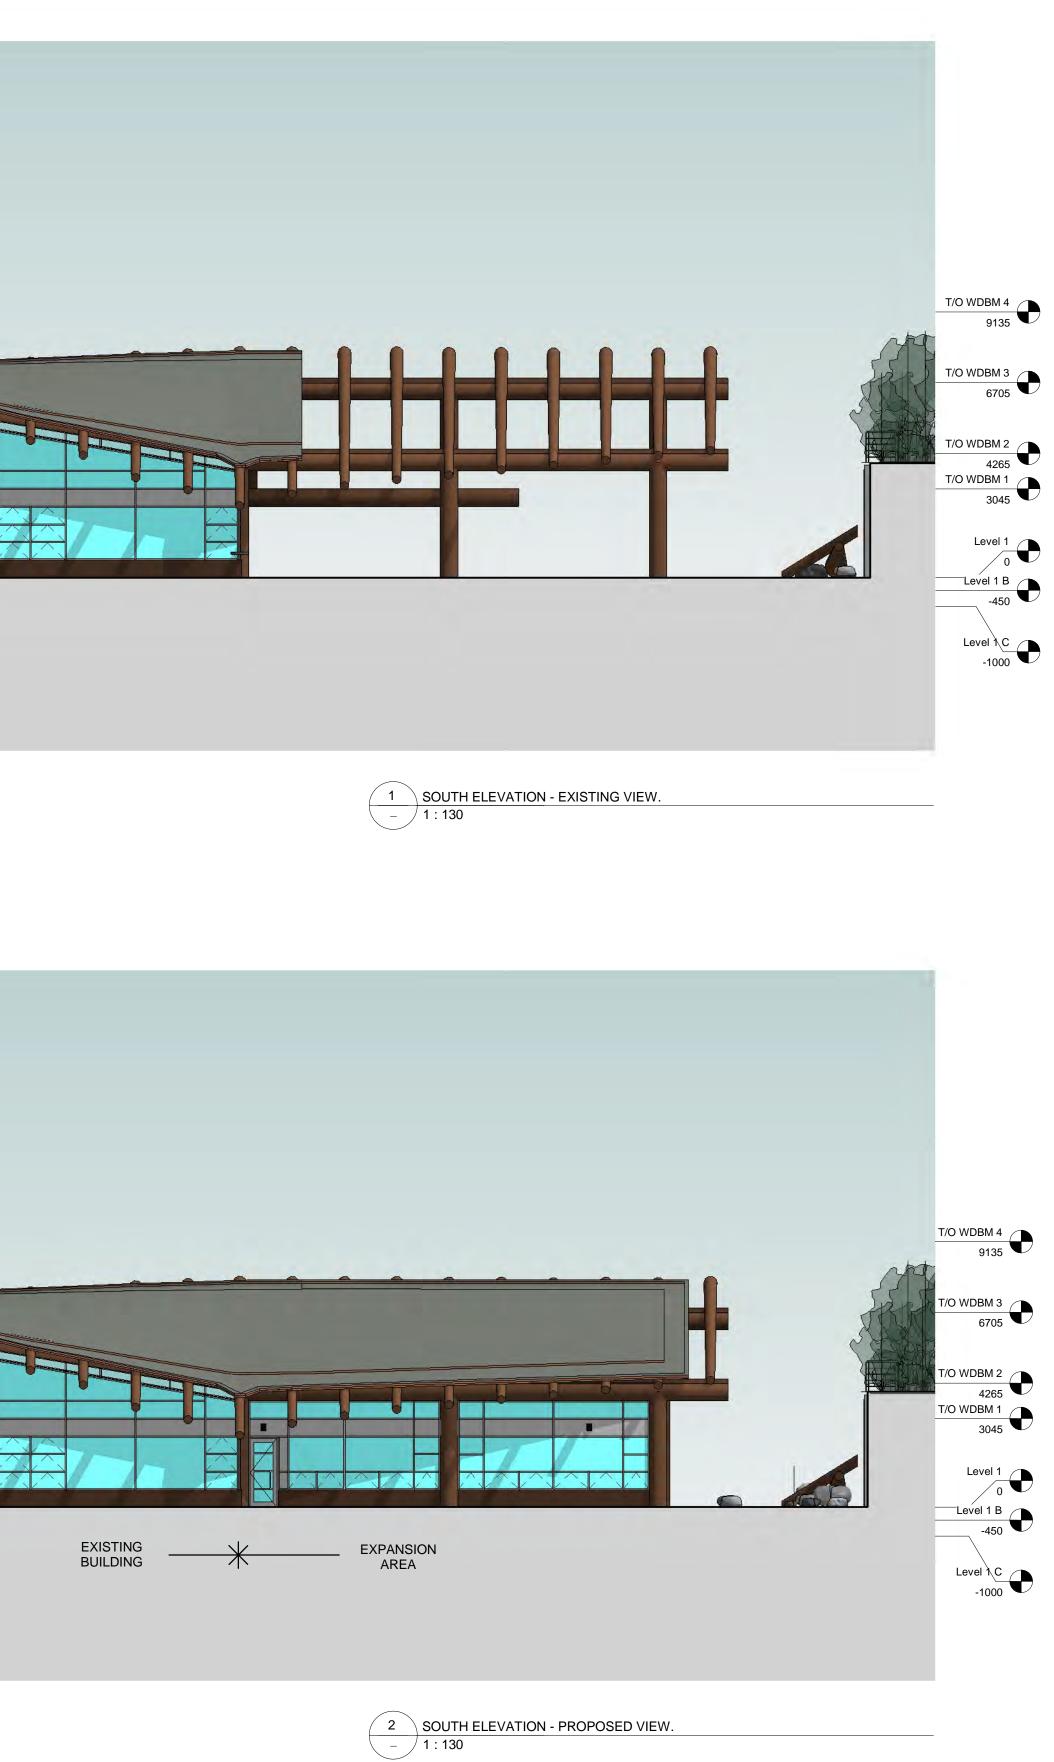
3 NORTH ELEVATION - RENDER VIEW 1.50 _ 1:75

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P1 ROOF



P3 GLAZING CORNER

P4 WOOD SIDING

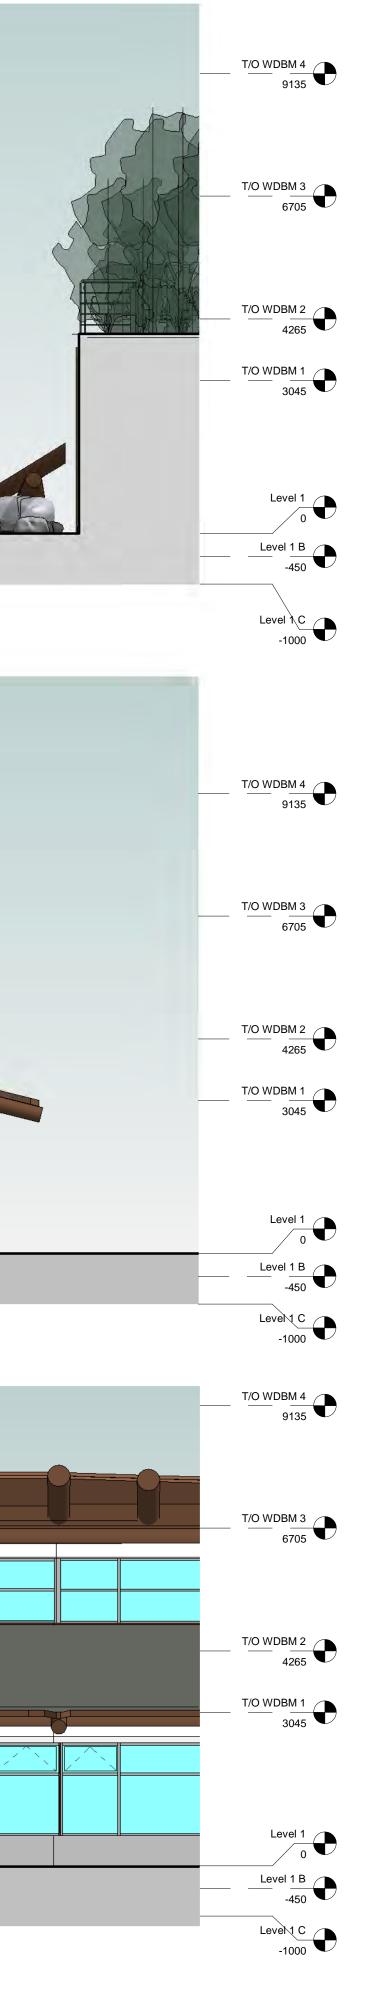

P6 LOWER ROOF




UNIVERSITY OF BRITISH COLUMBIA FIRST NATIONS HOUSE OF LEARNING EXPANSION PROJECT

P2 GLAZING SYSTEM

P5 EXPOSED TIMBER

P7 CLERESTORY

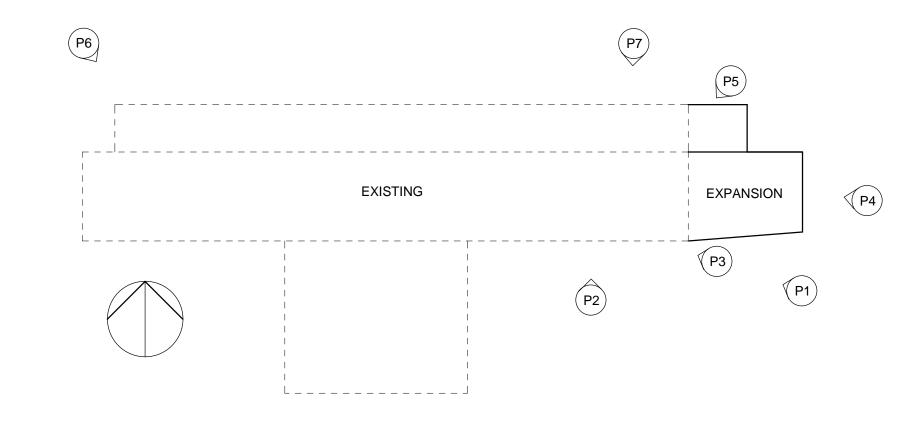


KEY PLAN

ELEVATIONS & MATERIALS				
A016.2				
DRAWN	SCALE		DATE	APR 22, 2021
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1985 West Mall, Vancouver, BC V6T 1Z2



1 NORTH EAST VIEW.

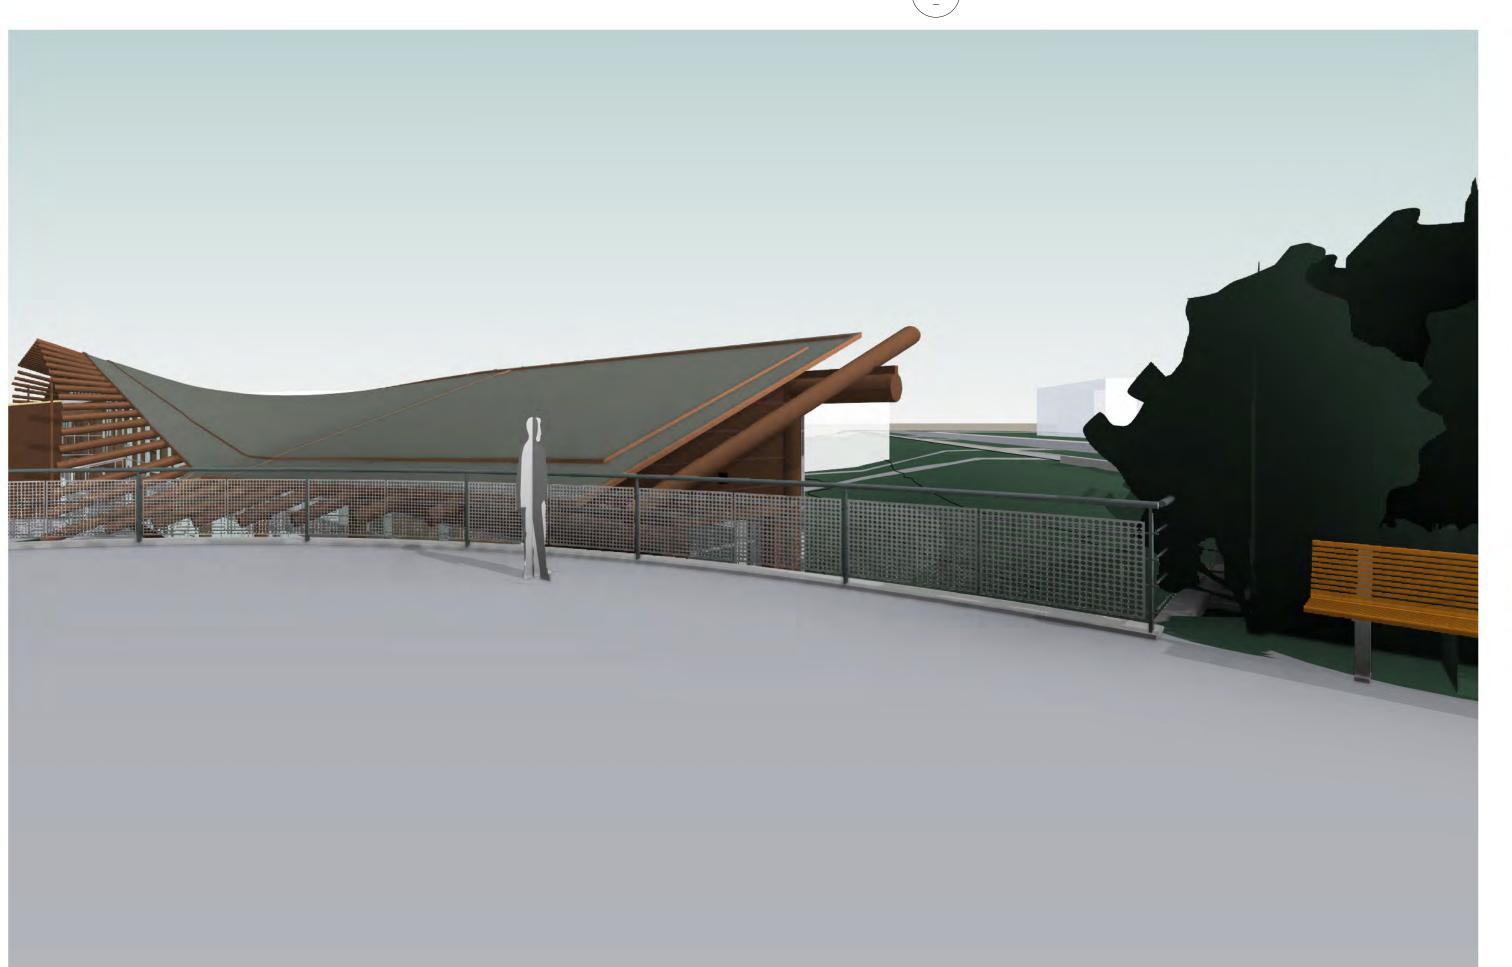


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2 SOUTH EAST CORNER FROM LIBRARY ROOF.





(1)

3

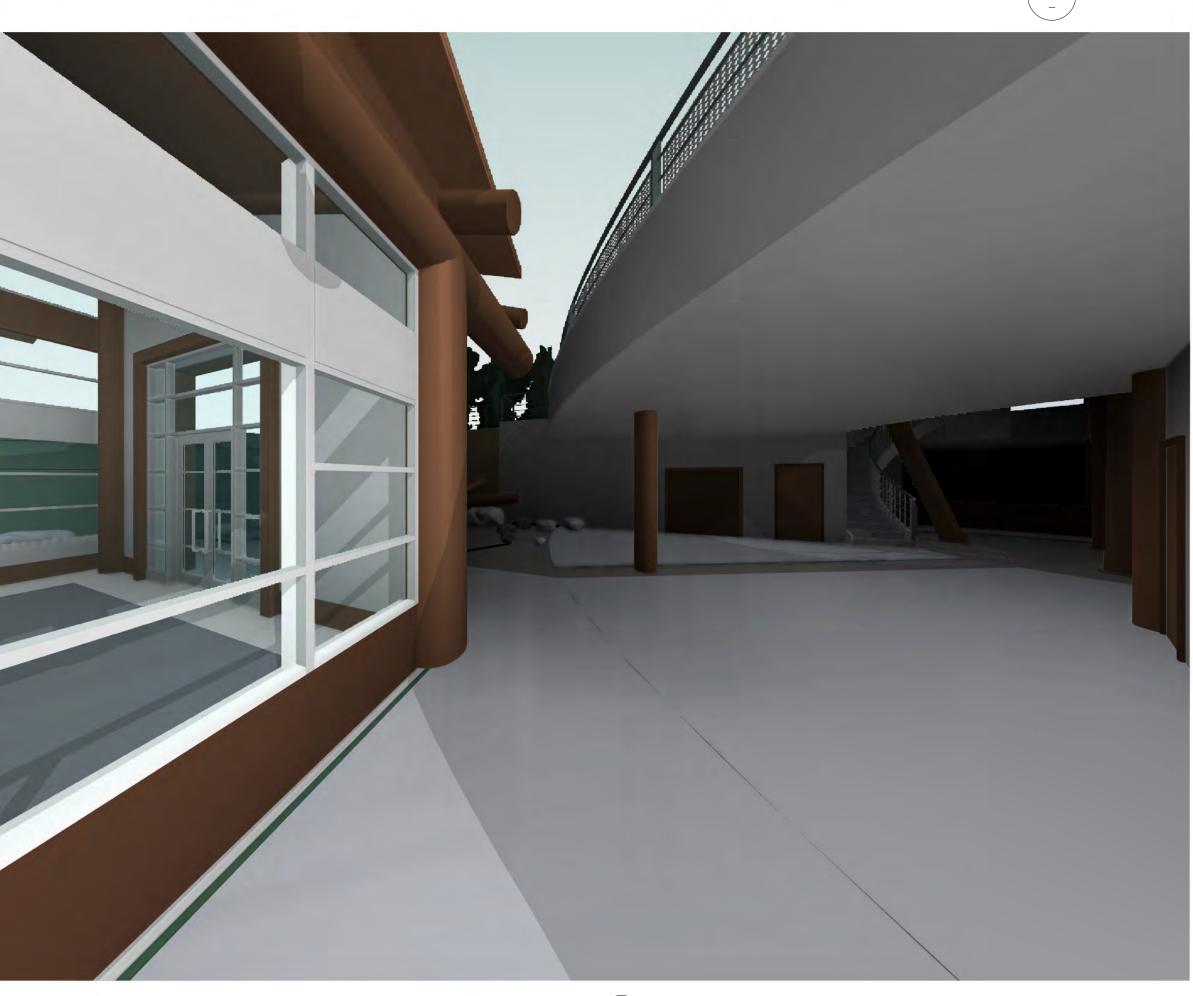4 2

KEY PLAN

3 SOUTH ELEVATION VIEW.

4 VIEW TOWARDS LIBRARY ALONG SOUTH WALL.

UNIVERSITY OF BRITISH COLUMBIA FIRST NATIONS HOUSE OF LEARNING EXPANSION PROJECT

BIRD'S EYE DETAIL VIEWS A017 DRAWN SCALE RJ NTS PROJECT DATE APR 22, 2021 20UBC12

1985 West Mall, Vancouver, BC V6T 1Z2

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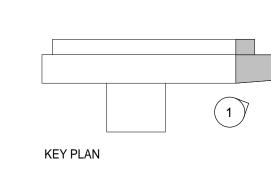
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2

UNIVERSITY OF BRITISH COLUMBIA FIRST NATIONS HOUSE OF LEARNING EXPANSION PROJECT

4 VIEW OF COURTYARD AREA 2. _

EYE LEVEL VIGNETTES

A018

1985 West Mall, Vancouver, BC V6T 1Z2

DRAWN SCALE RJ NTS

PROJECT DATE 20UBC12

APR 22, 2021



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1 INTERIOR OF MULTI-PURPOSE ROOM - EAST WALL.

2 MULTI-PURPOSE ROOM - NORTH WALL - (MEETING ROOM WALL OPEN)







KEY PLAN

1) 2

3

3 MULTI-PURPOSE ROOM - EAST WALL (MEETING ROOM WALL CLOSED)

4 MULTI-PURPOSE ROOM - EAST WALL - (MEETING ROOM WALL OPEN)

UNIVERSITY OF BRITISH COLUMBIA FIRST NATIONS HOUSE OF LEARNING EXPANSION PROJECT

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P4

P3





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3 LIBRARY RAILING VIEW 2




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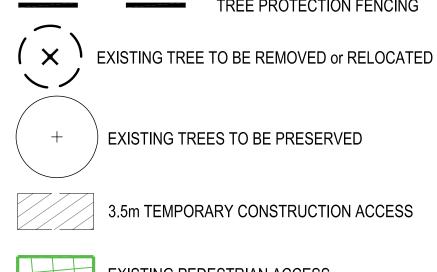




- PROTECTION OF TREES 3. ALL TREE RETENTION, PROTECTION AND REPLACEMENT SHALL BE IN ACCORDANCE
- WITH UBC GUIDELINES FOR PROTECTION OF TREES AS PER UBC GUIDELINES FOR PROTECTION OF TREES, TREE PROTECTION BARRIERS MUST BE A MINIMUM HEIGHT OF 1.2m MEASURED FROM THE GROUND AND MUST
- MEET THE DISTANCE REQUIREMENT TO CALIPER TREE PROTECTION BARRIERS IN STREET BOULEVARDS ADJACENT TO THE SITE
- SHALL BE INSTALLED 0.6m MIN. FROM BACK OF CURB AND 0.3m MIN. FROM EDGE OF ANY SIDEWALK LOCATED WITHIN A GRASS BOULEVARD OR AREA 7. NO STORAGE OF BUILDING /CONSTRUCTION MATERIALS WITHIN OR AGAINST
- PROTECTION BARRIER. 8. PROTECTION FENCE IS NOT TO BE LIFTED OR REMOVED AT ANY TIME FOR VEHICULAR ACCESS. VEHICLES AND HEAVY EQUIPMENT CAN CAUSE SOIL COMPACTION IN THE ROOT ZONE DEPLETING THE AIR SPACE THAT IS ESSENTIAL TO THE TREE'S HEALTH.
- 9. THE CONTRACTOR SHALL VERIFY ALL EXISTING CONDITIONS PRIOR TO LANDSCAPE FEATURES REMOVAL AND / OR RELOCATION. 10. TRENCHING FOR UTILITY CONNECTIONS TO BE COORDINATED WITH ENGINEERING
- DEPARTMENT TO ENSURE SAFE ROOT ZONES OF RETAINED TREES. METHODS OF TREE PROTECTION FOR STREET TREES TO BE APPROVED BY UBC
- 11. REQUEST UBC TO PRUNE ANY STREET TREE CLEARANCE FOR SIDEWALK, PARKING, HOARDING AND SCAFFOLDING.
- 12. WATER RETAINED TREES AND SHRUBS TO FIELD CAPACITY, ONCE WEEKLY, DURING
- THE GROWING SEASON. 13. TREES IDENTIFIED FOR REMOVAL ARE AN ESTIMATE ONLY, ALL FINAL TREE QUANTITIES FOR REMOVAL SHALL BE CONFIRMED ON SITE.

TREE MANAGEMENT LEGEND

TREE PROTECTION FENCING

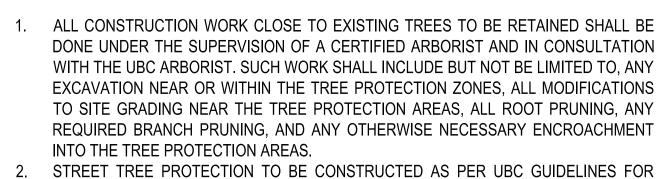

EXISTING TREES TO BE PRESERVED

3.5m TEMPORARY CONSTRUCTION ACCESS

EXISTING PEDESTRIAN ACCESS

INSTALLATION OF 'TEMPORARY CONSTRUCTION ACCESS ROUTE'


- PROPOSED TEMPORARY CONSTRUCTION ACCESS ROUTE FROM LOWER MALL ROADWAY, OVER CURB + GUTTER, ACROSS SIDEWALK AND ALONG EXISTING PAVED WALKWAY, ACROSS ARBORETUM LAWN AREA TO LONGHOUSE EXPANSION CONSTRUCTION SITE, AS SHOWN;
- PROVIDE TEMPORARY CONSTRUCTION ACCESS ROUTE 'RESILIENT' SURFACING TO PROTECT TREE ROOT ZONES COVERED BY ROUTE; - PROVIDE CONSTRUCTION HOARDING WITH ALL NECESSARY ACCESS CONTROL (LOCKABLE GATE), AS REQUIRED;
- PROPOSED ACCESS THROUGH EXISTING ARBORETUM AREA, DOWN SHORT SLOPE AT EDGE OF EXISTING LONGHOUSE SIDEWALK PAVING (ESTIMATED 4:1 SLOPE), PROVIDE ALL NECESSARY SLOPE STABILIZATION MEASURES, ACCESS ROUTE SURFACING AMOUR;
- INSTALLATION OF TEMPORARY CONSTRUCTION ACCESS ROUTE PER UBC ARBORIST RECOMMENDATIONS, REVIEW AND APPROVAL - INSTALLATION OF TEMPORARY CONSTRUCTION ACCESS ROUTE PER CIVIL
- AND GEOTECHNICAL ENGINEERING DESIGN AND SPECIFICATIONS


PROPOSED 3m-TEMPORARY CONSTRUCTION ACCESS


 \rightarrow

KOMER MAR

3000

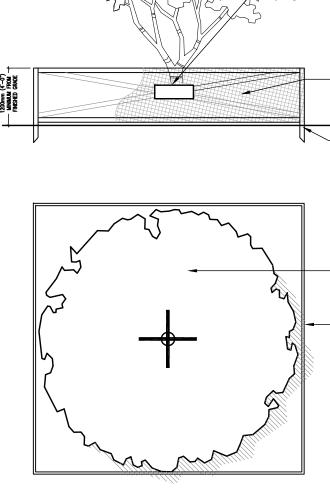

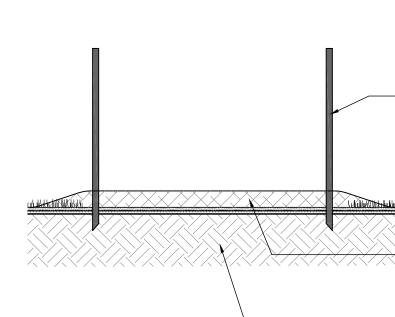

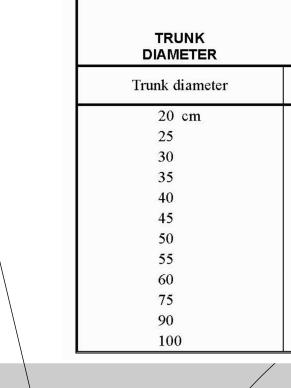

1.2m OVER PLANTING OF REPLACEMENT/LAWN



TREES GUIDELINES' **"TREE PROTECTION AREA - NO** ENTRY" AND SHALL ALSO READ: NO DUMPING, NO FILLING, NO DIGGING OR EXCAVATING. NO LUMBER OR SUPPLY STORAGE"

SNOW FENCING - (PLASTIC MESH SCREENING) SECURELY FASTENED TO WOOD FRAME SOLID BARRIER

50x100 (2"x4") WOOD POSTS 50x100 (2"x4") WOOD CROSS BRACE RAILS NAILED TO: 50x100 (2"x4") TOP AND BOTTOM WOOD RAILS

RETENTION TREE - EXISTING TREE TO BE PROTECTED 50x100 (2"x4") MIN. WOOD FRAME - FOR DIMENSIONS REFER TO 'TREE PROTECTION FENCING DISTANCE CHART.

- TO DRIPLINE OF TREE (MIN. OUTSIDE OF BRANCHES) NOTES REFER TO ARBORIST REPORT

TEMPORARY ACCESS

SECTION

50x100 (2"x4") MIN. WOOD FRAME - FOR DIMENSIONS REFER TO 'TREE

PROTECTION FENCING DISTANCE CHART.

- TO DRIPLINE OF TREE

(MIN. OUTSIDE OF BRANCHES)

10" MULCH PER SPECS RESILIENT SURFACE FOR PROTECTION OF TREE ROOTS ZONE OR OTHER PEF UBC ARBORIST RECOMMENDATIONS

- COMPACTED SUBGRADE

MINIMUM

PROTECTION

REQUIRED

AROUND TREE

Distance from trunk

1.2 m

1.5

1.8 2.1

2.4 27


3.0

3.3

3.6


5.0

6.0

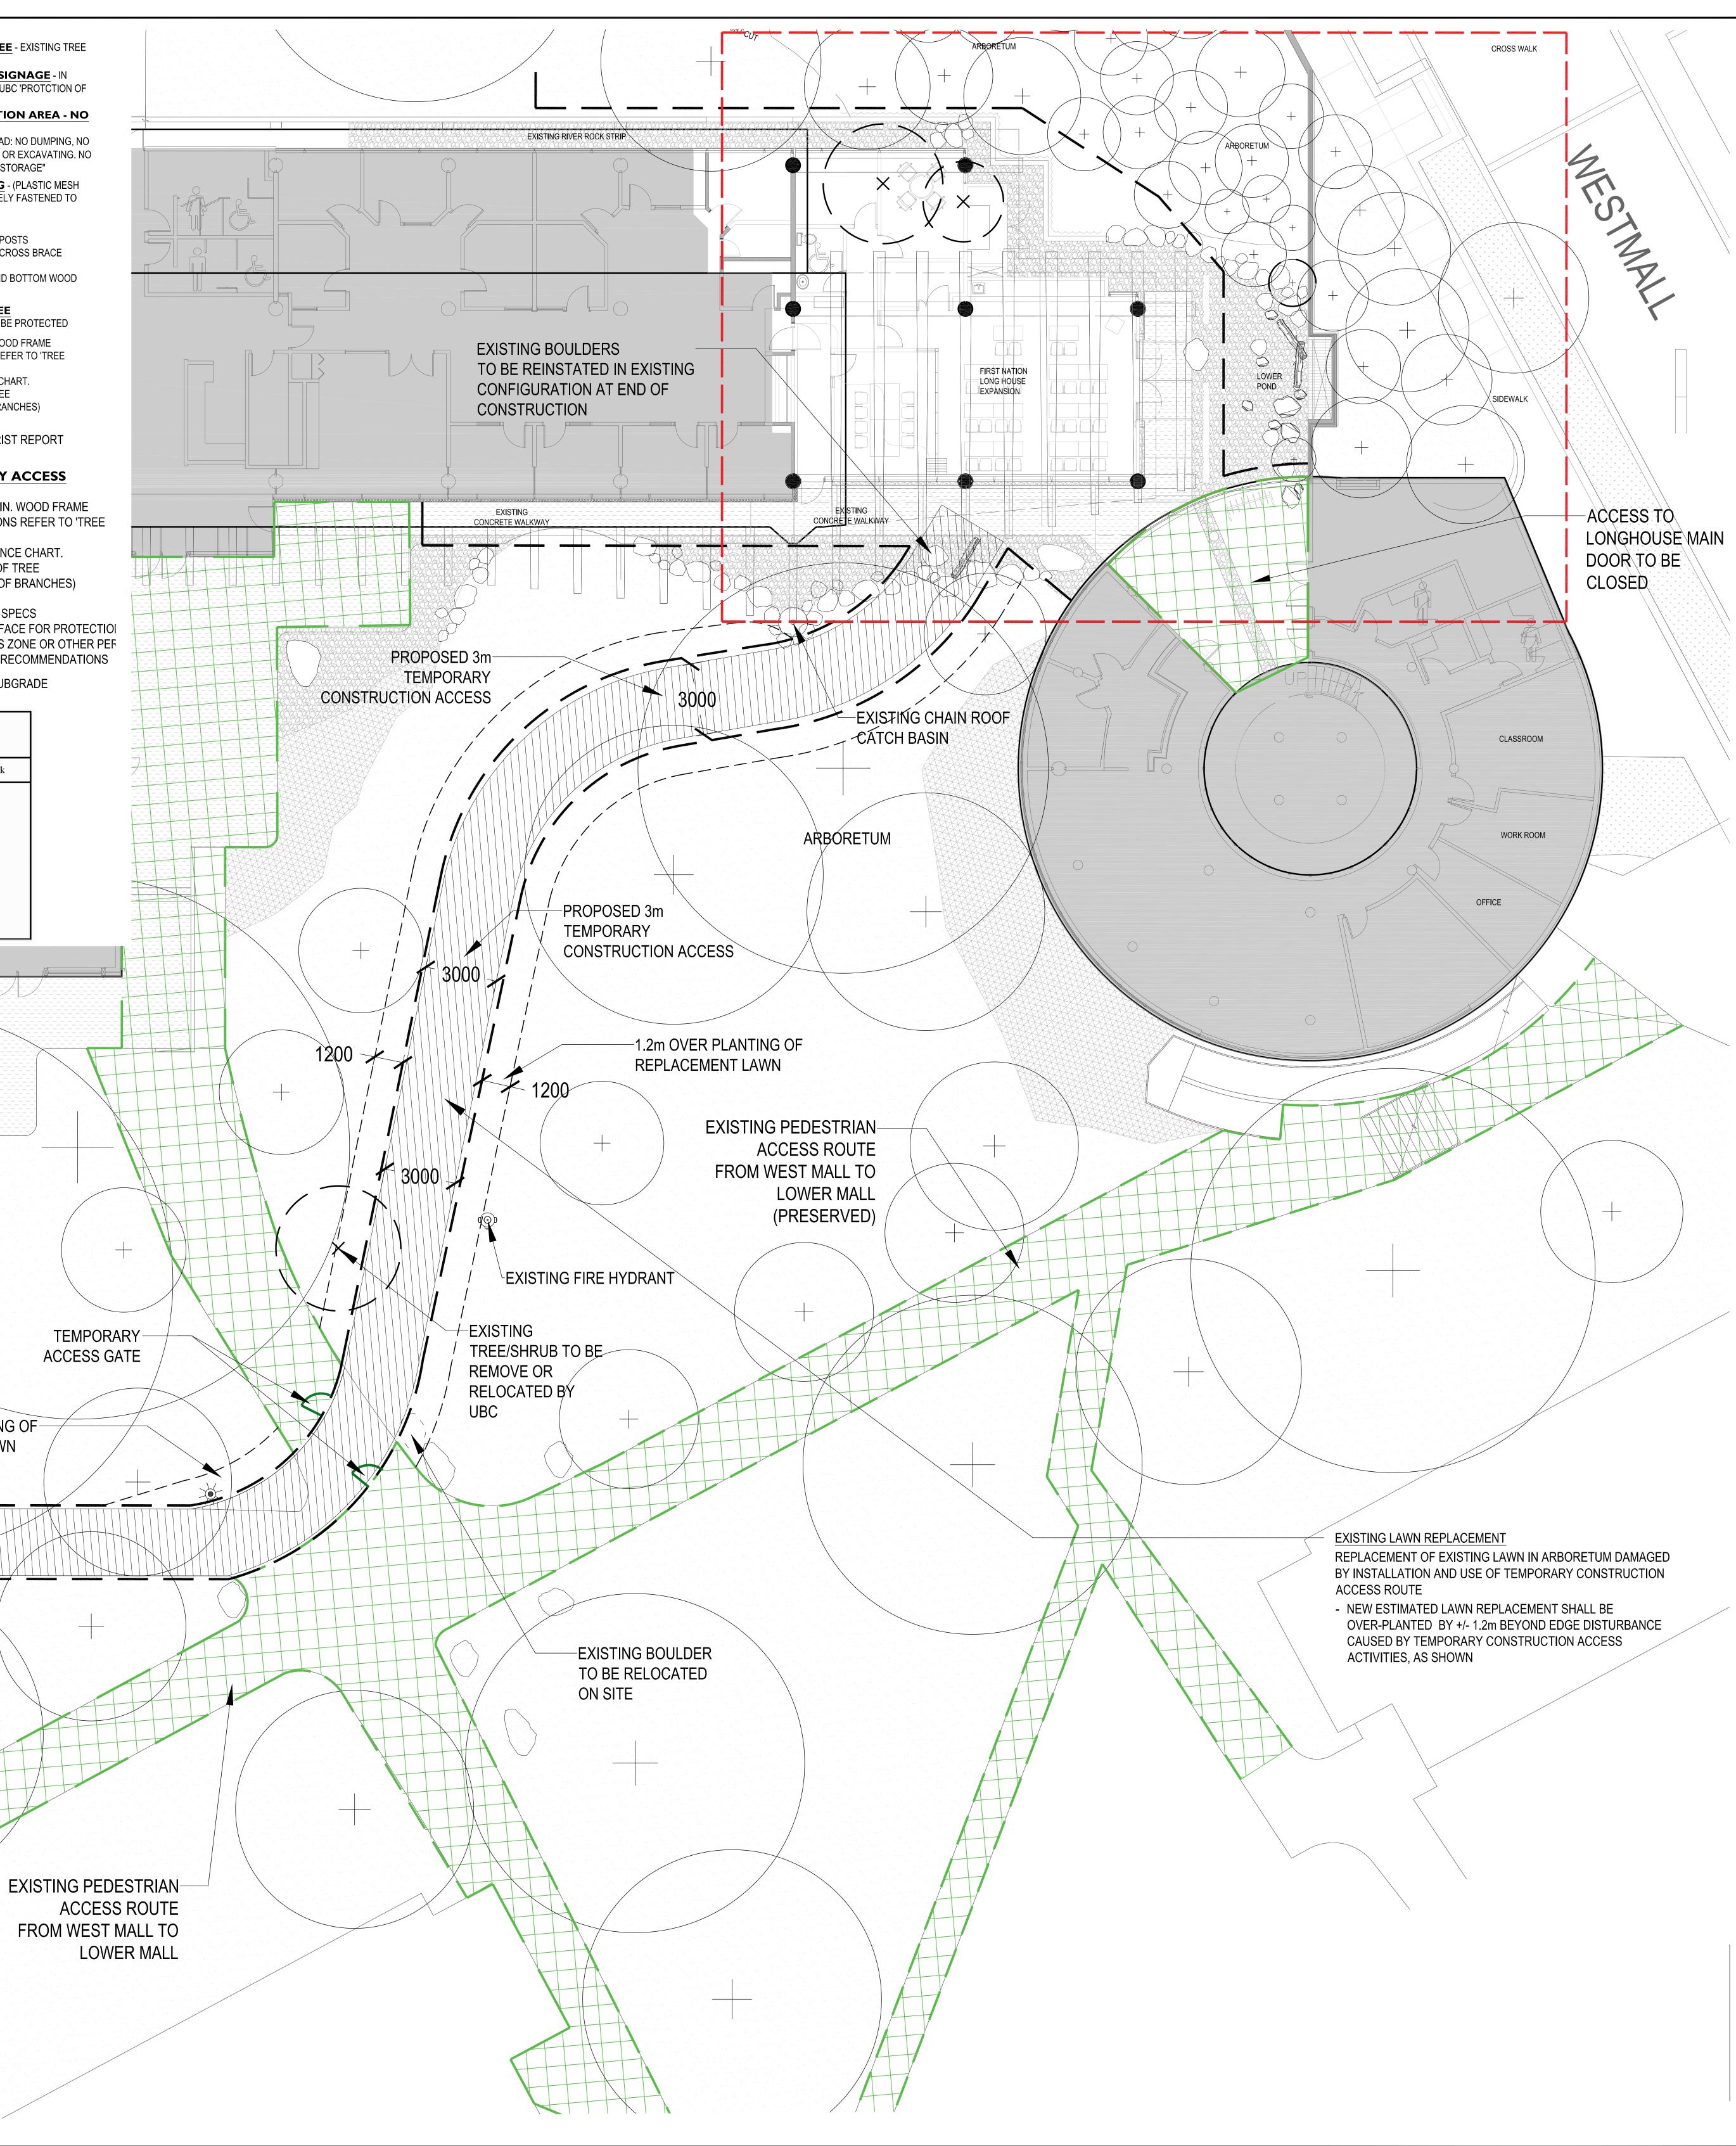

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No.	Date	Details	Ву
1	2020.12.23	ISSUED FOR FEASIBILITY STAGE COSTING	CM/J
2	2021.03.15	ISSUED FOR 50% PROGRESS COSTING	CM/J
3	2021.04.08	ISSUED FOR DRAFT 90% COORDINATION	CM/J
4	2021.04.26	ISSUED FOR DEVELOPMENT PERMIT	CM/J

STAMP:

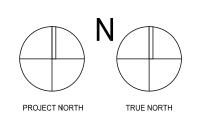PROJECT NAME: UBC, FIRST NATIONS LONG HOUSE EXPANSION DRAWING TITLE:


TREE MANAGEMENT AND TEMPORARY CONSTRUCTION ACCESS PLAN

PFS PROJECT NUMBER: DATE: 12/23/2020 20040 CHECKED BY: DRAWN BY: CM/CP

SCALE: AS SHOWN

DWG NO

L1.0

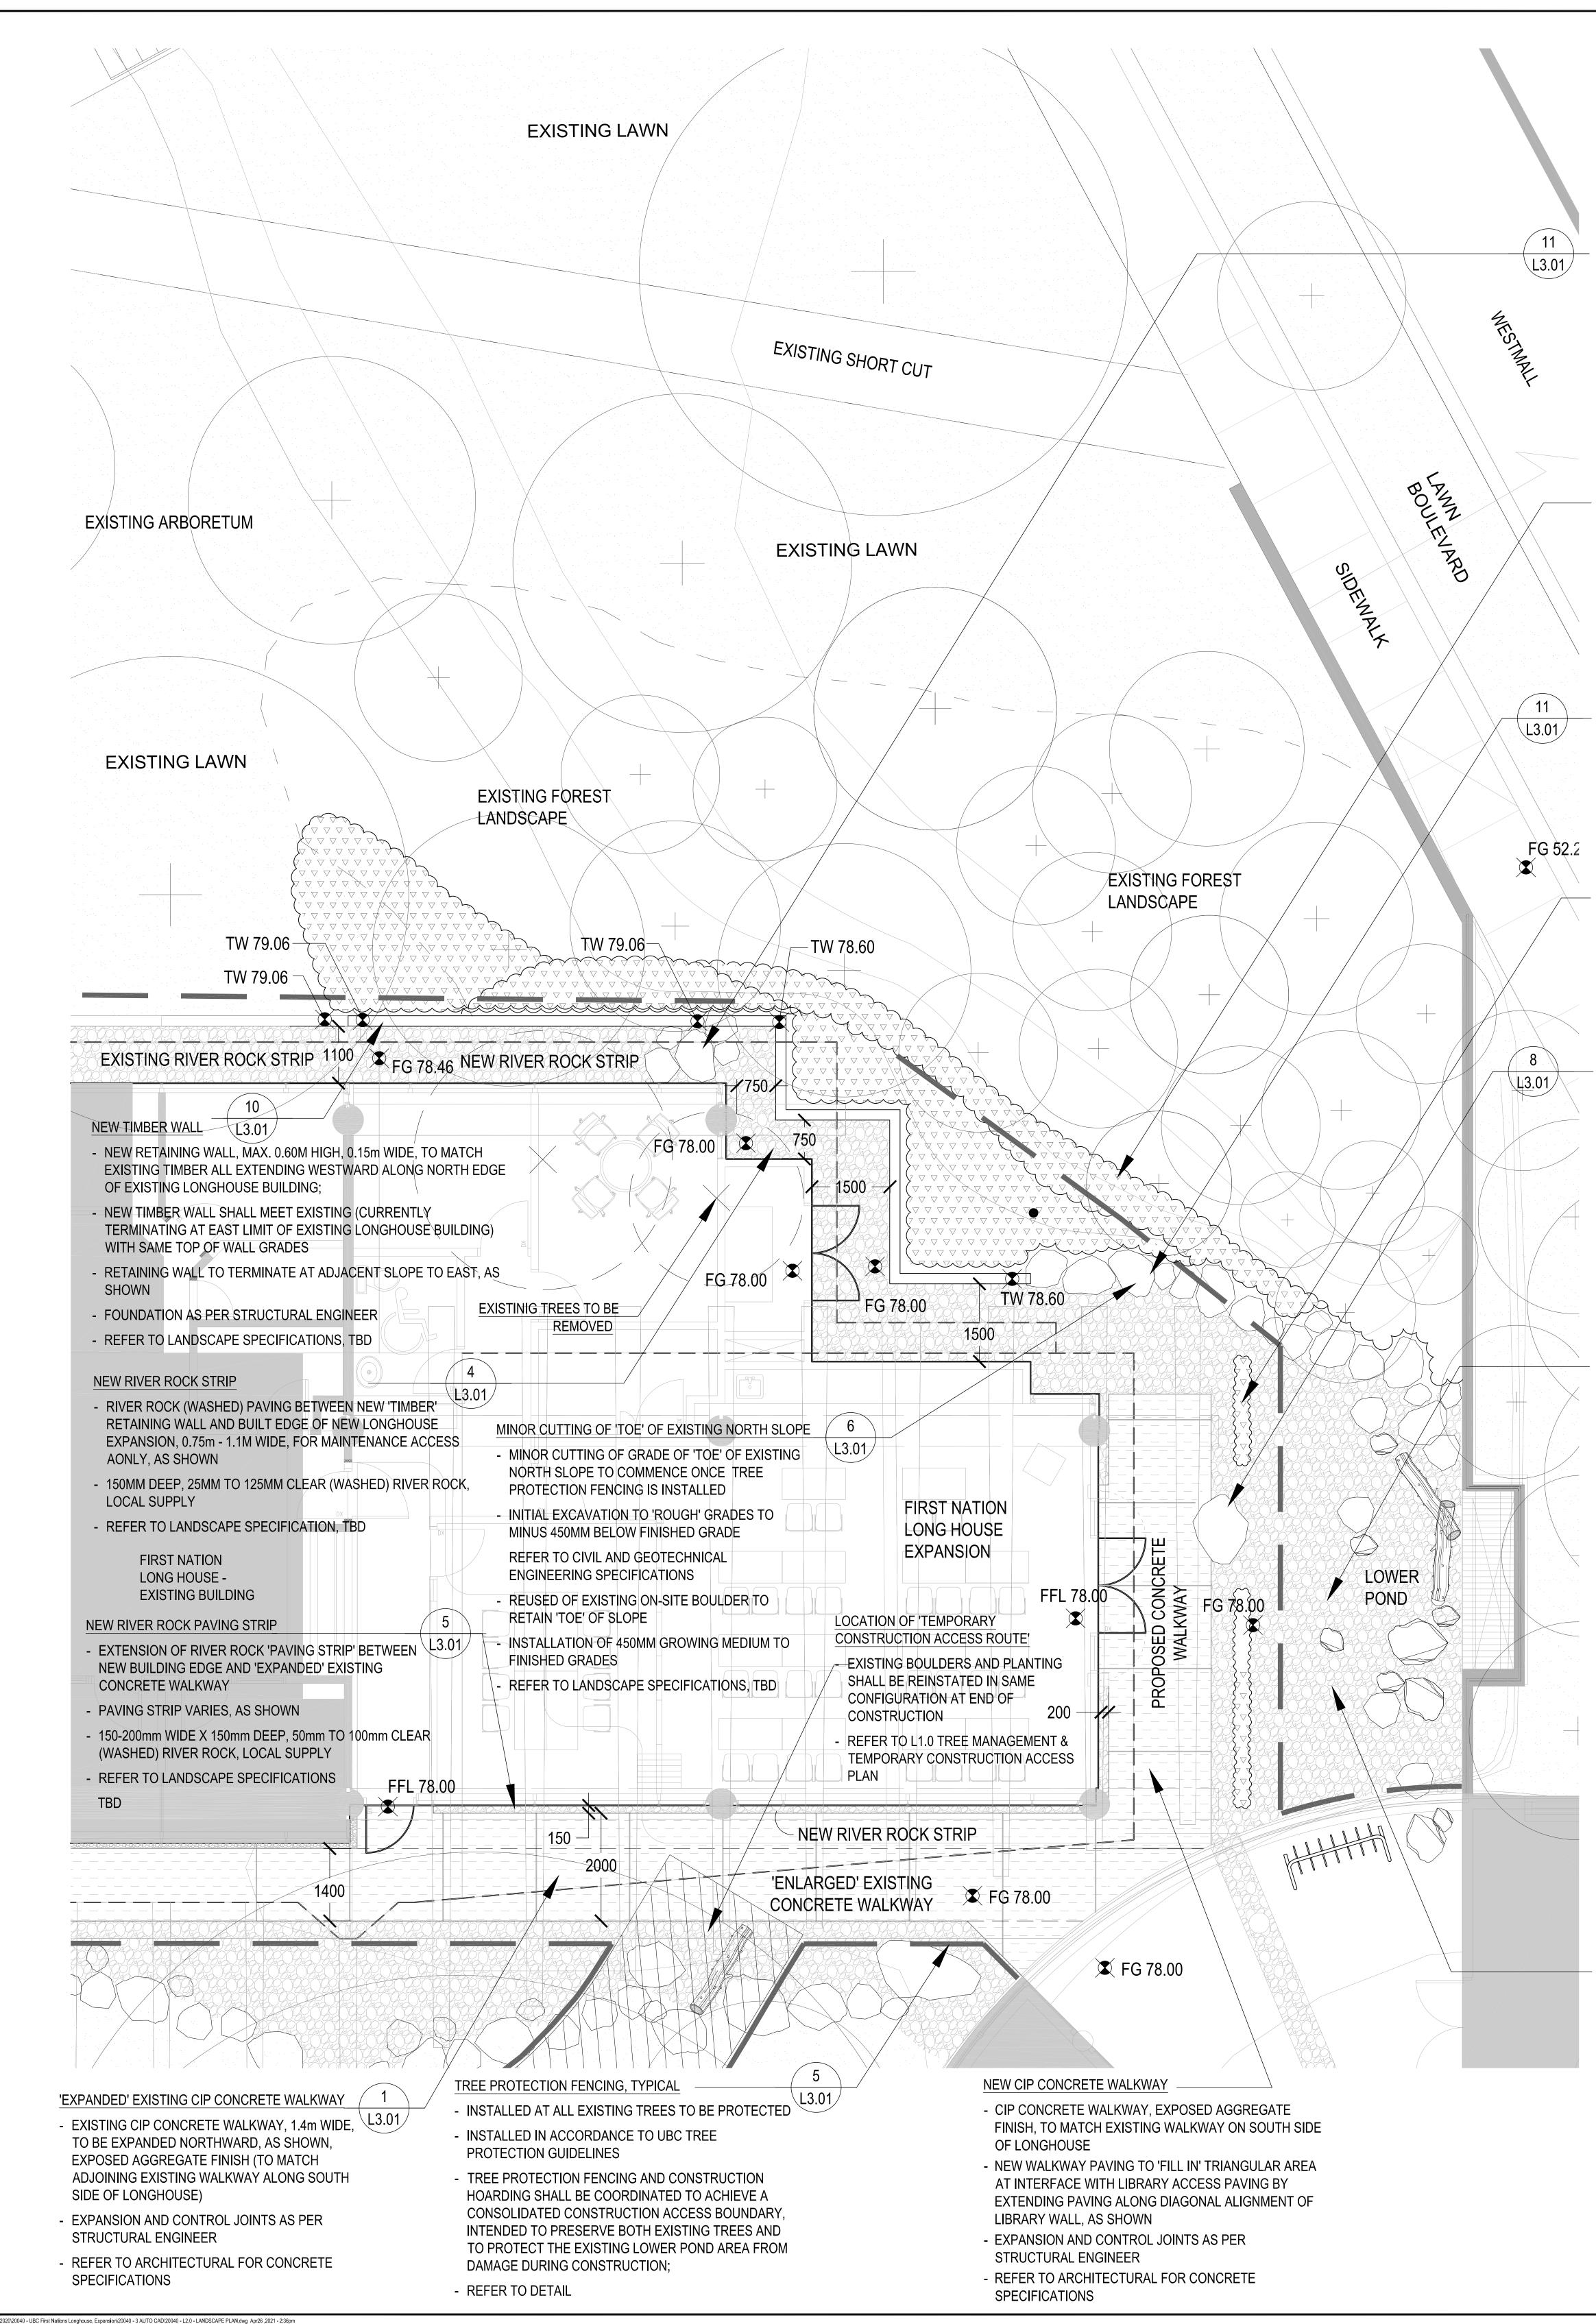

TREE REMOVALS

- REMOVALS OF EXISTING TREES WITHIN THE EXCAVATION 'FOOTPRINT' OF PROPOSED BUILDING ONLY. NO OTHER TREE REMOVALS ARE PERMITTED.
- REFER TO LANDSCAPE DRAWING L1.0 TREE MANAGEMENT AND TEMPORARY CONSTRUCTION ACCESS PLAN
- FINAL QUANTITIES OF TREE REMOVALS SHALL BE DETERMINED ON SITE

STEP IN GRADE OF RIVER ROCK STRIPS

- THE STEP IN GRADE BEWTEEN RIVER ROCK STRIPS (EXISTING AND NEW) AT ELEVATION 78.46 TO NEW RIVER ROCK STRIP AT ELEVATION 78.00, SHALL STEP DOWN (RETAIN) THE DIFFERENCE IN ELEVATION OF 0.46m THROUGH THE REUSE OF BOULDERS AT THE TERMINAL END OF THE NEW TIMBER WALL, AS SHOWN; - BOULDERS SHALL ALSO BE REUSED TO RETAIN TOE OF EXISTING NORTH FORESTED SLOPE, AS SHOWN;
- ALL BOULDERS SHALL BE SALVAGED FROM SITE CLEARING + EXCAVATION, NO BOULDERS SHALL BE IMPORTED OR REMOVED FROM SITE;
- REFER TO STRUCTURAL ENGINEER FOR FOUNDATION

PROPOSED INSTALLATION OF NEW NATIVE 'SHRUB MASSES'

- ESTIMATED GROUND COVERING SHRUBS MASSES ARE OVER-PLANTED BY +/- 1.2m BEYOND EDGE DISTURBANCE CAUSED BY CONSTRUCTION ACTIVITIES, AS SHOWN
- FINAL TOTAL AREA FOR INSTALLATION OF SHRUB MASSES SHALL BE
- DETERMINED ON SITE - REFER PLANT LIST ESTIMATED QUANTITIES OF PLANT MATERIAL

REUSE OF EXISTING BOULDERS

- EXISTING BOULDERS SHALL BE RELOCATED TO TERMINAL END OF TIMBER RETAINING WALL, AND ALONG TOE OF NORTH FORESTED SLOPE INTENDED TO RETAIN GRADE AT LOCATION WHERE TIMBER RETAINING WALL MEETS ADJACENT TO FOREST SHRUB MASSES AND TO HIDE TERMINAL END OF TIMBER RETAINING WALL. ALL BOULDERS SHALL BE SALVAGED FROM SITE CLEARING + EXCAVATION, NO BOULDERS SHALL BE IMPORTED OR REMOVED FROM SITE:

NEW WATER EDGE "IRIS" STRIP PLANTING

- 2 ROWS OF SEASONAL NATIVE 'PURPLE' IRIS PLANTING ALONG EDGE OF NEW CONCRETE WALKWAY
- NEW IRIS ROWS COMPLIMENT EXISTING WATER EDGE PLANTING OF WATER FEATURE AREA
- PROVIDE SEASONAL INTEREST AND DEFINITION OF WATER FEATURE PAVING EDGE
- FEATURE 'REUSED' BOULDER FOR SEATING
- LARGE FEATURE BOULDER REUSED FOR SEATING
- (SALVAGED FROM SITE CLEARING + EXCAVATION) LOCATED AT EDGE AND 'NOTCHED' INTO PROPOSED CONCRETE WALKWAY, AS SHOWN

LANDSCAPE CONCEPT


TO COMPLETE THE EXPANSION PROJECT.

THE INTENT IS THAT THE COMPLETED LONGHOUSE EXPANSION WILL 'NESTLE' QUIETLY INTO THE EXISTING LANDSCAPE, AND APPEAR TO HAVE ALWAYS BEEN THERE, WITH A NATIVE FOREST HAVING GROWN NATURALLY TO ENCLOSE IT OVER TIME. SPECIAL CARE WILL BE TAKEN TO PRESERVE EXISTING TREES WITHIN THE 'FOREST LANDSCAPE' CURRENTLY SURROUNDING THE LONGHOUSE AND ADJACENT WATER FEATURE, AS WELL AS WITHIN THE EXISTING "DAVIDSON ARBORETUM" IN WHICH THE ORIGINAL LONGHOUSE IS LOCATED. TO PREPARE SPACE FOR THE LONGHOUSE EXPANSION ITSELF, ONLY 2 TOTAL EXISTING 'SMALLER' FOREST TREES WILL NEED TO BE REMOVED, DUE TO EXCAVATION FOR FOOTPRINT OF LONGHOUSE EXPANSION. MINOR 'CUTTING' OF A PORTION OF THE 'TOE' OF THE EXISTING FORESTED SLOPE IMMEDIATELY NORTH OF THE EXPANSION IS ALSO REQUIRED TO PROVIDE SPACE FOR LONGHOUSE EXPANSION. ALL NEW PLANT MATERIAL PROPOSED WILL BE NATIVE SHRUBS AND GROUND COVER, TO ENHANCE THE EXISTING NATIVE FOREST LANDSCAPE THAT HAS BECOME AN IDENTIFYING COMPONENT OF THIS EXISTING LONGHOUSE FACILITY.

LANDSCAPE 'SCOPE OF WORK'

- TREE PRESERVATION MEASURES
- MINOR CUTTING AND RETENTION OF A PORTION OF THE 'TOE' OF EXISTING NORTH SLOPE AS NEEDED TO CONSTRUCT LONGHOUSE EXPANSION AND FOR MAINTENANCE SPACE AROUND EDGE OF NEW BUILDING ONLY;
- INSTALLATION OF NEW TIMBER RETAINING WALL TO MATCH EXISTING ALONG NORTH SIDE OF EDGE OF ADJACENT TOE OF EXISTING NORTH SLOPE, AS SHOWN;
- INSTALLATION OF CIP CONCRETE WALKWAY ACROSS EAST ELEVATION OF LONGHOUSE EXPANSION ADJACENT TO WALKWAY OCCURS DURING CONSTRUCTION OF WALKWAY OR LONGHOUSE EXPANSION
- PRESERVATION OF EXISTING POND LINER AND POND EDGE LANDSCAPE NEW LONGHOUSE EXPANSION;
- REUSE OF LANDSCAPE BOULDERS, SALVAGED FROM EXISTING SITE ONLY, AS NEEDED FOR LANDSCAPE FEATURE AT EDGE OF PAVING
- INSTALLATION OF NEW 'SHRUB MASSING PLANT MATERIAL, FOR ALL AREAS OF EXISTING SITE LANDSCAPE DISTURBED BY CONSTRUCTION ACTIVITIES; - MINIMUM 1 YEAR MAINTENANCE OF ALL INSTALLED PLANT MATERIAL FOR WARRANTY.

LANDSCAPE LEGEND

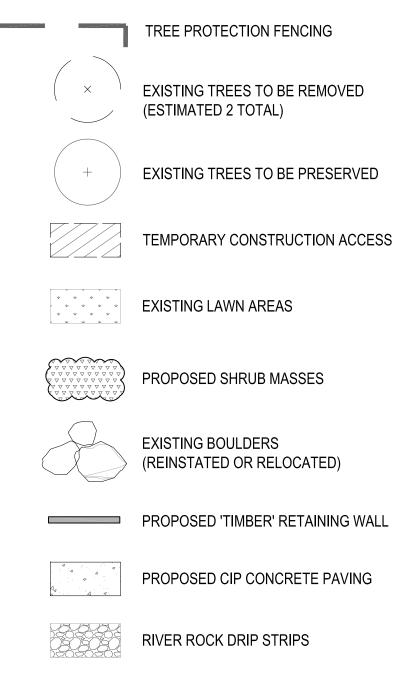

SCHEMATIC PLANT LIST

KEY	QTY	BOTANICAL/ COMMON NAME	SIZE/CONDITION
SHRUBS			
Rs	7	RUBUS SPECTABILIS/ SALMONBERRY	#3 POT, FULL
Vp	9	VACCINIUM PARVIFOLIUM / RED HUCKLEBERRY	#3 POT, FULL
GROUND	COVER		
gs	195	GAULTHERIA SHALLON / SALAL	#2 POT, FULL, @ 0.38M O.C.
CC	153	CORNUS CANADENSIS / BUNCHBERRY DOGWOOD	#2 POT, FULL, @ 0.30M O.C.
PERENNI	ALS		
id	48	IRIS DOUGLASIANA / DOUGLAS IRIS	#3 POT, FULL, @ 0.30M O.C
FERNS			
Pmn	25	POLYSTICHUM MUNITUM / WESTERN SWORD FERN	#3 POT, FULL, @ 0.45M O.C.
Bs	35	BLECHNUM SPICANT / DEER FERN	#3 POT, FULL, @ 0.45M O.C.

PRESERVATION OF EXISTING POND LINER AND POND EDGE LANDSCAPE

- SPECIAL ATTENTION REQUIRED TO ENSURE NO DISTURBANCE TO EXISTING POND LINER
- ADJACENT TO WALKWAY OCCURS DURING CONSTRUCTION OF WALKWAY OR LONGHOUSE EXPANSION

INSTALLATION OF NEW PLANT MATERIAL

INSTALLATION OF NEW PLANT MATERIAL INCLUDING SHRUB MASSES AND GROUNDCOVER FOR ALL AREAS OF EXISTING SITE LANDSCAPE DAMAGED OR DISTURBED BY CONSTRUCTION ACTIVITIES

ESTIMATED AREAS INCLUDE:

- MINOR 'CUTTING' OF EXISTING NORTH SLOPE:
- EXISTING LANDSCAPE ADJACENT TO RIVER ROCK PAVING STRIP ALONG NORTH SIDE OF LONGHOUSE EXPANSION - RE-INSTATEMENT FOR RIVER ROCK, BOULDERS AND WATER EDGE PLANTING ADJACENT TO WATER FEATURE POND, WHERE DISTURBED OR DAMAGE DURING CONSTRUCTION OF LONGHOUSE EXPANSION
- FINAL TOTAL AREA FOR INSTALLATION OF SHRUB MASSES SHALL BE DETERMINED ON SITE
- REFER PLANT LIST ESTIMATED QUANTITIES OF PLANT MATERIAL

REPAIR TO LANDSCAPE ADJACENT TO WATER FEATURE POND

- RE-INSTATEMENT OF RIVER ROCK. BOULDERS AND WATER EDGE PLANTING ADJACENT TO WATER FEATURE POND, WHERE DISTURBED OR DAMAGE DURING CONSTRUCTION OF LONGHOUSE EXPANSION
- SPECIAL ATTENTION REQUIRED TO ENSURE NO DISTURBANCE TO EXISTING POND LINER ADJACENT TO WALKWAY OCCURS DURING CONSTRUCTION OF WALKWAY OR LONGHOUSE EXPANSION;

- TREE PROTECTION FENCING IS TO PRESERVE BOTH EXISTING TREES, TO BE PRESERVED AND TO PROTECT THE EXISTING LOWER POND AREA FROM DAMAGE DURING CONSTRUCTION;

THE PROPOSED NEW LANDSCAPE IMPROVEMENTS ASSOCIATED WITH THE FIRST NATIONS LONGHOUSE EXPANSION ADDRESS A 'BASE SCOPE' OF SITE WORK PRIMARILY REQUIRED TO 'MAKE GOOD' OR REPAIR ALL DAMAGE TO EXISTING SITE LANDSCAPE AS A RESULT OF THE CONSTRUCTION ACTIVITIES REQUIRED

- INSTALLATION OF 'TEMPORARY CONSTRUCTION ACCESS ROUTE' FROM LOWER MALL (REFER TO DRAWING L1.0 TREE MANAGEMENT & TEMPORARY CONSTRUCTION ACCESS PLAN);


LONGHOUSE EXPANSION. NEW TIMBER WALL SHALL MEET EXISTING (CURRENTLY TERMINATING AT EAST LIMIT OF EXISTING LONGHOUSE BUILDING) WITH SAME TOP OF WALL GRADES. NEW WALL TO

EXTEND EASTWARD ALONG NORTH ELEVATION OF LONGHOUSE EXPANSION AND TERMINATE AT

AS SHOWN. SPECIAL ATTENTION REQUIRED TO ENSURE NO DISTURBANCE TO EXISTING POND LINER


- INSTALLATION OF RIVER ROCK PAVING BETWEEN NEW 'TIMBER' RETAINING WALL AND BUILT EDGE OF

RETENTION OF EXISTING GRADES ALONG 'TOE' OF EXISTING NORTH FORESTED SLOPE AND AS A

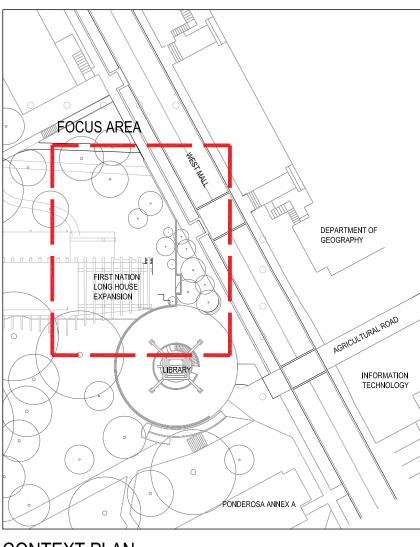

CONTEXT PLAN

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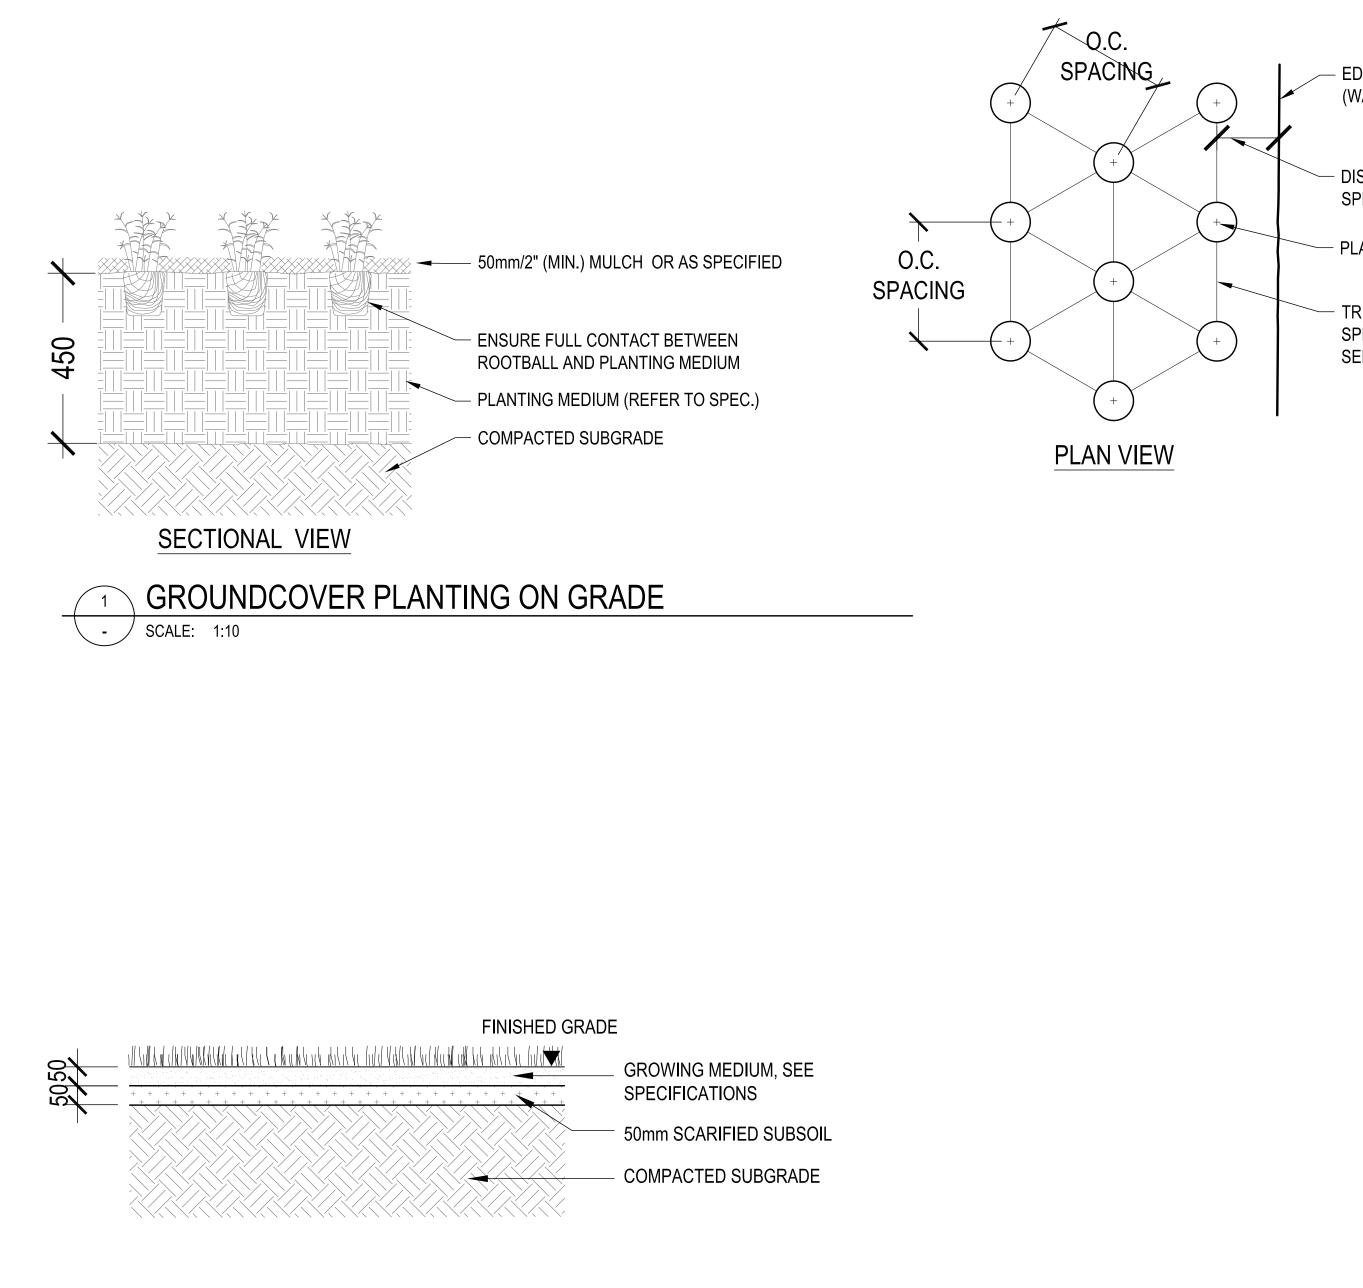
No.	Date	Details	E
1	2020.12.23	ISSUED FOR FEASIBILITY STAGE COSTING	CN
2	2021.03.15	ISSUED FOR 50% PROGRESS COSTING	CN
3	2021.04.08	ISSUED FOR DRAFT 90% COORDINATION	CN
4	2021.04.26	ISSUED FOR DEVELOPMENT PERMIT	CN

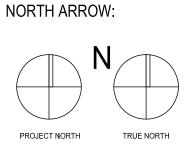X PFS STUDIO	1777 West 3 rd Avenue Vancouver BC V6J 1K7 604.736.5168
PLANNING • URBAN DESIGN • LANDSCAPE ARCHITECTURE	pfs@pfs.bc.ca www.pfs.bc.ca

STAMP:

PROJECT NAME: UBC, FIRST NAT	IONS		
LONGHOUSE EXPANSION			
DRAWING TITLE: LANDSCAPE CONCEPT PLAN			
PFS PROJECT NUMBER: 20040	DATE: 12/23/2020		
DRAWN BY: JL	CHECKED BY: CM/CP		
SCALE: AS SHOWN			

DWG NO L2.0






P:12020\20040 - UBC First Nations Longhouse, Expansion\20040 - 3 AUTO CAD\20040 - L3.0 - DETAILS.dwg Apr26 ,2021 - 2:41pm

- EDGE OF GROUNDCOVER AREA (WALKWAY EDGE)

— DISTANCE FROM EDGE IS HALF THE SPECIFIED ON-CENTER SPACING

- TRIANGULAR SPACING AT SPECIFIED ON-CENTER DISTANCE, SEE PLANT SCHEDULE

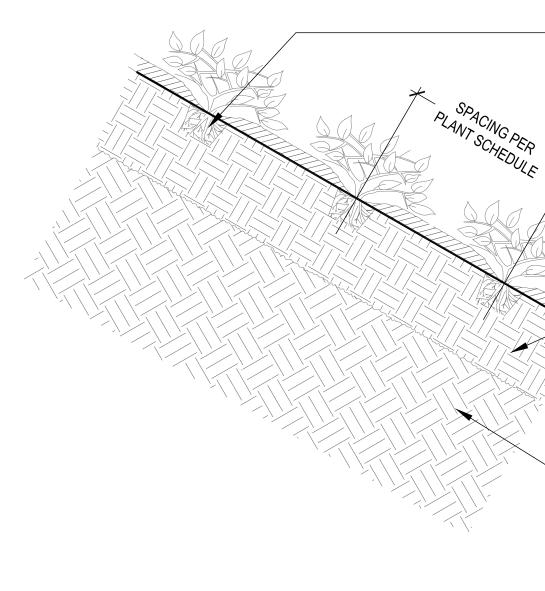




TYPICAL GROUND COVER PLANTED AT NURSERY LEVEL

- FINISH GRADE 50mm MULCH PER SPECS - PLANTING MEDIUM (REFER TO SPEC.) MIN. 450mm DEPTH

- COMPACTED SUBGRADE

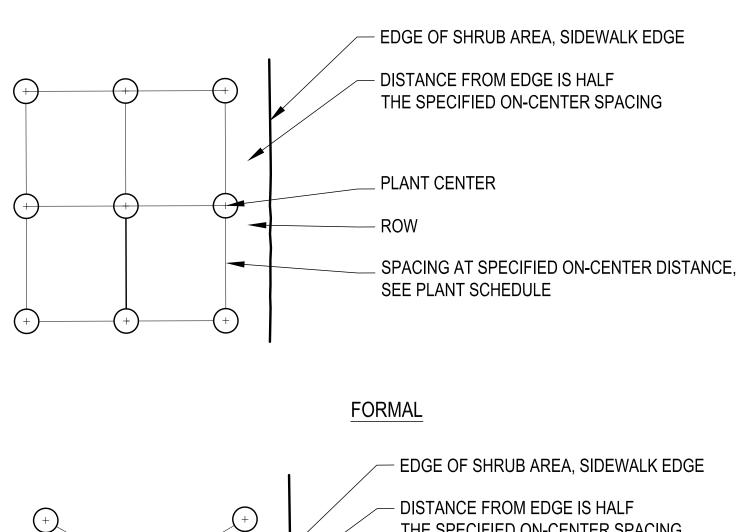


THE SPECIFIED ON-CENTER SPACING _ PLANT CENTER (+)-– ROW _ TRIANGULAR SPACING AT SPECIFIED ON-CENTER DISTANCE, SEE PLANT SCHEDULE

TRIANGULATION

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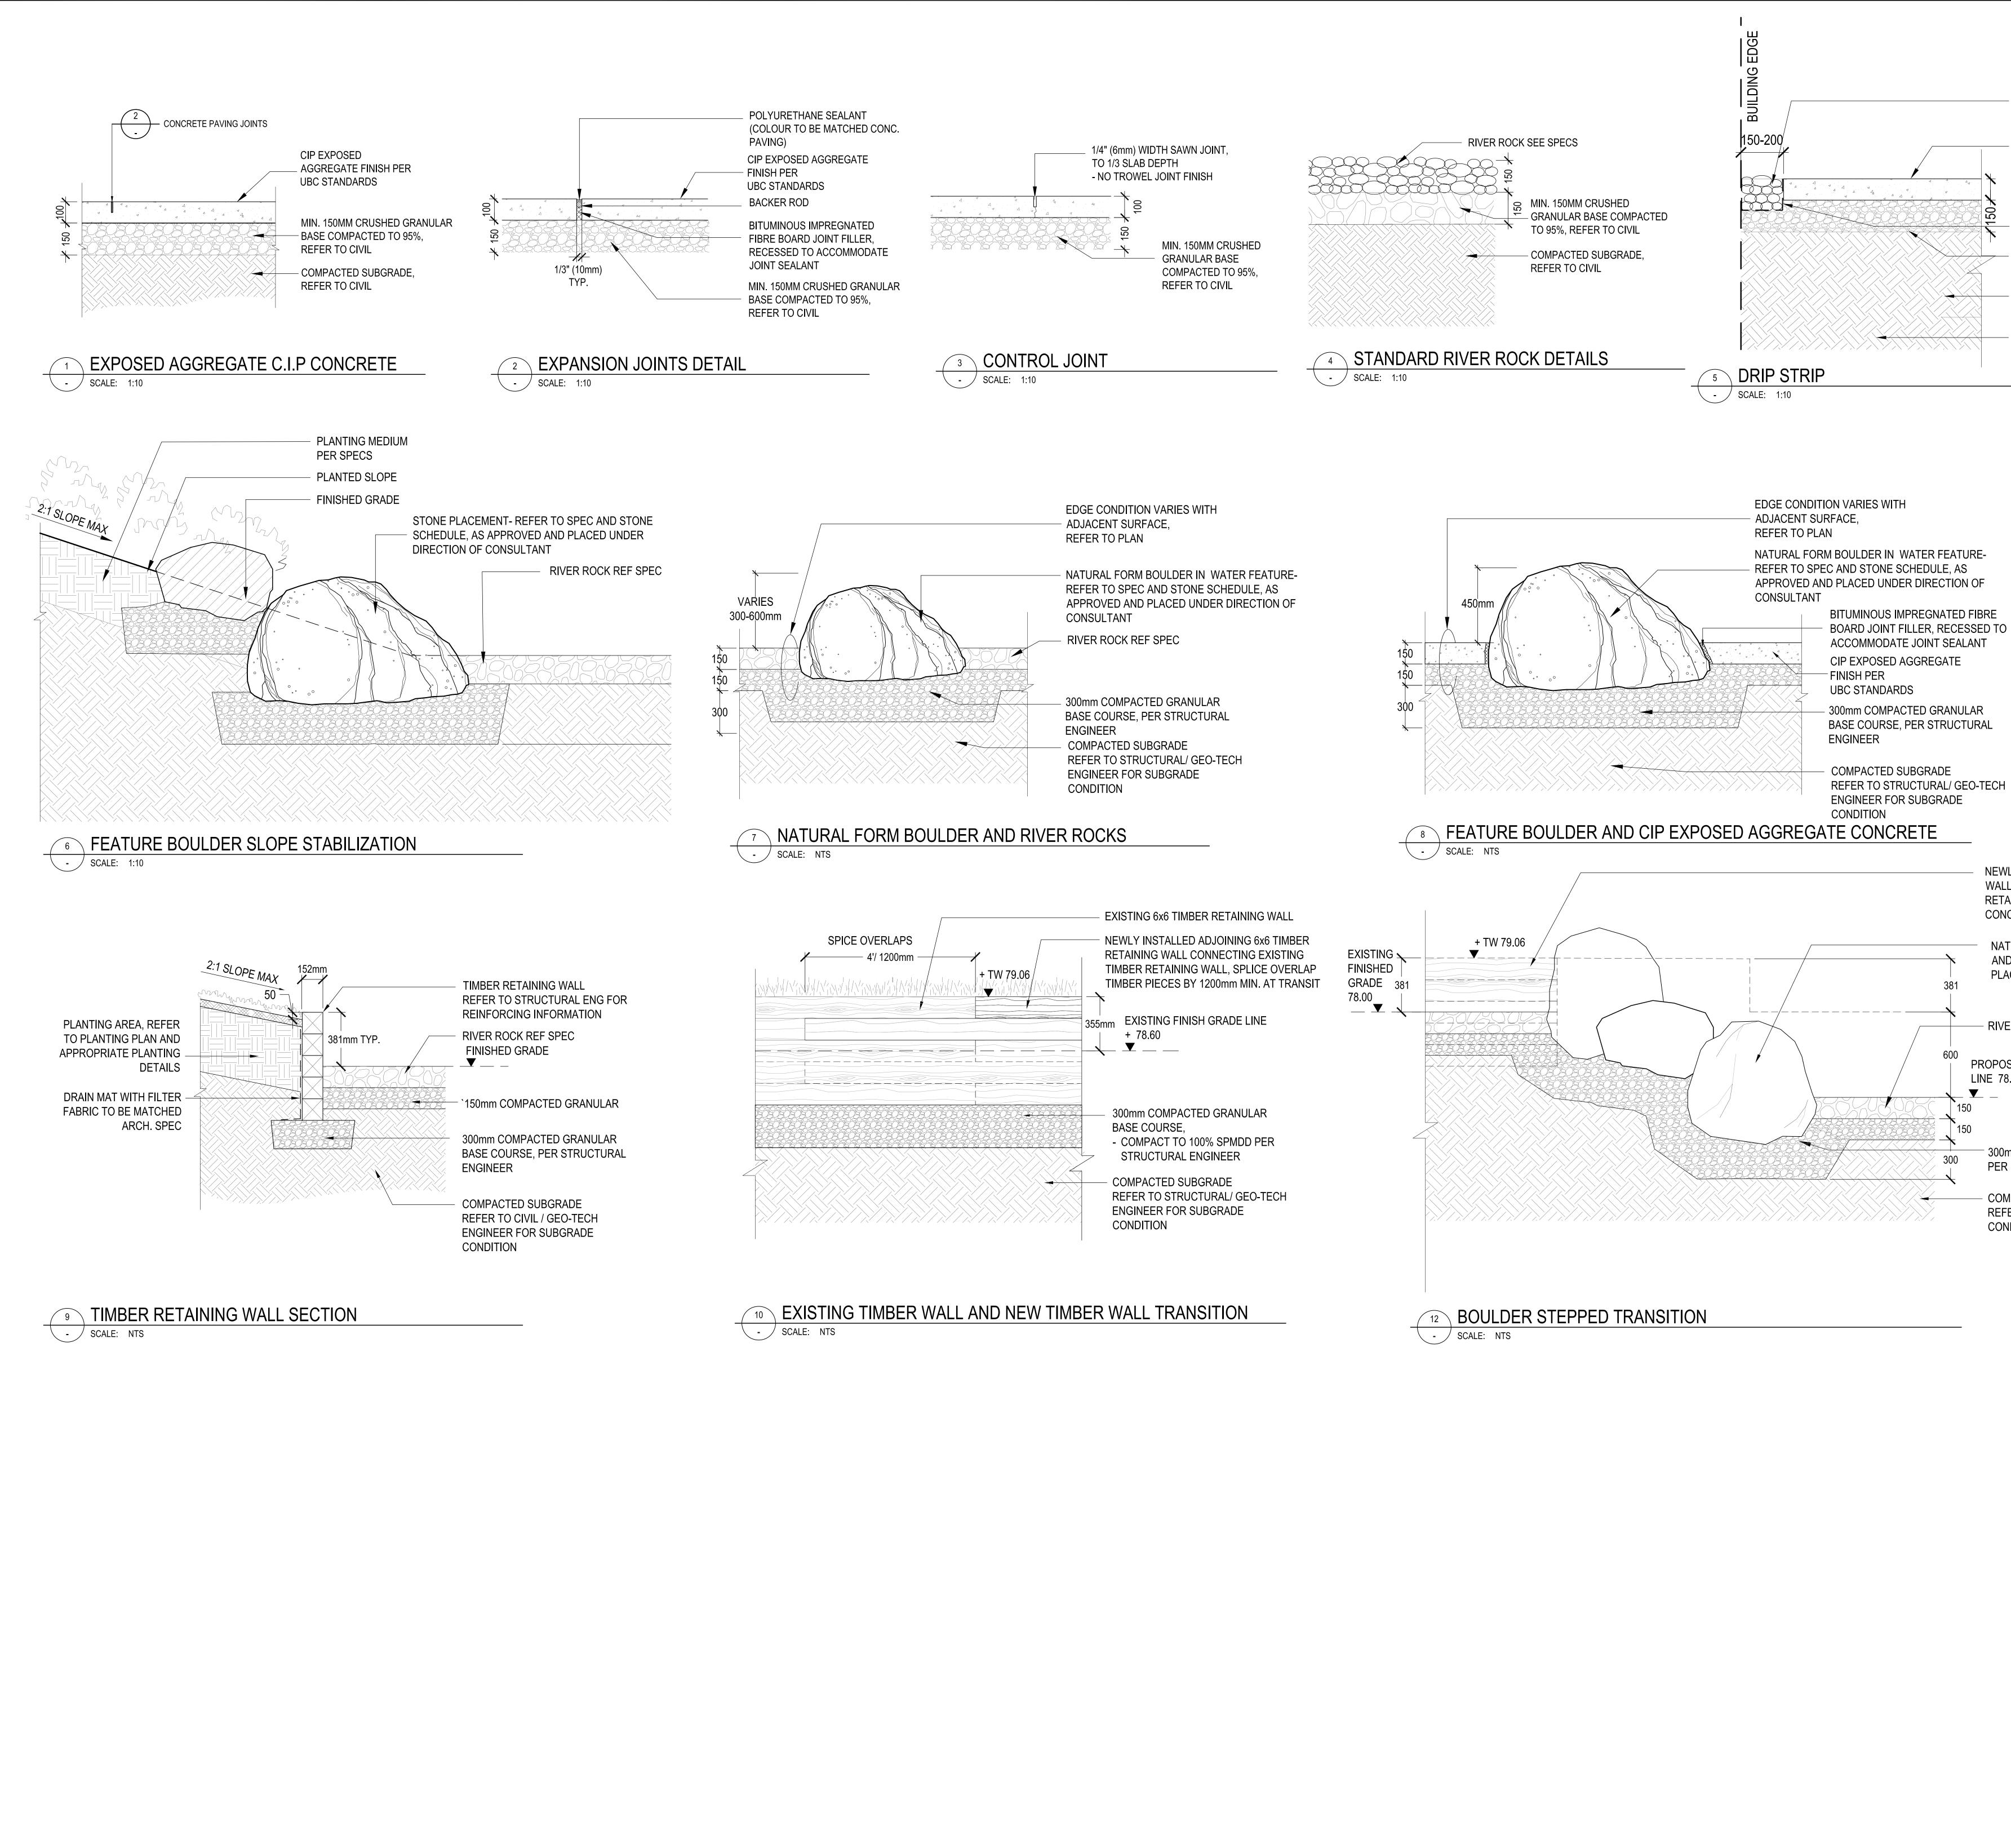
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PROJECT NAME: UBC, FIRST NATIONS HOUSE OF LEARNING EXPANSION DRAWING TITLE: LANDSCAPE PLANTING DETAILS PFS PROJECT NUMBER: DATE: 12/23/2020 20040 CHECKED BY:

CM/CP

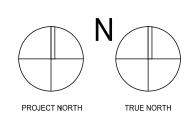DRAWN BY: SCALE: AS SHOWN

DWG. NO.: L3.0



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RIVER ROCK STRIP ALONG **BUILDING EDGE** SEE SPECS

CIP EXPOSED AGGREGATE FINISH PER UBC STANDARDS

GEO TEXTILE, SEE SPECS 150mm COMPACTED GRANULAR BASE COURSE, - COMPACT TO 100% SPMDD **GROWING MEDIUM** -REFER TO DETAILS

COMPACTED COMPETENT NATIVE SUBGRADE, WITH APPROVED ENGINEERED FILL AS REQUIRED, REFER TO GEOTECH

NEWLY INSTALLED 6x6 TIMBER RETAINING WALL CONNECTING TO EXISTING TIMBER RETAINING WALL, TERMINAL END CONCEALED BY BOULDER

NATURAL FORM BOULDER - REFER TO SPEC AND STONE SCHEDULE, AS APPROVED AND PLACED UNDER DIRECTION OF CONSULTANT

- RIVER ROCK REF SPEC

PROPOSED FINISH GRADE LINE 78.00

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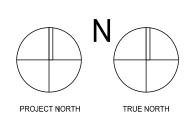
⁻ 300mm COMPACTED GRANULAR BASE COURSE, PER STRUCTURAL ENGINEER

- COMPACTED SUBGRADE

REFER TO CIVIL / GEO-TECH ENGINEER FOR SUBGRADE CONDITION

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3	2021.04.08	ISSUED FOR DRAFT 90% COORDINATION	СМ
4	2021.04.26	ISSUED FOR DEVELOPMENT PERMIT	СМ



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PROJECT NAME: UBC, FIRST NATIONS LONGHOUSE EXPANSION		
DRAWING TITLE: LANDSCAPE DETAILS		
PFS PROJECT NUMBER: 20040	DATE: 12/23/2020	
DRAWN BY: JL	CHECKED BY: CM/CP	
00.U =		

SCALE: AS SHOWN

